




PLOT PLAN SCALE 1" = 50'-0"

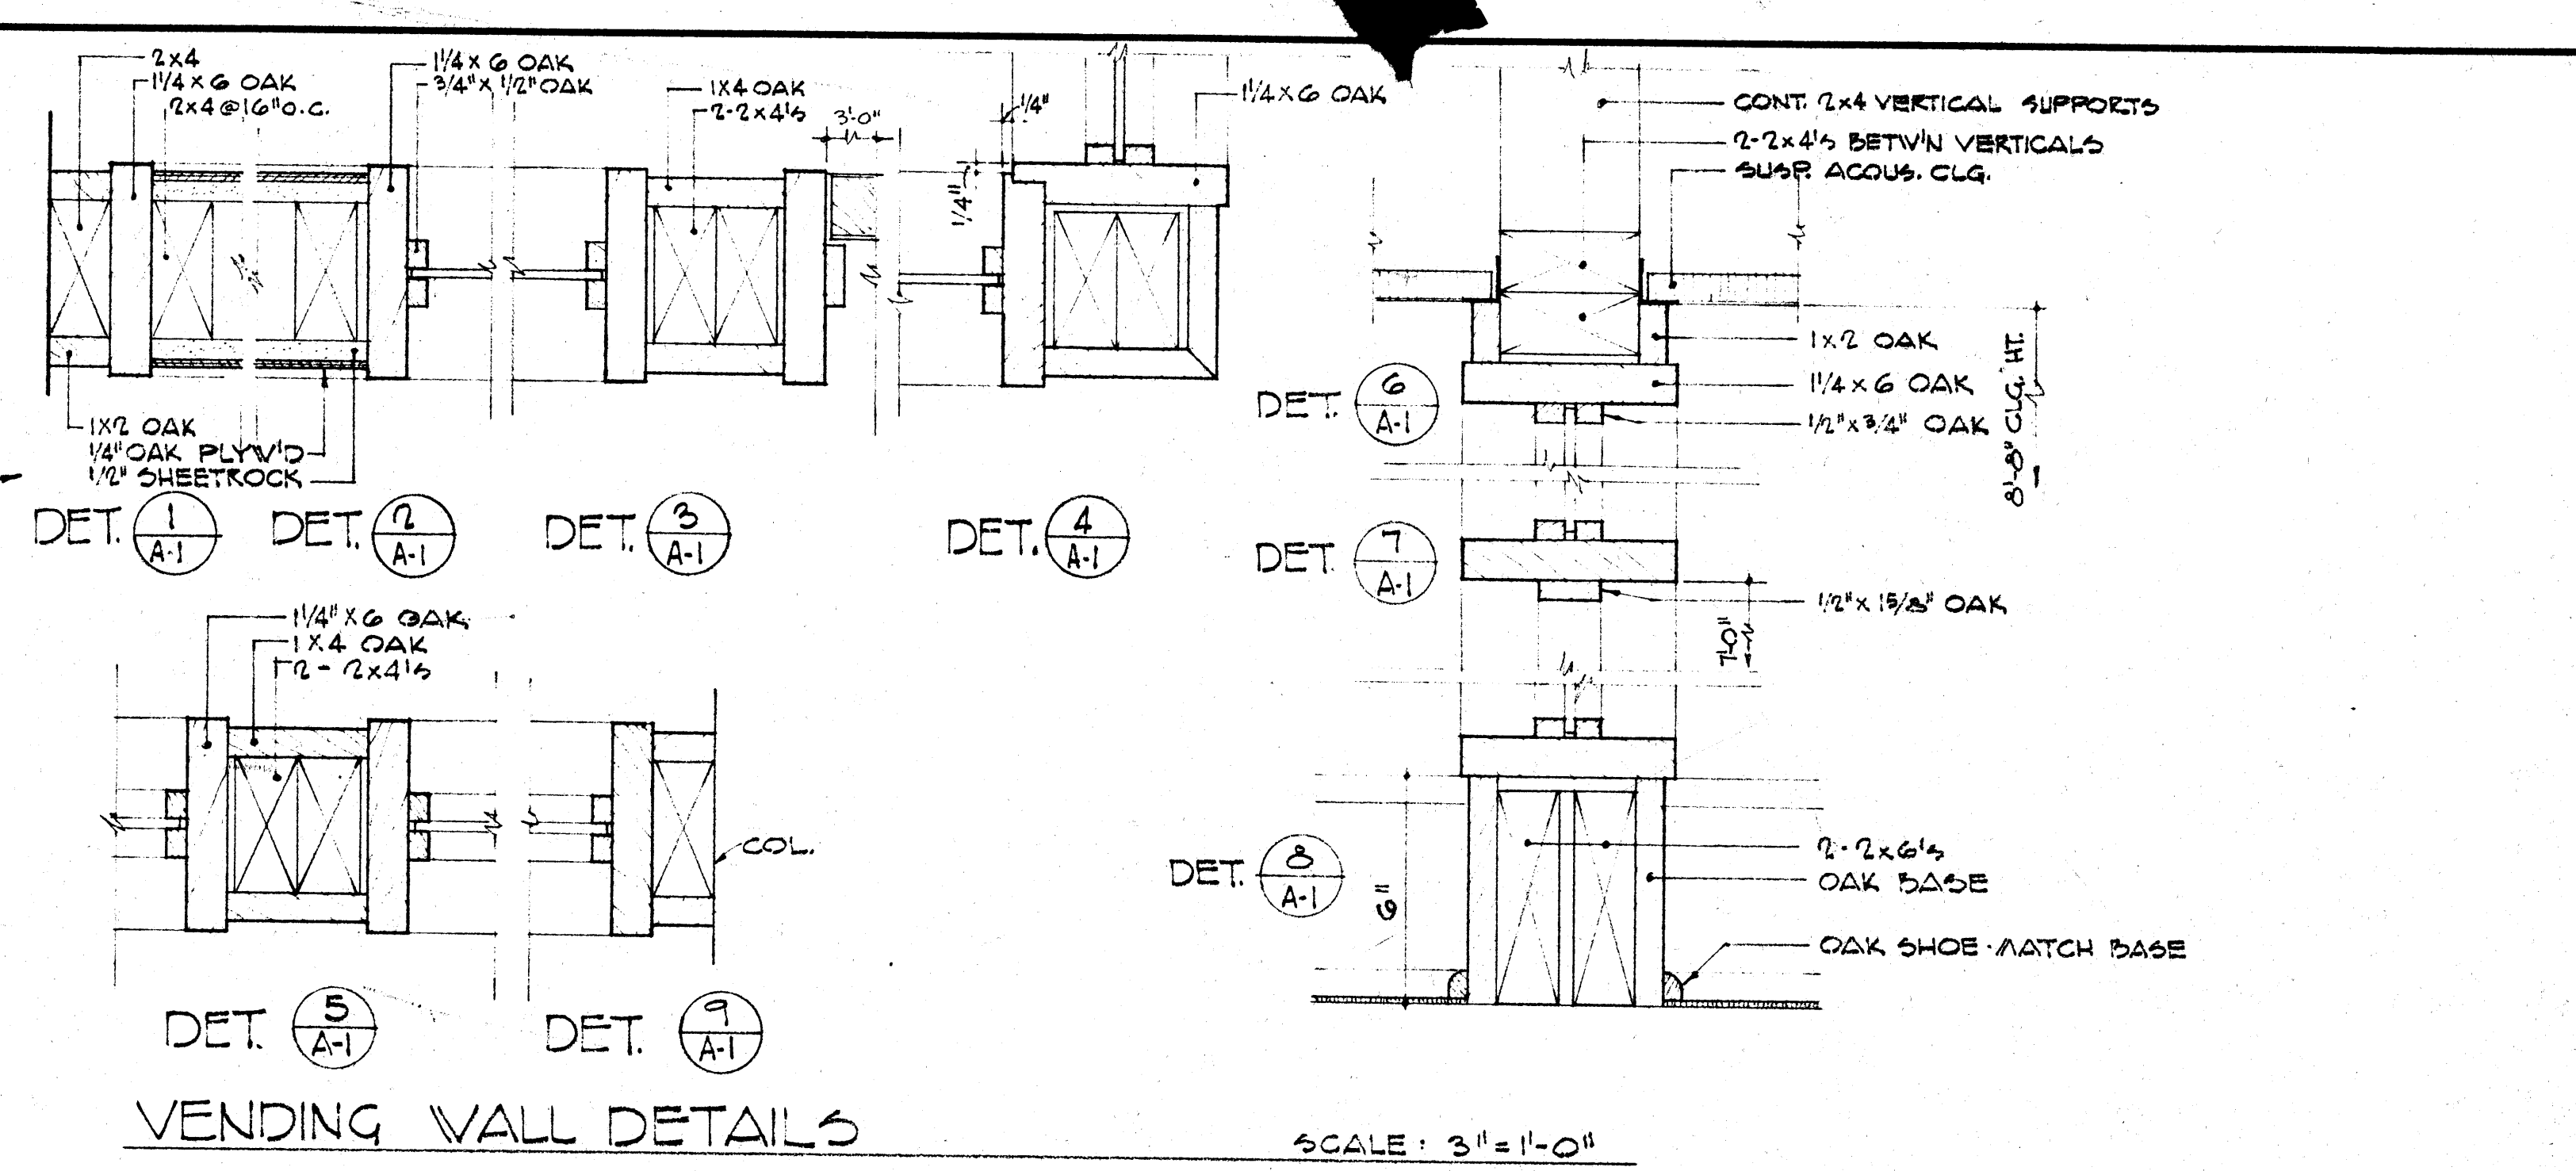


VENDING WALL DETAILS SCALE: 3" = 1'-0"

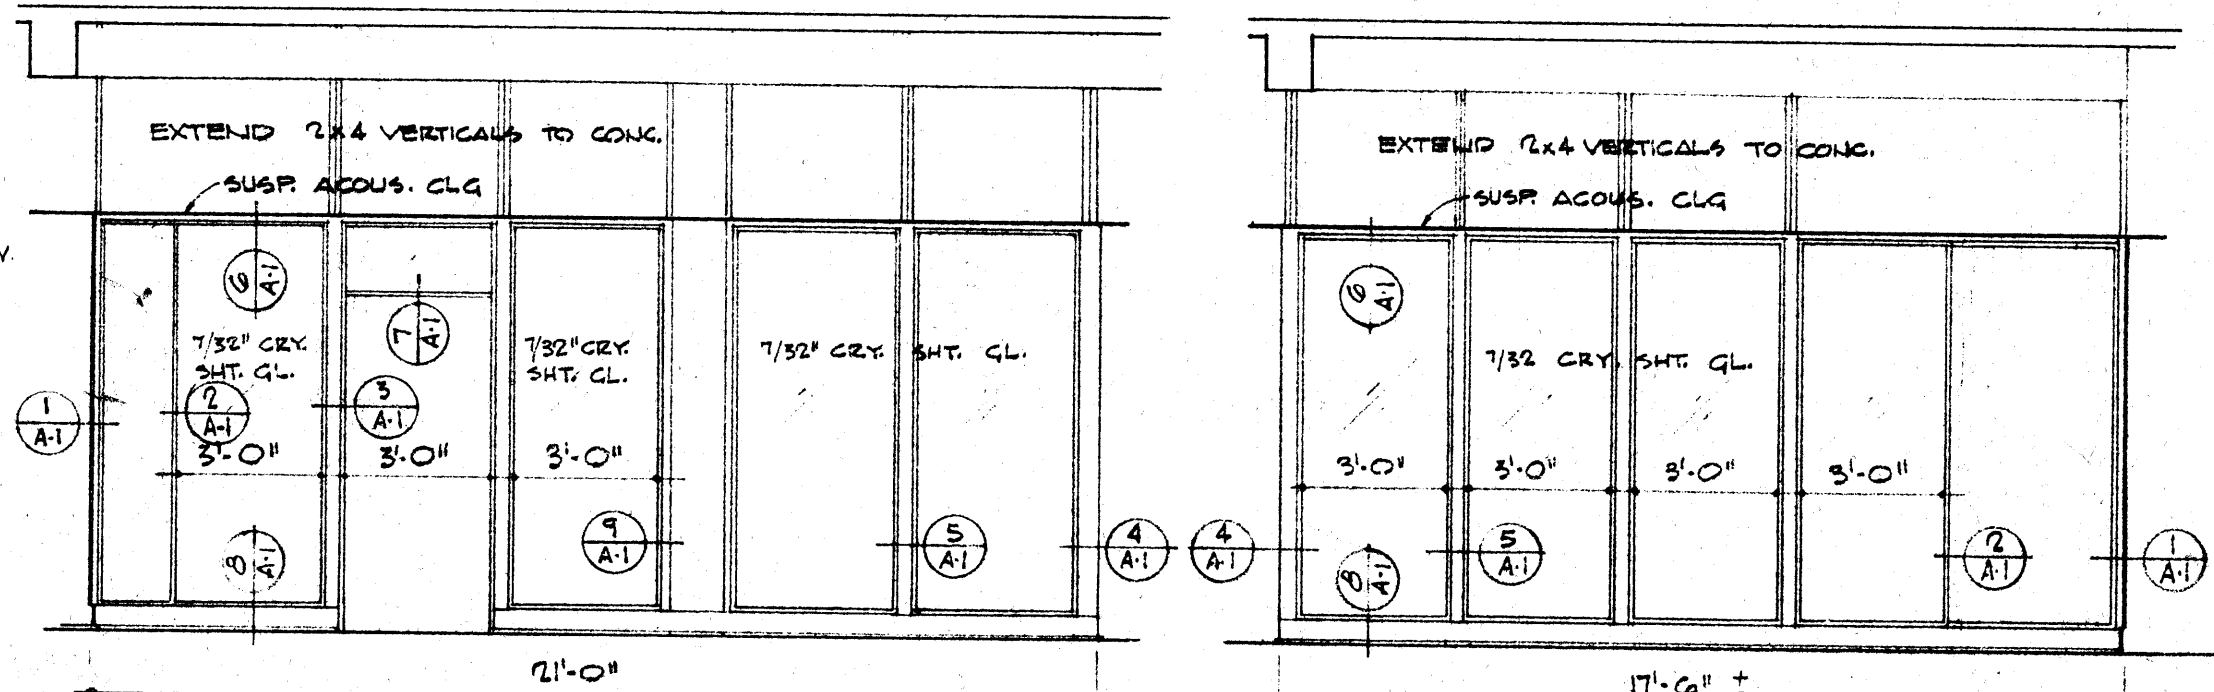


NORTH WALL VENDING ROOM ELEVATIONS (AREA 125) WEST WALL SCALE: 1/4" = 1'-0"

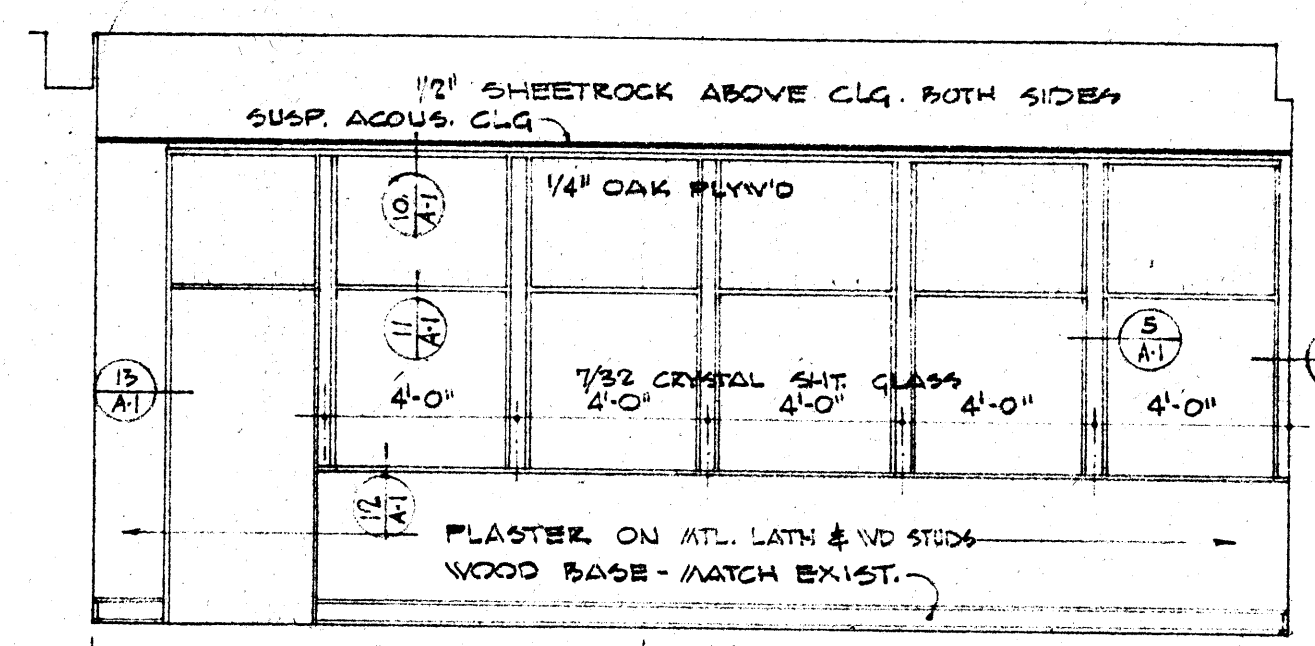


ELEVATION - SOUTH WALL AREA 217A SCALE: 1/4" = 1'-0"

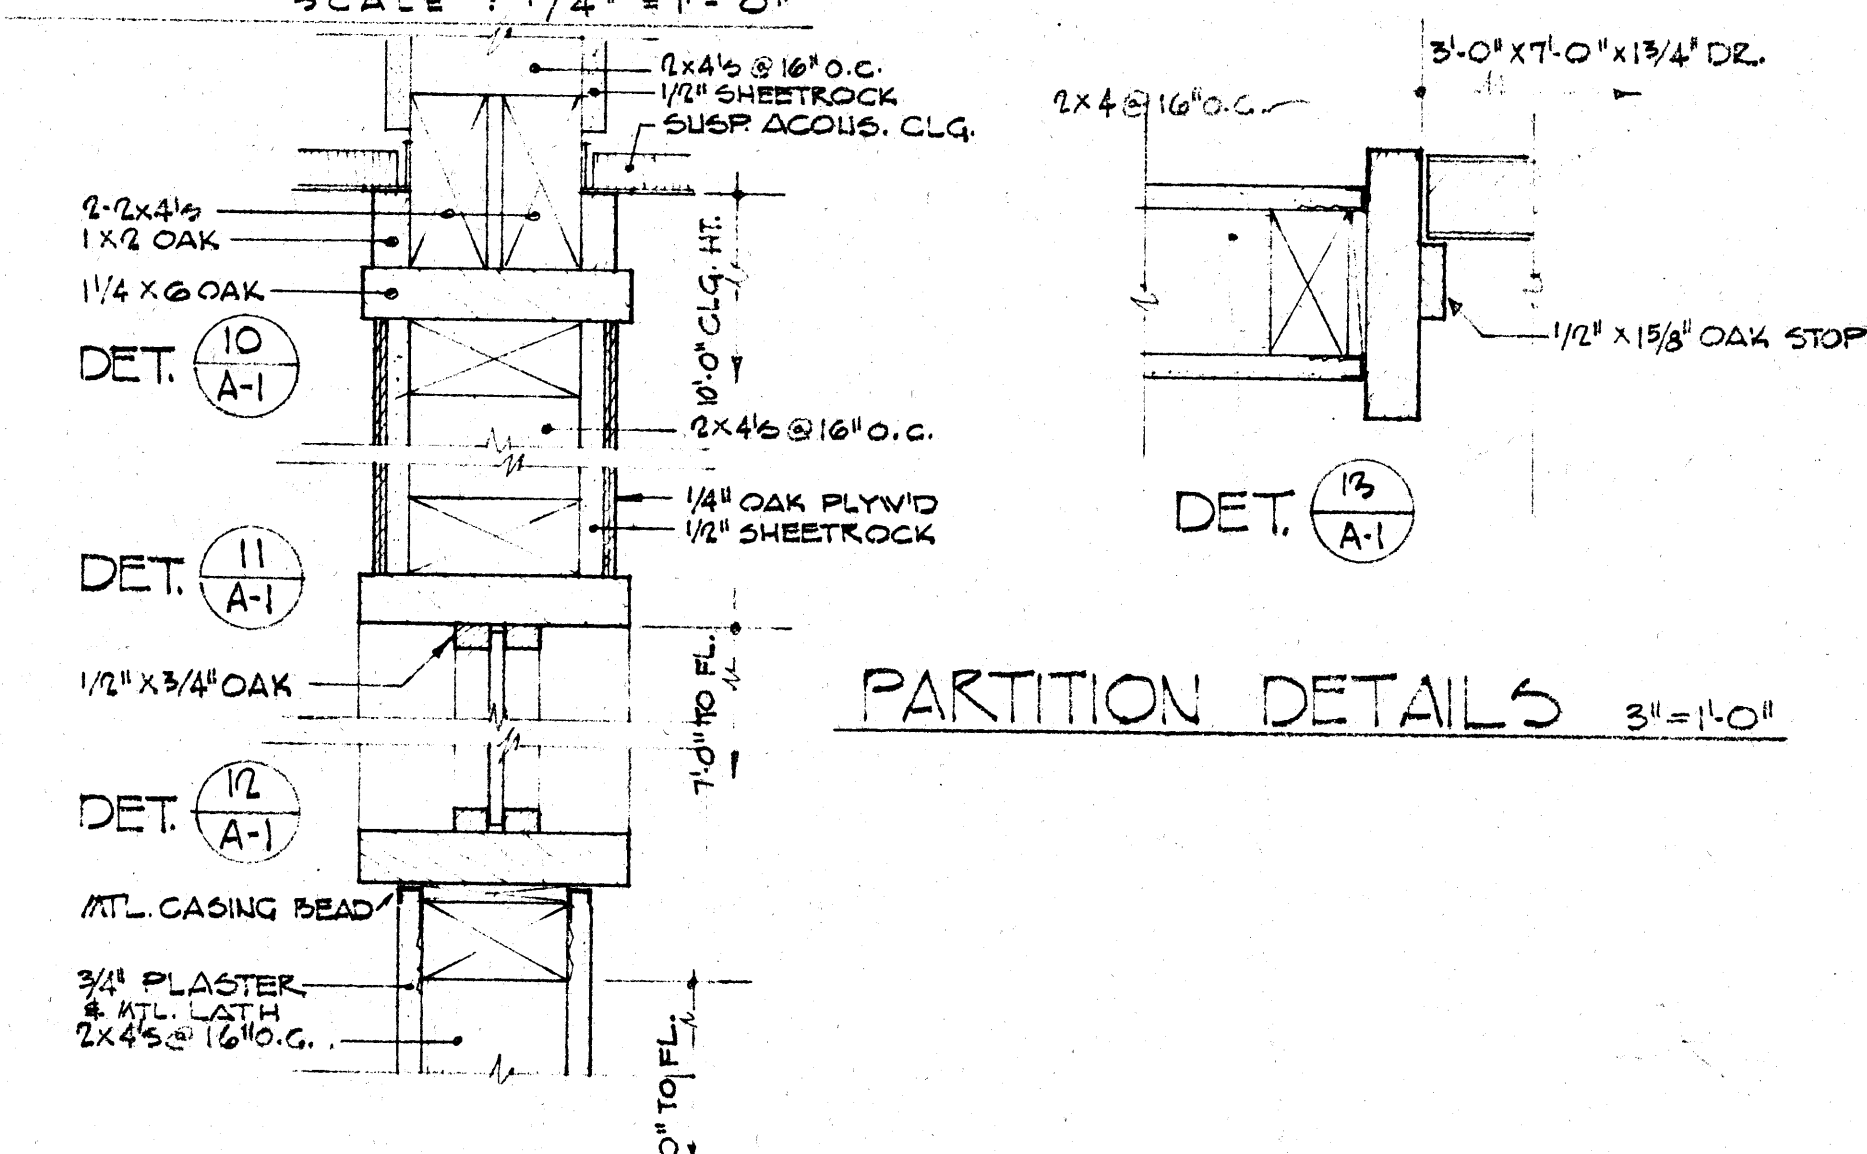


PARTITION DETAILS SCALE: 3" = 1'-0"

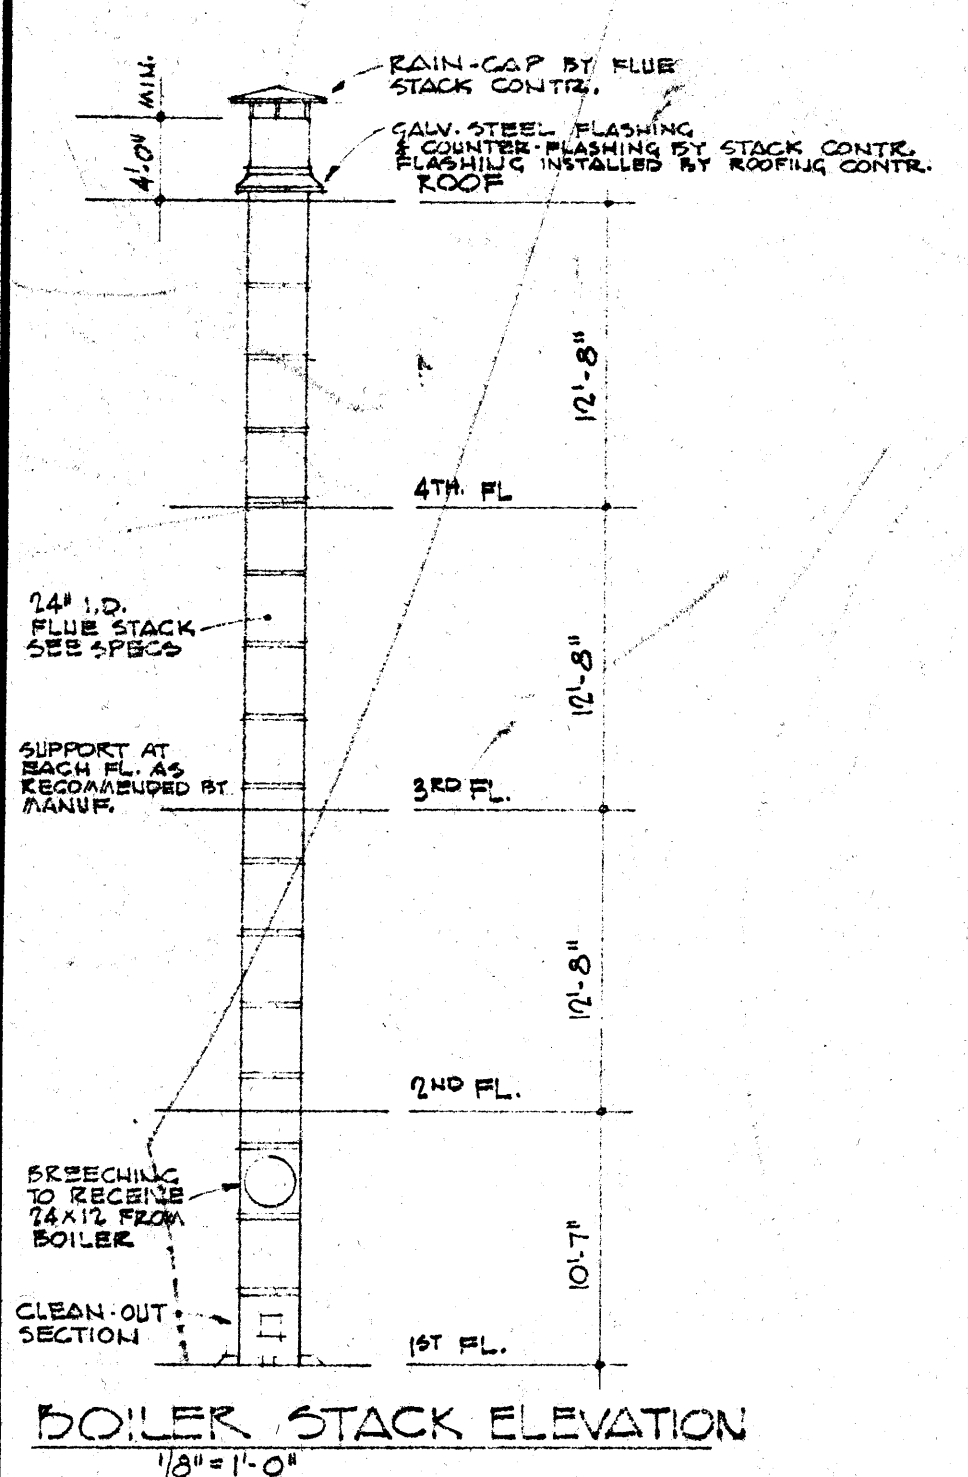


BOILER STACK ELEVATION SCALE: 1/8" = 1'-0"

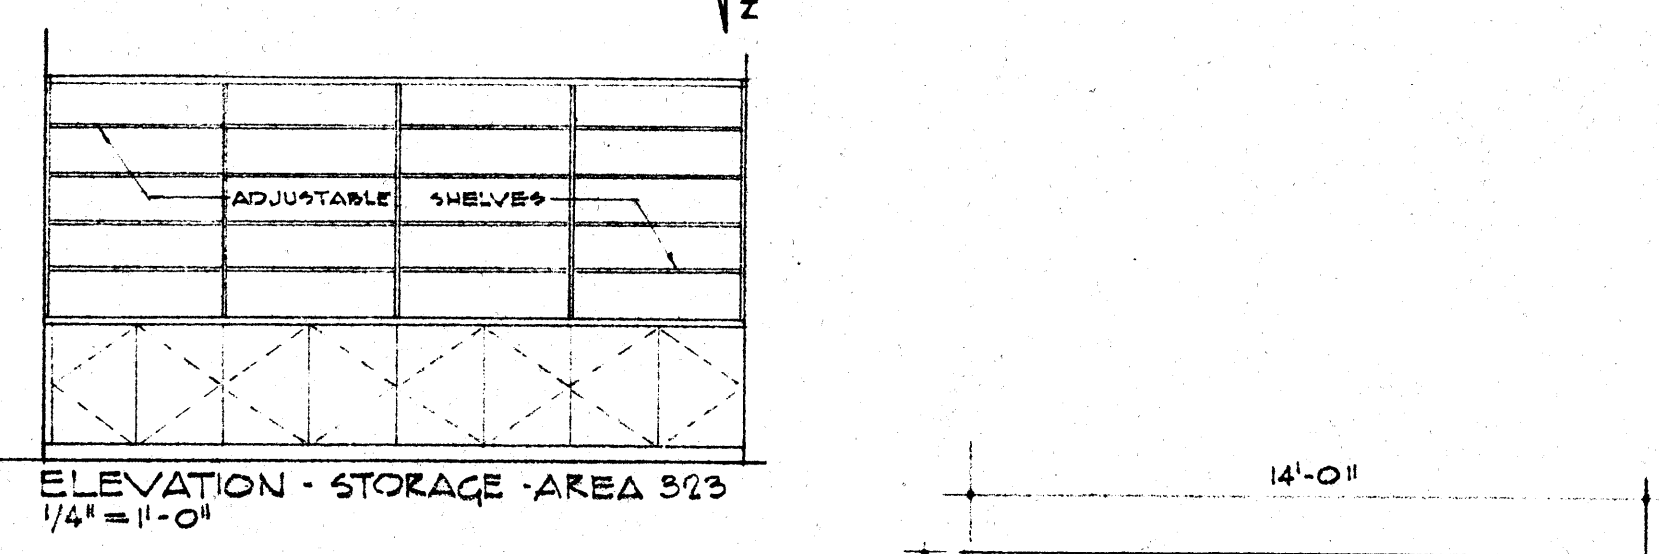

ELEVATION - STORAGE AREA 323 SCALE: 1/4" = 1'-0"

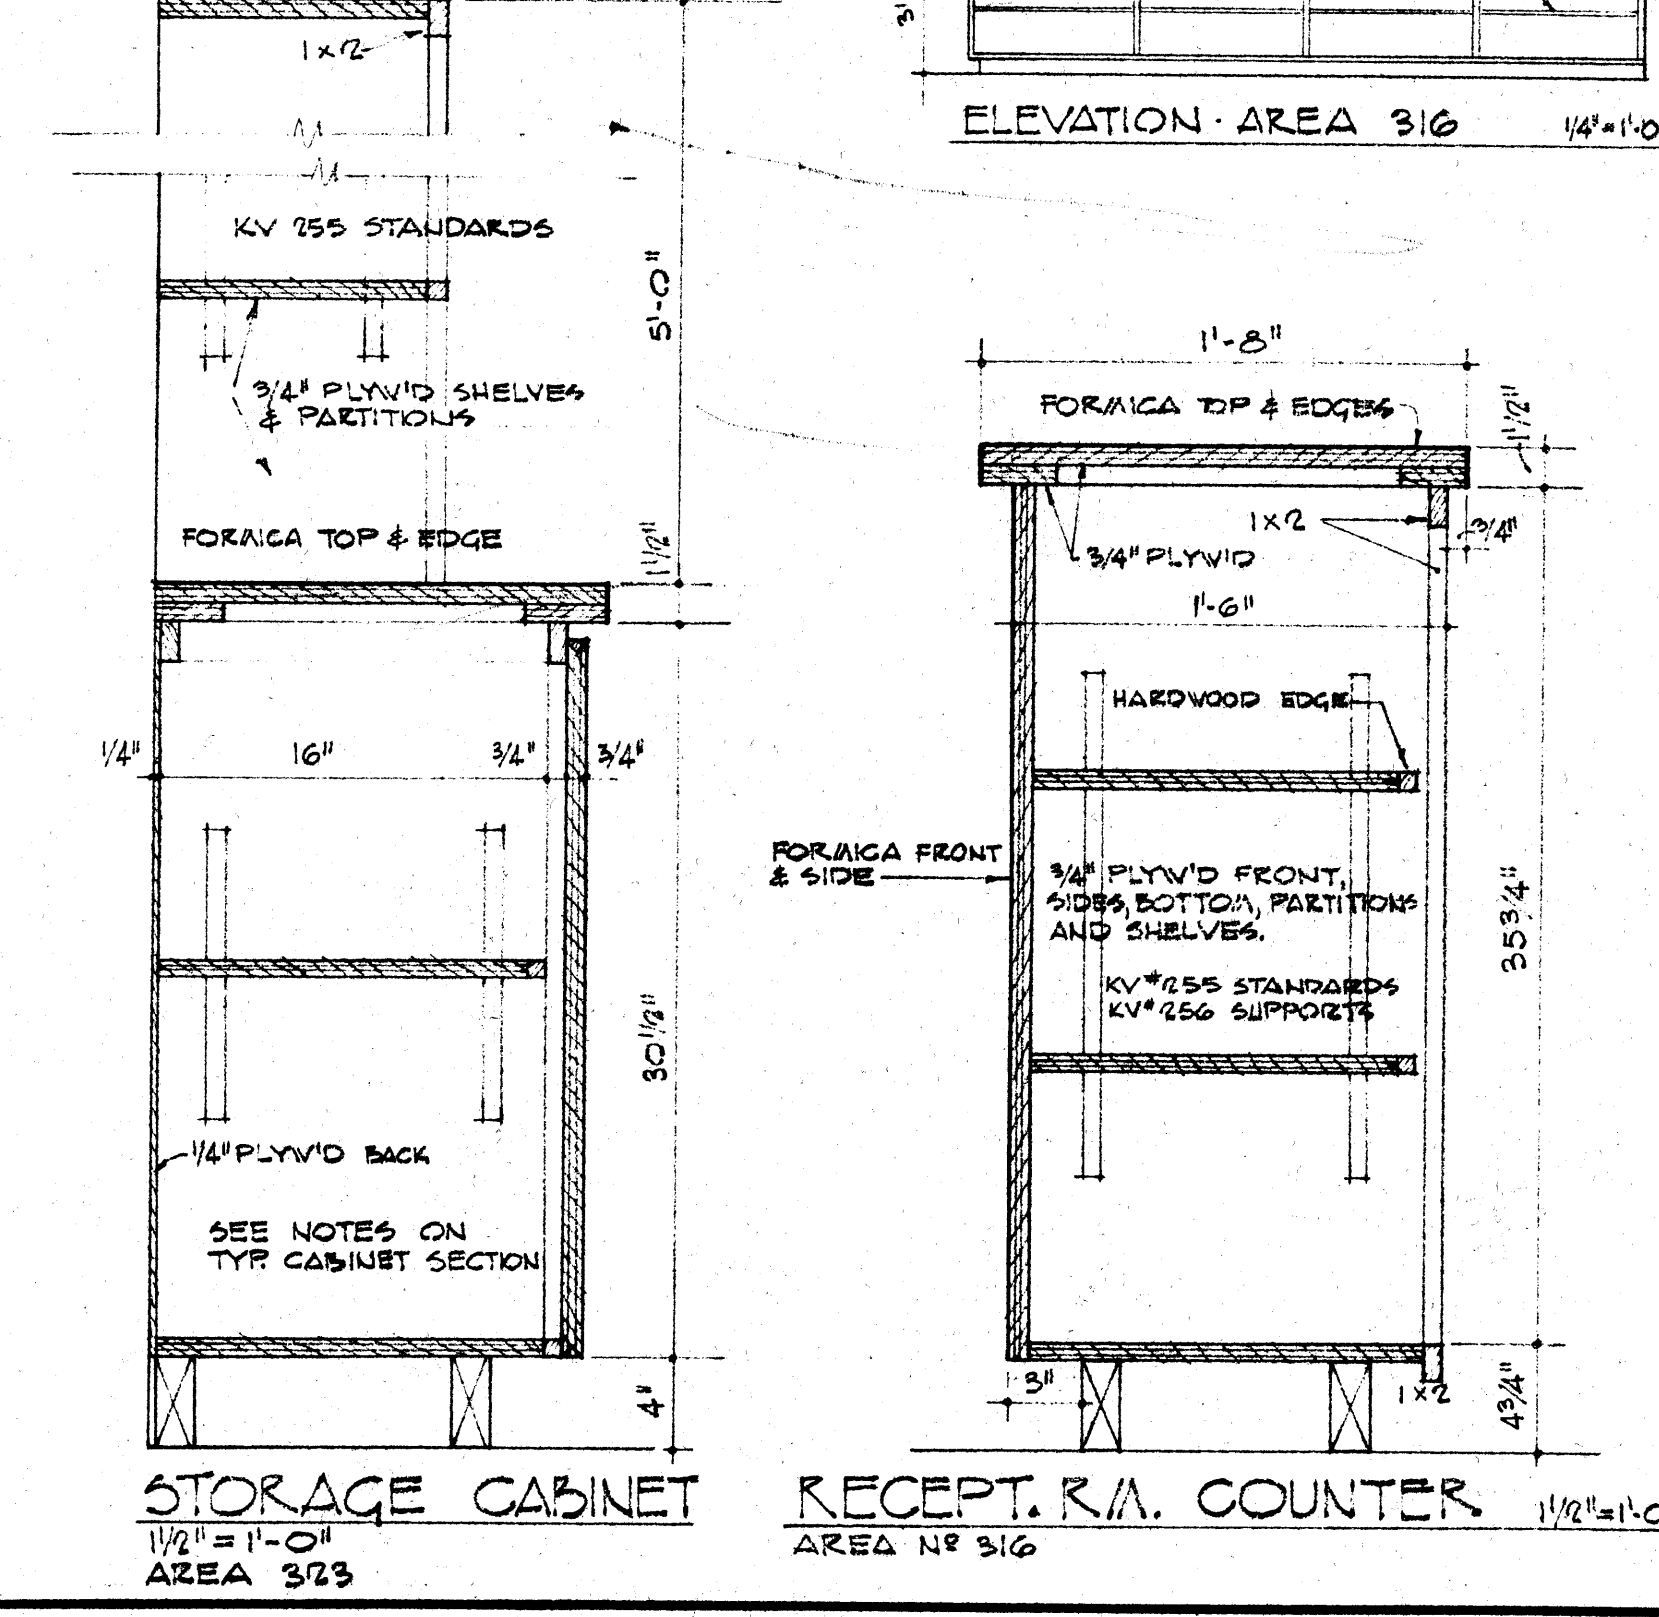

STORAGE CABINET SCALE: 1/2" = 1'-0" AREA 323 RECEPT. R/A. COUNTER SCALE: 1/2" = 1'-0" AREA NO 316

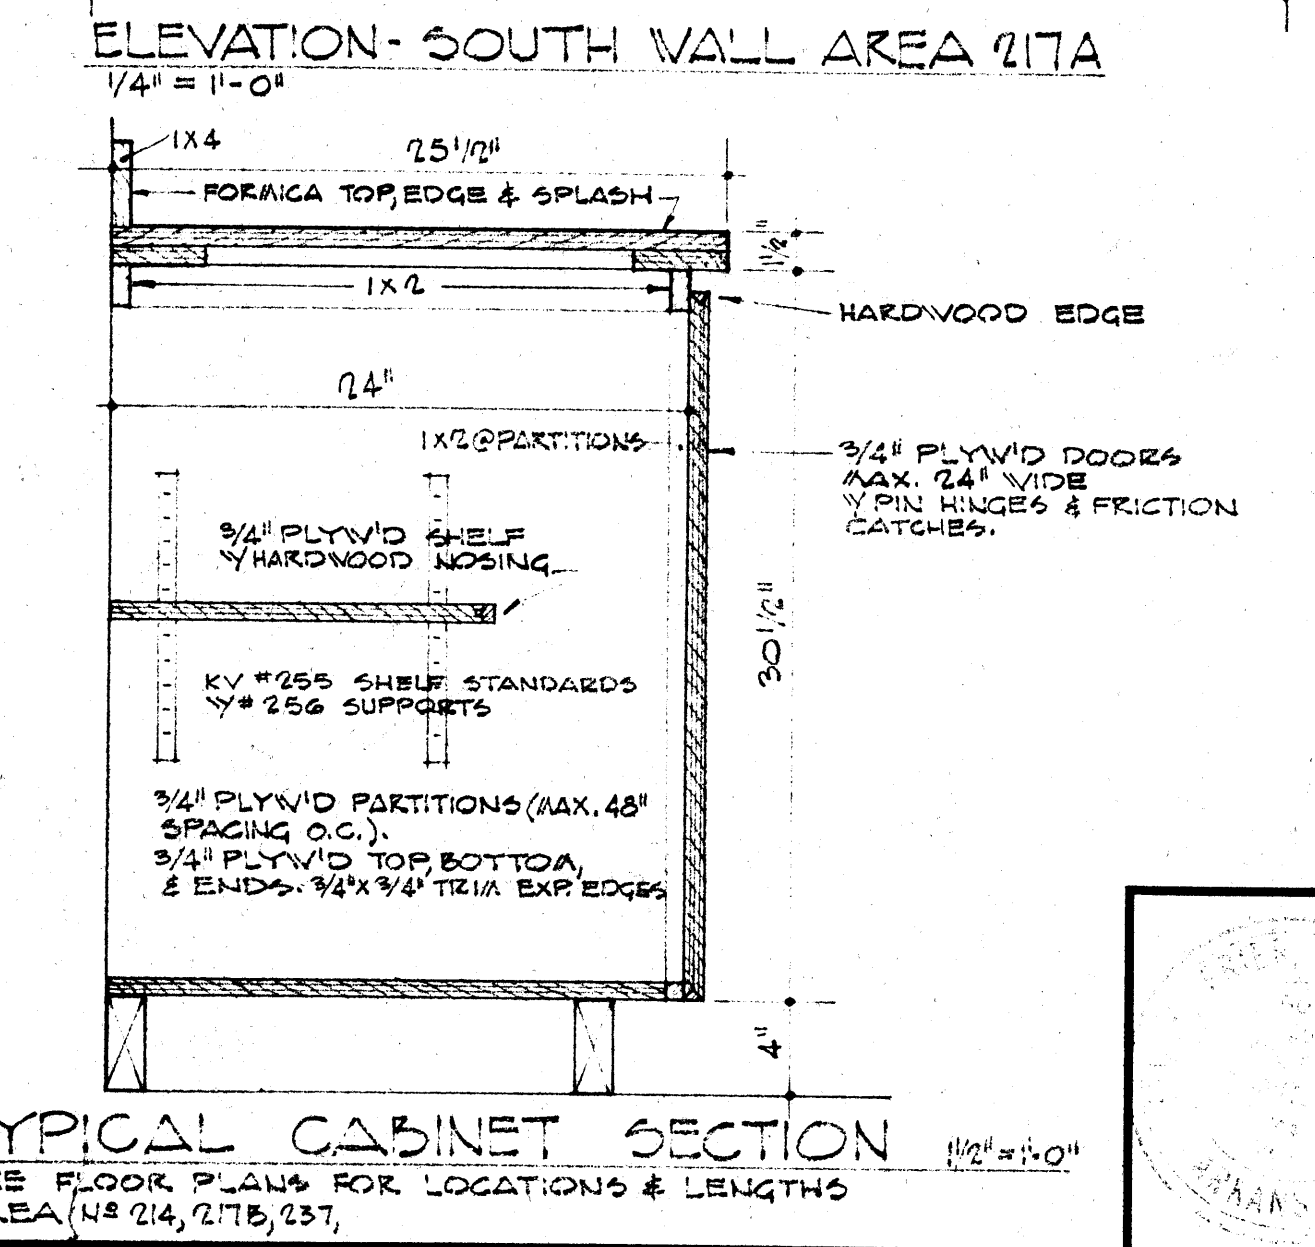

TYPICAL CABINET SECTION SCALE: 1/2" = 1'-0" SEE FLOOR PLANS FOR LOCATIONS & LENGTHS AREA (NO 214, 217B, 231)

	DATE	2-21-66	RENOVATIONS TO WILSON HALL ARKANSAS STATE COLLEGE JONESBORO, ARKANSAS	SHEET NUMBER	A-1		
	DRAWN BY	JDM, HRE		STUCK, FRIER, LANE & SCOTT, INC., ARCHITECTS 601 SOUTHWEST DRIVE • JONESBORO, ARKANSAS		COMMISSION NUMBER	45566
	CHECKED BY						
	REVISIONS						

INTERIOR FINISH SCHEDULE - FIRST FLOOR										INTERIOR FINISH SCHEDULE - SECOND FLOOR										INTERIOR FINISH SCHEDULE - THIRD FLOOR										INTERIOR FINISH SCHEDULE - FOURTH FLOOR													
AREA	FLR.	BASE	WAINS.	WALLS				CLG.	CLG. HT.	REMARKS	AREA	FLR.	BASE	WAINS.	WALLS				CLG.	CLG. HT.	REMARKS	AREA	FLR.	BASE	WAINS.	WALLS				CLG.	CLG. HT.	REMARKS	AREA	FLR.	BASE	WAINS.	WALLS				CLG.	CLG. HT.	REMARKS
				NORTH	EAST	SOUTH	WEST								NORTH	EAST	SOUTH	WEST								NORTH	EAST	SOUTH	WEST								NORTH	EAST	SOUTH	WEST			
101	F-5	-	-	W-8	W-3	W-8	W-8	C-6	-		201	F-4	B-5	W-1	W-2	W-2	W-2	C-1	11'-0"	SEE ALUM. FRAME DETAILS SHT. N° A-11	301	F-1	B-2	-	W-2	W-2	W-142	W-2	C-1	8'-0"		401	F-1	B-244	-	W-2	W-2	W-142	W-2	C-1	8'-0"		
102	F-1	B-1	-	W-2	W-1	W-2	W-1	C-1	10'-0"		202	F-4	B-5	-	W-1	W-4	-	W-4	C-1	8'-0"	SEE DET. SHT. A-14	302	F-6	-	-	W-1	W-1	W-1	W-1	C-3	-	SEE DETAILS SHT. N° A-12	402	F-6	-	-	W-1	W-1	W-1	W-1	C-1	11'-0"	SEE DETAILS SHT. N° A-12
103	F-1	B-1	-	W-2	W-1	W-2	W-1	C-1	10'-0"		203	F-4	B-3	-	W-3	W-3	W-2	W-2	C-1	10'-0"		303	F-1	B-244	-	W-3	W-3	W-2	W-1	C-1	10'-0"		403	F-1	B-244	-	W-5	W-2	W-2	W-1	C-1	10'-0"	
104	F-1	B-1	-	W-2	W-1	W-1	W-1	C-1	10'-0"		204	F-4	B-3	-	W-3	W-2	W-2	W-2	C-1	10'-0"	PATCH FL., WALLS & BASE WHERE PART. REMOVED	304	F-1	B-244	-	W-3	W-1	W-2	W-1	C-1	10'-0"		404	F-1	B-244	-	W-5	W-1	W-2	W-2	C-1	10'-0"	
105	F-1	B-1	-	W-2	W-1	W-2	W-2	C-1	10'-0"		205	F-4	B-3	-	W-2	W-3	W-3	W-2	C-1	10'-0"		305	F-1	B-244	-	W-3	W-1	W-2	W-1	C-1	10'-0"		405	F-1	B-244	-	W-5	W-2	W-3	W-1	C-1	10'-0"	
106	F-6	B-1	-	W-1	W-1	W-1	W-1	C-3	-	SEE DETAILS SHT. N° A-12	206	F-4	B-143	-	W-1	W-2	W-2	W-2	C-1	10'-0"		306	F-1	B-244	-	W-3	W-1	W-3	W-1	C-1	10'-0"		406	F-1	B-244	-	W-5	W-1	W-2	W-1	C-1	10'-0"	
107	F-1	B-1	-	W-1	W-1	W-1	W-2	C-1	10'-0"		207	F-4	B-143	-	W-3	W-3	W-1	W-2	C-1	10'-0"		307	F-1	B-244	-	W-3	W-1	W-2	W-1	C-1	10'-0"		407	F-1	B-244	-	W-5	W-1	W-2	W-1	C-1	10'-0"	
108	F-1	B-1	-	W-1	W-1	W-1	W-2	C-1	10'-0"		208	F-4	B-3	-	W-3	W-3	W-3	W-3	C-2	-		308	F-1	B-244	-	W-3	W-1	W-2	W-1	C-1	10'-0"		408	F-1	B-244	-	W-5	W-1	W-2	W-1	C-1	10'-0"	
109	F-1	B-1	-	W-1	W-1	W-1	W-2	C-1	10'-0"		209	F-4	B-3	-	W-3	W-3	W-3	W-3	C-2	-		309	F-1	B-244	-	W-3	W-1	W-2	W-1	C-1	10'-0"		409	F-1	B-244	-	W-5	W-1	W-2	W-2	C-1	10'-0"	
110	F-1	B-1	-	W-1	W-1	W-1	W-2	C-1	10'-0"		210	F-4	B-3	-	W-3	W-3	W-3	W-3	C-2	-		310	F-1	B-244	-	W-3	W-1	W-2	W-1	C-1	10'-0"		410	F-1	B-244	-	W-5	W-1	W-3	W-3	C-1	10'-0"	
111	F-1	B-1	-	W-1	W-1	W-1	W-2	C-1	10'-0"		211	F-4	B-3	-	W-3	W-3	W-3	W-3	C-2	-		311	F-1	B-244	-	W-3	W-1	W-2	W-1	C-1	10'-0"		411	F-1	B-244	-	W-5	W-1	W-3	W-3	C-1	10'-0"	
112	F-1	B-1	-	W-1	W-2	W-1	W-2	C-1	10'-0"		212	F-4	B-3	-	W-3	W-3	-	W-2	C-1	8'-0"		312	F-1	B-244	-	W-3	W-1	W-2	W-1	C-1	10'-0"		412	F-6	-	-	W-1	W-1	W-1	W-1	C-1	11'-0"	SEE DETAILS SHT. N° A-12
113	F-1	B-1	-	W-1	W-1	W-2	W-2	C-1	10'-0"		213	F-1	B-4	-	W-2	W-142	W-3	W-2	C-1	10'-0"	REMOVE EXISTING TERRAZZO BASE	313	F-1	B-244	-	W-3	W-1	W-2	W-1	C-1	10'-0"		413	F-1	B-244	-	W-1	W-2	W-1	W-2	C-1	10'-0"	
114	F-1	B-1	-	W-1	W-1	W-2	W-1	C-1	10'-0"		214	F-1	B-7	-	W-3	W-2	W-2	W-2	C-1	10'-0"		314	F-1	B-244	-	W-1	W-1	W-2	W-1	C-1	10'-0"		414	F-1	B-244	-	W-1	W-2	W-1	W-2	C-1	10'-0"	
115	F-1	B-1	-	W-1	W-1	W-2	W-1	C-1	10'-0"		215	F-6	-	W-1	W-1	W-1	W-1	C-3	-	SEE DETAILS SHT. N° A-12	315	F-1	B-244	-	W-2	W-1	W-1	W-1	C-1	10'-0"		415	F-1	B-244	-	W-1	W-2	W-2	W-3	C-1	10'-0"		
116	F-1	B-1	-	W-1	W-2	W-2	W-1	C-1	10'-0"		216	F-3	B-244	-	W-1	W-1	W-1	W-1	C-1	10'-0"		316	F-1	B-244	-	W-1	W-2	W-1	W-2	C-1	10'-0"		416	F-6	-	-	W-1	W-1	W-1	W-1	C-1	11'-0"	SEE DETAILS SHT. N° A-12
117	F-1	B-1	-	W-1	W-1	W-1	W-1	C-1	8'-0"		217	F-3	B-244	-	W-1	W-2	W-1	W-2	C-1	10'-0"		317	F-1	B-244	-	W-2	W-142	W-1	W-3	C-1	10'-0"		417	F-1	B-244	-	W-3	W-2	W-3	W-2	C-1	8'-0"	
118	F-1	B-1	-	W-1	W-2	W-1	W-1	C-1	10'-0"		218	F-3	B-244	-	W-2	W-2	W-2	W-3	C-1	10'-0"		318	F-1	B-244	-	W-3	W-3	W-1	W-3	C-1	10'-0"		418	F-4	B-3	W-5-1	W-3	W-3	W-3	W-2	C-1	10'-0"	
119	F-1	B-1	-	W-1	W-2	W-1	W-1	C-1	10'-0"		219	F-6	-	W-1	W-1	W-1	W-1	C-3	-	SEE DETAILS SHT. N° A-12	319	F-1	B-244	-	W-3	W-1	W-1	W-1	C-1	10'-0"		419	F-1	B-244	-	W-3	W-2	W-3	W-2	C-1	10'-0"		
120	F-1	B-1	-	W-1	W-2	W-1	W-1	C-1	10'-0"		220	F-1	B-244	-	W-1	W-3	W-3	W-3	C-1	8'-0"		320	F-1	B-4	-	W-1	W-1	W-1	W-1	C-1	10'-0"		420	F-1	B-244	-	W-3	W-2	W-1	W-2	C-1	8'-0"	
121	F-1	B-1	-	W-1	W-2	W-1	W-1	C-1	10'-0"		221	F-4	B-3	-	W-3	W-3	W-3	W-3	C-2	-		321	F-1	B-442	-	W-1	W-2	W-3	W-1	C-1	10'-0"		421	F-2	B-1	-	W-1	W-1	W-1	W-1	C-1	10'-0"	
122	F-1	B-1	-	W-1	W-2	W-1	W-1	C-1	10'-0"		222	F-4	B-3	-	W-3	W-3	W-3	W-3	C-1	10'-0"		322	F-1	B-244	-	W-1	W-1	W-3	W-1	C-1	10'-0"		422	F-5	-	-	W-247	W-2	W-2	W-2	C-2	-	
123	F-1	B-1	-	W-1	W-2	W-1	W-1	C-1	10'-0"		223	F-1	B-244	-	W-3	W-2	W-1	W-3	C-1	10'-0"		323	F-1	B-244	-	W-3	W-1	W-2	W-1	C-1	10'-0"		423	F-1	B-244	-	W-2	W-1	W-1	W-3	C-1	10'-0"	
124	F-1	B-1	-	W-142	W-1	W-142	W-1	C-1	8'-0"		224	F-448	B-347	-	W-3	W-143	W-2	W-2	C-1	8'-0"		324	F-6	-	-	W-1	W-1	W-1	W-1	C-3	-	SEE DETAILS SHT. N° A-12	424	F-1	B-244	-	W-2	W-1	W-1	W-1	C-1	10'-0"	
125	F-1	B-1	-	W-1	W-2	W-2	W-1	C-1	8'-0"		225	F-5	-	-	W-247	W-2	W-2	W-2	C-2	-		325	F-1	B-244	-	W-1	W-2	W-1	W-2	C-1	10'-0"		425	F-1	B-244	-	W-2	W-1	W-1	W-1	C-1	10'-0"	
126	F-1	B-1	-	W-142	W-1	W-2	W-1	C-1	8'-0"		226	F-1	B-1	-	W-1	W-1	W-1	W-1	C-2	-		326	F-1	B-244	-	W-1	W-2	W-2	W-2	C-1	10'-0"		426	F-1	B-244	-	W-2	W-1	W-1	W-1	C-1	10'-0"	
127	F-6	B-1	-	W-1	W-1	W-1	W-1	C-3	-	SEE DETAILS SHT. N° A-12	227	F-4	B-5	-	W-4	W-4	W-4	-	C-1	8'-0"		327	F-1	B-2	-	W-2	W-3	W-5	W-3	C-1	10'-0"		427	F-1	B-244	-	W-2	W-1	W-1	W-1	C-1	10'-0"	
128	F-5	-	-	W-2	W-2	W-2	W-2	C-7	-		228	F-5	-	-	W-247	W-2	W-2	W-2	C-2	-		328	F-6	-	-	W-1	W-1	W-1	W-1	C-3	-	SEE DETAILS SHT. N° A-12	428	F-1	B-244	-	W-2	W-2	W-2	W-2	C-2	-	
129	F-6	B-1	-	W-1	W-1	W-1	W-1	C-3	-	SEE DETAILS SHT. N° A-12	229	F-4	B-3	-	W-2	W-2	W-2	W-2	C-1	8'-0"		329	F-1	B-244	-	W-142	W-142	W-142	W-142	C-1	10'-0"		429	F-5	-	-	W-247	W-2	W-2	W-2	C-2	-	
130	F-3	B-1	-	W-142	W-2	W-2	W-1	C-1	9'-0"		230	F-6	-	-	W-1	W-1	W-1	W-1	C-3	-	SEE DETAILS SHT. N° A-12	330	F-7	B-6	-	W-6	W-6	W-6	W-6	C-5	7'-4"		430	F-4	B-3	-	W-3	W-3	W-3	W-2	C-1	10'-0"	
131	F-7	B-6	W-5-2	W-1	W-2	W-2	W-2	C-1	8'-0"	SEE ELEVATIONS SHT. A-12	231	F-448	B-347	-	W-2	W-1	W-2	C-1	8'-0"		331	F-7	B-6	-	W-6	W-6	W-6	W-6	C-4	7'-4"		431	F-1	B-244	-	W-143	W-142	W-5	W-2	C-2	-		
132	F-7	B-6	W-5-2	W-2	W-2	W-1	W-2	C-1	8'-0"	SEE ELEVATIONS SHT. A-12	232	F-3	B-2	-	W-2	W-2	W-2	W-2	C-1	10'-0"		332	F-4	B-3	-	W-3	W-3	W-3	W-3	C-1	8'-0"		432	F-6	-	-	W-1	W-1	W-1	W-1	C-1	11'-0"	SEE DETAILS SHT. N° A-12
133	F-3	B-1	-	W-1	W-1	W-1	W-1	C-1	7'-0"		233	F-1	B-2	-	W-3	W-3	W-3	W-3	C-1	10'-0"		333	F-4	B-3	W-5-1	W-3	W-3	W-3	W-3	C-1	10'-0"		433	F-1	B-244	-	W-2	W-1	W-1	W-1	C-1	10'-0"	
134	F-3	B-1	-	W-1	W-2	W-1	W-1	C-1	9'-0"		234	F-4	B-3	W-5-1	W-3	W-3	W-3	W-3	C-1	10'-0"		334	F-1	B-2	-	W-3	W-3	W-3	W-3	C-1	10'-0"		434	F-1	B-244	-	W-1	W-2	W-2	W-2	C-1	10'-0"	
135	F-5	-	-	W-2	W-1	W-2	W-2	C-2	-		235	F-3	B-2	-	W-2	W-2	W-2	W-1	C-1	10'-0"		335	F-1	B-2	-	W-142	W-1	W-2	C-1	8'-0"		435	F-1	B-244	-	W-1	W-2	W-1	W-2	C-1	10'-0"		
136	F-6	B-1	-	W-1	W-1	W-1	W-1	C-3	-	SEE DETAILS SHT. N° A-12	236	F-6	-	-	W-1	W-1	W-1	W-1	C-3	-	SEE DETAILS SHT. N° A-12	336	F-5	-	-	W-247	W-2	W-2	W-2	C-2	-		436	F-1	B-244	-							

LEGEND - FLOOR PLANS

- EXISTING WALLS & PARTITIONS TO BE REMOVED
- ▨ BRICK
- ▩ CLAY TILE
- ▧ 3" GYPSUM PARTITION TILE
- ▭ CONCRETE OR STONE

DOOR REFERENCE SCHEDULE - FIRST FLOOR

MARK	SIZE	TYPE	THRESHOLD	FRAME	HARDWARE	GROUP	DOOR GRILL
101	3'-0" x 7'-0" x 1 3/4"	D-5	H.A.	4			24" x 24"
102	3'-0" x 7'-0" x 1 3/4"	D-3	WOOD	1			24" x 24"
103	3'-0" x 7'-0" x 1 3/4"	D-3	WOOD	2			18" x 12"
104	3'-0" x 7'-0" x 1 3/4"	D-3	WOOD	2			18" x 12"
105	3'-0" x 7'-0" x 1 3/4"	D-1	WOOD	2			18" x 12"
106	4'-0" x 7'-0" x 1 3/4"	D-5	H.A.	9			
107	3'-0" x 7'-0" x 1 3/4"	D-3	WOOD	2			18" x 12"
108	3'-0" x 7'-0" x 1 3/4"	D-4	WOOD	1			18" x 8"
109	3'-0" x 7'-0" x 1 3/4"	D-2	WOOD	1			24" x 24"
110	EXISTING	EXIST.		6			24" x 24"
111	3'-0" x 7'-0" x 1 3/4"	D-5	H.A.	4			
112	3'-0" x 7'-0" x 1 3/4" ALUM.	ALUM.	ALUM.	-			
113	3'-0" x 7'-0" x 1 3/4"	D-3	WOOD	2			18" x 12"
114	3'-0" x 7'-0" x 1 3/4"	D-3	WOOD	2			18" x 12"
115	3'-0" x 7'-0" x 1 3/4"	D-3	WOOD	2			18" x 12"
116	3'-0" x 7'-0" x 1 3/4"	D-3	WOOD	2			18" x 12"
117	3'-0" x 7'-0" x 1 3/4"	D-3	WOOD	2			18" x 12"
118	3'-0" x 7'-0" x 1 3/4"	D-3	WOOD	2			24" x 24"
119	3'-0" x 7'-0" x 1 3/4"	D-2	WOOD	2			18" x 12"
120	3'-0" x 7'-0" x 1 3/4"	D-2	WOOD	2			18" x 12"
121	3'-0" x 7'-0" x 1 3/4"	D-2	WOOD	2			18" x 12"
122	3'-0" x 7'-0" x 1 3/4"	D-2	WOOD	2			18" x 12"
123	3'-0" x 7'-0" x 1 3/4" ALUM.	ALUM.	ALUM.	-			
124	3'-0" x 7'-0" x 1 3/4"	D-5	H.A.	4			
125	3'-0" x 7'-0" x 1 3/4"	D-5	WOOD	2			18" x 8"
126	3'-0" x 7'-0" x 1 3/4"	D-3	WOOD	2			18" x 8"
127	3'-0" x 7'-0" x 1 3/4"	D-3	WOOD	2			18" x 8"
128	3'-0" x 7'-0" x 1 3/4"	D-3	WOOD	2			18" x 8"
129	3'-0" x 7'-0" x 1 3/4"	D-3	WOOD	2			18" x 8"
130	3'-0" x 7'-0" x 1 3/4"	D-3	WOOD	2			18" x 8"
131	(2) 2'-6" x 7'-0" x 1 3/4"	D-1	WOOD	1			24" x 24"
132	(2) 2'-6" x 7'-0" x 1 3/4"	D-5	H.A.	5			
133	3'-0" x 7'-0" x 1 3/4"	D-3	WOOD	1			24" x 24"
134	3'-0" x 7'-0" x 1 3/4"	D-3	WOOD	1			24" x 24"
135	3'-0" x 7'-0" x 1 3/4"	D-3	WOOD	1			24" x 24"
136	3'-0" x 7'-0" x 1 3/4"	D-3	WOOD	1			24" x 24"
137	3'-0" x 7'-0" x 1 3/4"	D-5	H.A.	4			
138	(2) 2'-6" x 7'-0" x 1 3/4"	D-1	WOOD	6 (1-DR)			
139	2'-6" x 7'-0" x 1 3/4"	D-4	MARBLE	WOOD	5		18" x 8"
140	2'-6" x 7'-0" x 1 3/4"	D-4	MARBLE	WOOD	5		18" x 8"
141	EXISTING	EXIST.		6			
142	(2) 2'-10" x 8'-0" x 1 3/4"	D-4	EXIST.	7			
143	(2) 2'-10" x 8'-0" x 1 3/4"	D-4	EXIST.	7			
144	EXISTING	EXIST.		6			
145	3'-0" x 7'-0" x 1 3/4"	D-2	WOOD	1			
146	3'-0" x 7'-0" x 1 3/4"	D-5	H.A.	9			
147	EXISTING	EXIST.		6			
148	EXISTING	EXIST.		6			
149	3'-0" x 7'-0" x 1 3/4"	D-4	WOOD	1			
150	3'-0" x 7'-0" x 1 3/4"	D-6	H.A.	9			35" x 41"

* OMIT THESE DOORS UNDER BASE BID. INCLUDE UNDER ALT. NO. 1

151: 2'-6" x 7'-0" x 1 3/4" WOOD 4

1/2" ST. RE. DOOR PANEL 1" x 1" x 1/4" L REINF. CONT. INCLUDE 151452 BASE BID-OAIT UNDER ALT. NO. 1. SEE SHT. A-17

VOLCANIZED 2x4 ROUGH BUCK ANCHOR TO CONG.


2"x2"x3/16" L FRAME

NOTE: PROVIDE 1/2 PR. BUTTS & HAMP LOCK

EXISTING CONG. WALL

NEW TELEPHONE TUNNEL DOOR

SCALE: 3/8" = 1'-0"

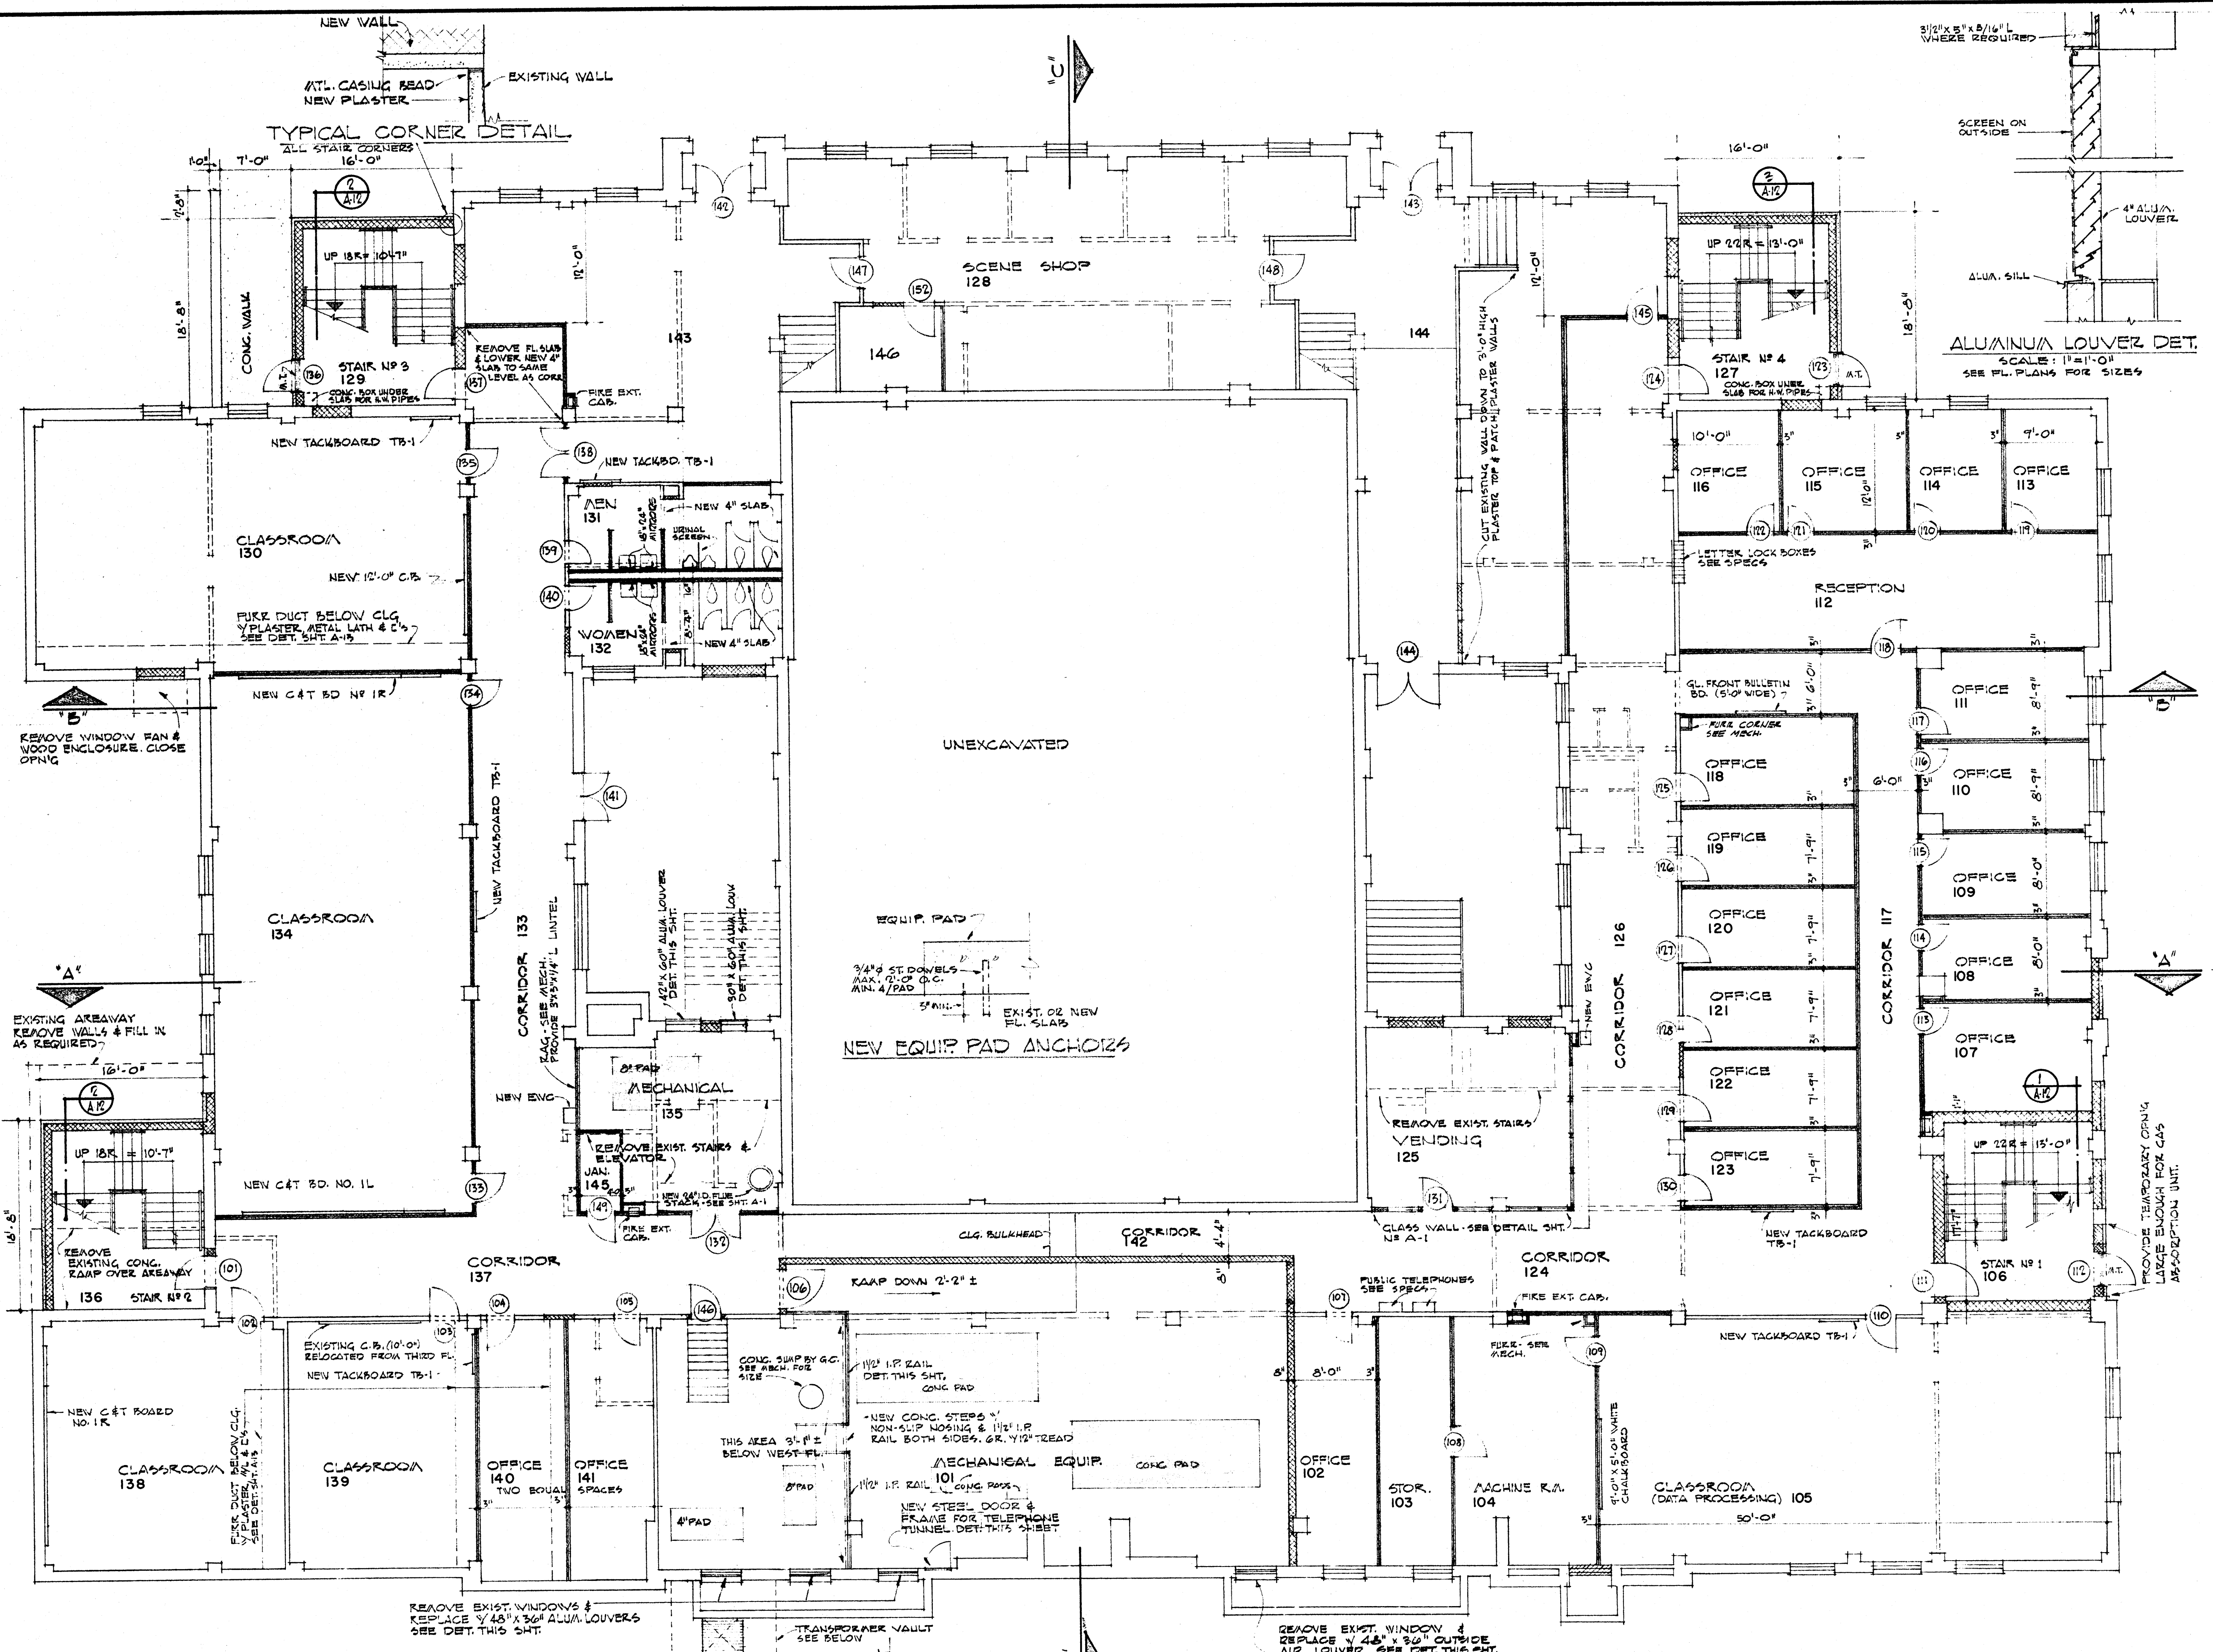

FIRST FLOOR PLAN SCALE 1/8" = 1'-0"

NOTE: ALL UNB. PARTITIONS SHALL EXTEND TO UNDER SIDE OF CONG. SLAB ABOVE. TYPICAL ALL FLOOR

ALL JOINTS WELDED & GROUND SMOOTH

NEW 4" HIGH CONG. CURB

REPLACE ACCESS COVER W/ STEEL GRATE. SEE DET. THIS SHT.

TRANSFORMER VAULT PLAN SCALE: 1/8" = 1'-0"

TRANSFORMER VAULT PLAN SCALE: 1/8" = 1'-0"

REPLACE ACCESS COVER W/ STEEL GRATE. SEE DET. THIS SHT.

EXIST. OPENING 148" x 148"

3"x6" x 1/4" L ANCHOR TO EXISTING CONG.

STEEL GRATE DETAIL SCALE: 3/8" = 1'-0"

SCALE: 3/8" = 1'-0"


DATE 2-21-66	RENOVATIONS TO WILSON HALL ARKANSAS STATE COLLEGE JONESBORO, ARKANSAS STUCK, FRIER, LANE & SCOTT, INC., ARCHITECTS 601 SOUTHWEST DRIVE • JONESBORO, ARKANSAS	SHEET NUMBER A-3
DRAWN BY HRE, JOM.		COMMISSION NUMBER 42800
CHECKED BY		
REVISIONS		

DOOR REFERENCE SCHEDULE - SECOND FL.

MARK	SIZE	TYPE	THRESHOLD	FRAME	HARDWARE	GROUP	DOOR GRILL
201	SEE DET. SHT. NO. A-11		ALUM.	ALUM.			
202	SEE DET. SHT. NO. A-11		ALUM.	ALUM.			
203	SEE DET. SHT. NO. A-11		ALUM.	ALUM.			
204	SEE DET. SHT. NO. A-11		ALUM.	ALUM.			
205	SEE DET. SHT. NO. A-11		ALUM.	ALUM.			
206	SEE DET. SHT. NO. A-11		ALUM.	ALUM.			
207	EXISTING		EXIST.	6		24x24	
208	EXISTING		EXIST.	6			
209	3'-0" x 7'-0" x 13/4"	D-2		WOOD	6	18x8	
210	EXISTING		EXIST.	6		18x12	
211	EXISTING		EXIST.				
212	EXISTING		EXIST.				
213	2'-6" x 7'-0" x 13/4"	D-2		WOOD	10		
214	EXISTING		EXIST.				
215	3'-0" x 7'-0" x 13/4"	D-2		WOOD	6	18x12	
216	EXISTING		EXIST.				
217	EXISTING		EXIST.	6		18x12	
218	EXISTING		EXIST.	6			
219	EXISTING		EXIST.	1		24x36	
220	3'-0" x 7'-0" x 13/4"	D-5	ALUM.	H.A.	4		
221	3'-0" x 7'-0" x 13/4"	D-2		WOOD	6		
222	(2) 2'-6" x 7'-0" x 13/4"	D-5		H.A.	8		
223	EXISTING		EXIST.	6		24x36	
224	EXISTING		EXIST.	6		18x8	
225	2'-6" x 7'-0" x 13/4"	D-2		WOOD		18x8	
226	2'-6" x 7'-0" x 13/4"	D-2	MARKLE	WOOD	5	18x8	
227	EXISTING		EXIST.				
228	3'-0" x 7'-0" x 13/4"	D-2	ALUM.	WOOD	6		
229	EXISTING		EXIST.	6		24x36	
230	3'-0" x 7'-0" x 13/4"	D-5	ALUM.	H.A.	4		
231	3'-0" x 7'-0" x 13/4"	D-1		WOOD	6		
232	2'-6" x 7'-0" x 13/4"	D-4	MARKLE	WOOD	5		
233	2'-6" x 7'-0" x 13/4"	D-4	MARKLE	WOOD	5		
234	3'-0" x 7'-0" x 13/4"	D-2	ALUM.	WOOD	6	24x24	
235	3'-0" x 7'-0" x 13/4"	D-5	ALUM.	H.A.	4		
236	EXISTING		EXIST.	6		24x36	
237	EXISTING		EXIST.	6		18x8	
238	EXISTING		EXIST.	6		18x8	
239	EXISTING		EXIST.	6		24x24	
240	EXISTING		EXIST.	6		24x24	
241	(2) 2'-6" x 7'-0" x 13/4"	D-5		H.A.	8		
242	3'-0" x 7'-0" x 13/4"	ALUM.		ALUM.			
243	3'-0" x 7'-0" x 13/4"	D-5		H.A.	4		
244	3'-0" x 7'-0" x 13/4"	D-1		WOOD	6	24x24	
245	3'-0" x 7'-0" x 13/4"	D-1		WOOD	6	18x8	
246	EXISTING		EXIST.	6		24x24	
247	3'-0" x 7'-0" x 13/4"	D-2		WOOD	6	18x12	
248	3'-0" x 7'-0" x 13/4"	D-2		WOOD	2	18x8	
249	3'-0" x 7'-0" x 13/4"	D-2		WOOD			
250	3'-0" x 7'-0" x 13/4"	D-2		WOOD			
251	EXISTING		EXIST.				
252	EXISTING		EXIST.	6			
253	EXISTING		EXIST.				
254	EXISTING		EXIST.	6			
255	EXISTING		EXIST.	6		18x8	
256	EXISTING		EXIST.	6		24x24	
257	EXISTING		EXIST.	6		24x24	
258	EXISTING		EXIST.	6		24x24	
259	EXISTING		EXIST.	6		24x24	
260	(3) 2'-6" x 8'-0" x 13/4"	D-4		EXIST.	11		
261	(3) 2'-6" x 8'-0" x 13/4"	D-4		EXIST.	6		
262	EXISTING	*		EXIST.			
263	EXISTING	*		EXIST.			
264	EXISTING	*		EXIST.	6		
265	EXISTING	*		EXIST.	6		
266	EXISTING	*		EXIST.	6		
267	EXISTING	*		EXIST.	6		
268	(2) 3'-0" x 10'-0" x 13/4"	D-6		CHANNEL	3		
269	3'-0" x 7'-0" x 13/4"	D-4		EXIST.	1		
270	3'-0" x 7'-0" x 13/4"	D-4		WOOD	1	18x12	
271	3'-0" x 7'-0" x 13/4"	D-4		WOOD	1	24x24	

* OMIT THESE DOORS ON BASE BID. INCLUDE UNDER ALTERNATE NO. 1
 THE FOLLOWING DOORS SHALL BE OMITTED UNDER ALTERNATE NO. 1
 SEE DET. SHT. NO. A-13

272	(2) 3'-0" x 6'-8" x 13/4"	C		WOOD	14		
273	(2) 3'-0" x 6'-8" x 13/4"	B		WOOD	13		
274	2'-0" x 6'-8" x 13/4"	F		H.A.	15		
275	2'-0" x 6'-8" x 13/4"	F		H.A.	15		
276	2'-0" x 6'-8" x 13/4"	F		H.A.	15		
277	2'-0" x 6'-8" x 13/4"	F		H.A.	15		
278	2'-0" x 6'-8" x 13/4"	D-3		WOOD	4		
279	(2) 3'-0" x 6'-8" x 13/4"	B		WOOD	13		
280	(2) 3'-0" x 6'-8" x 13/4"	C		WOOD	14		

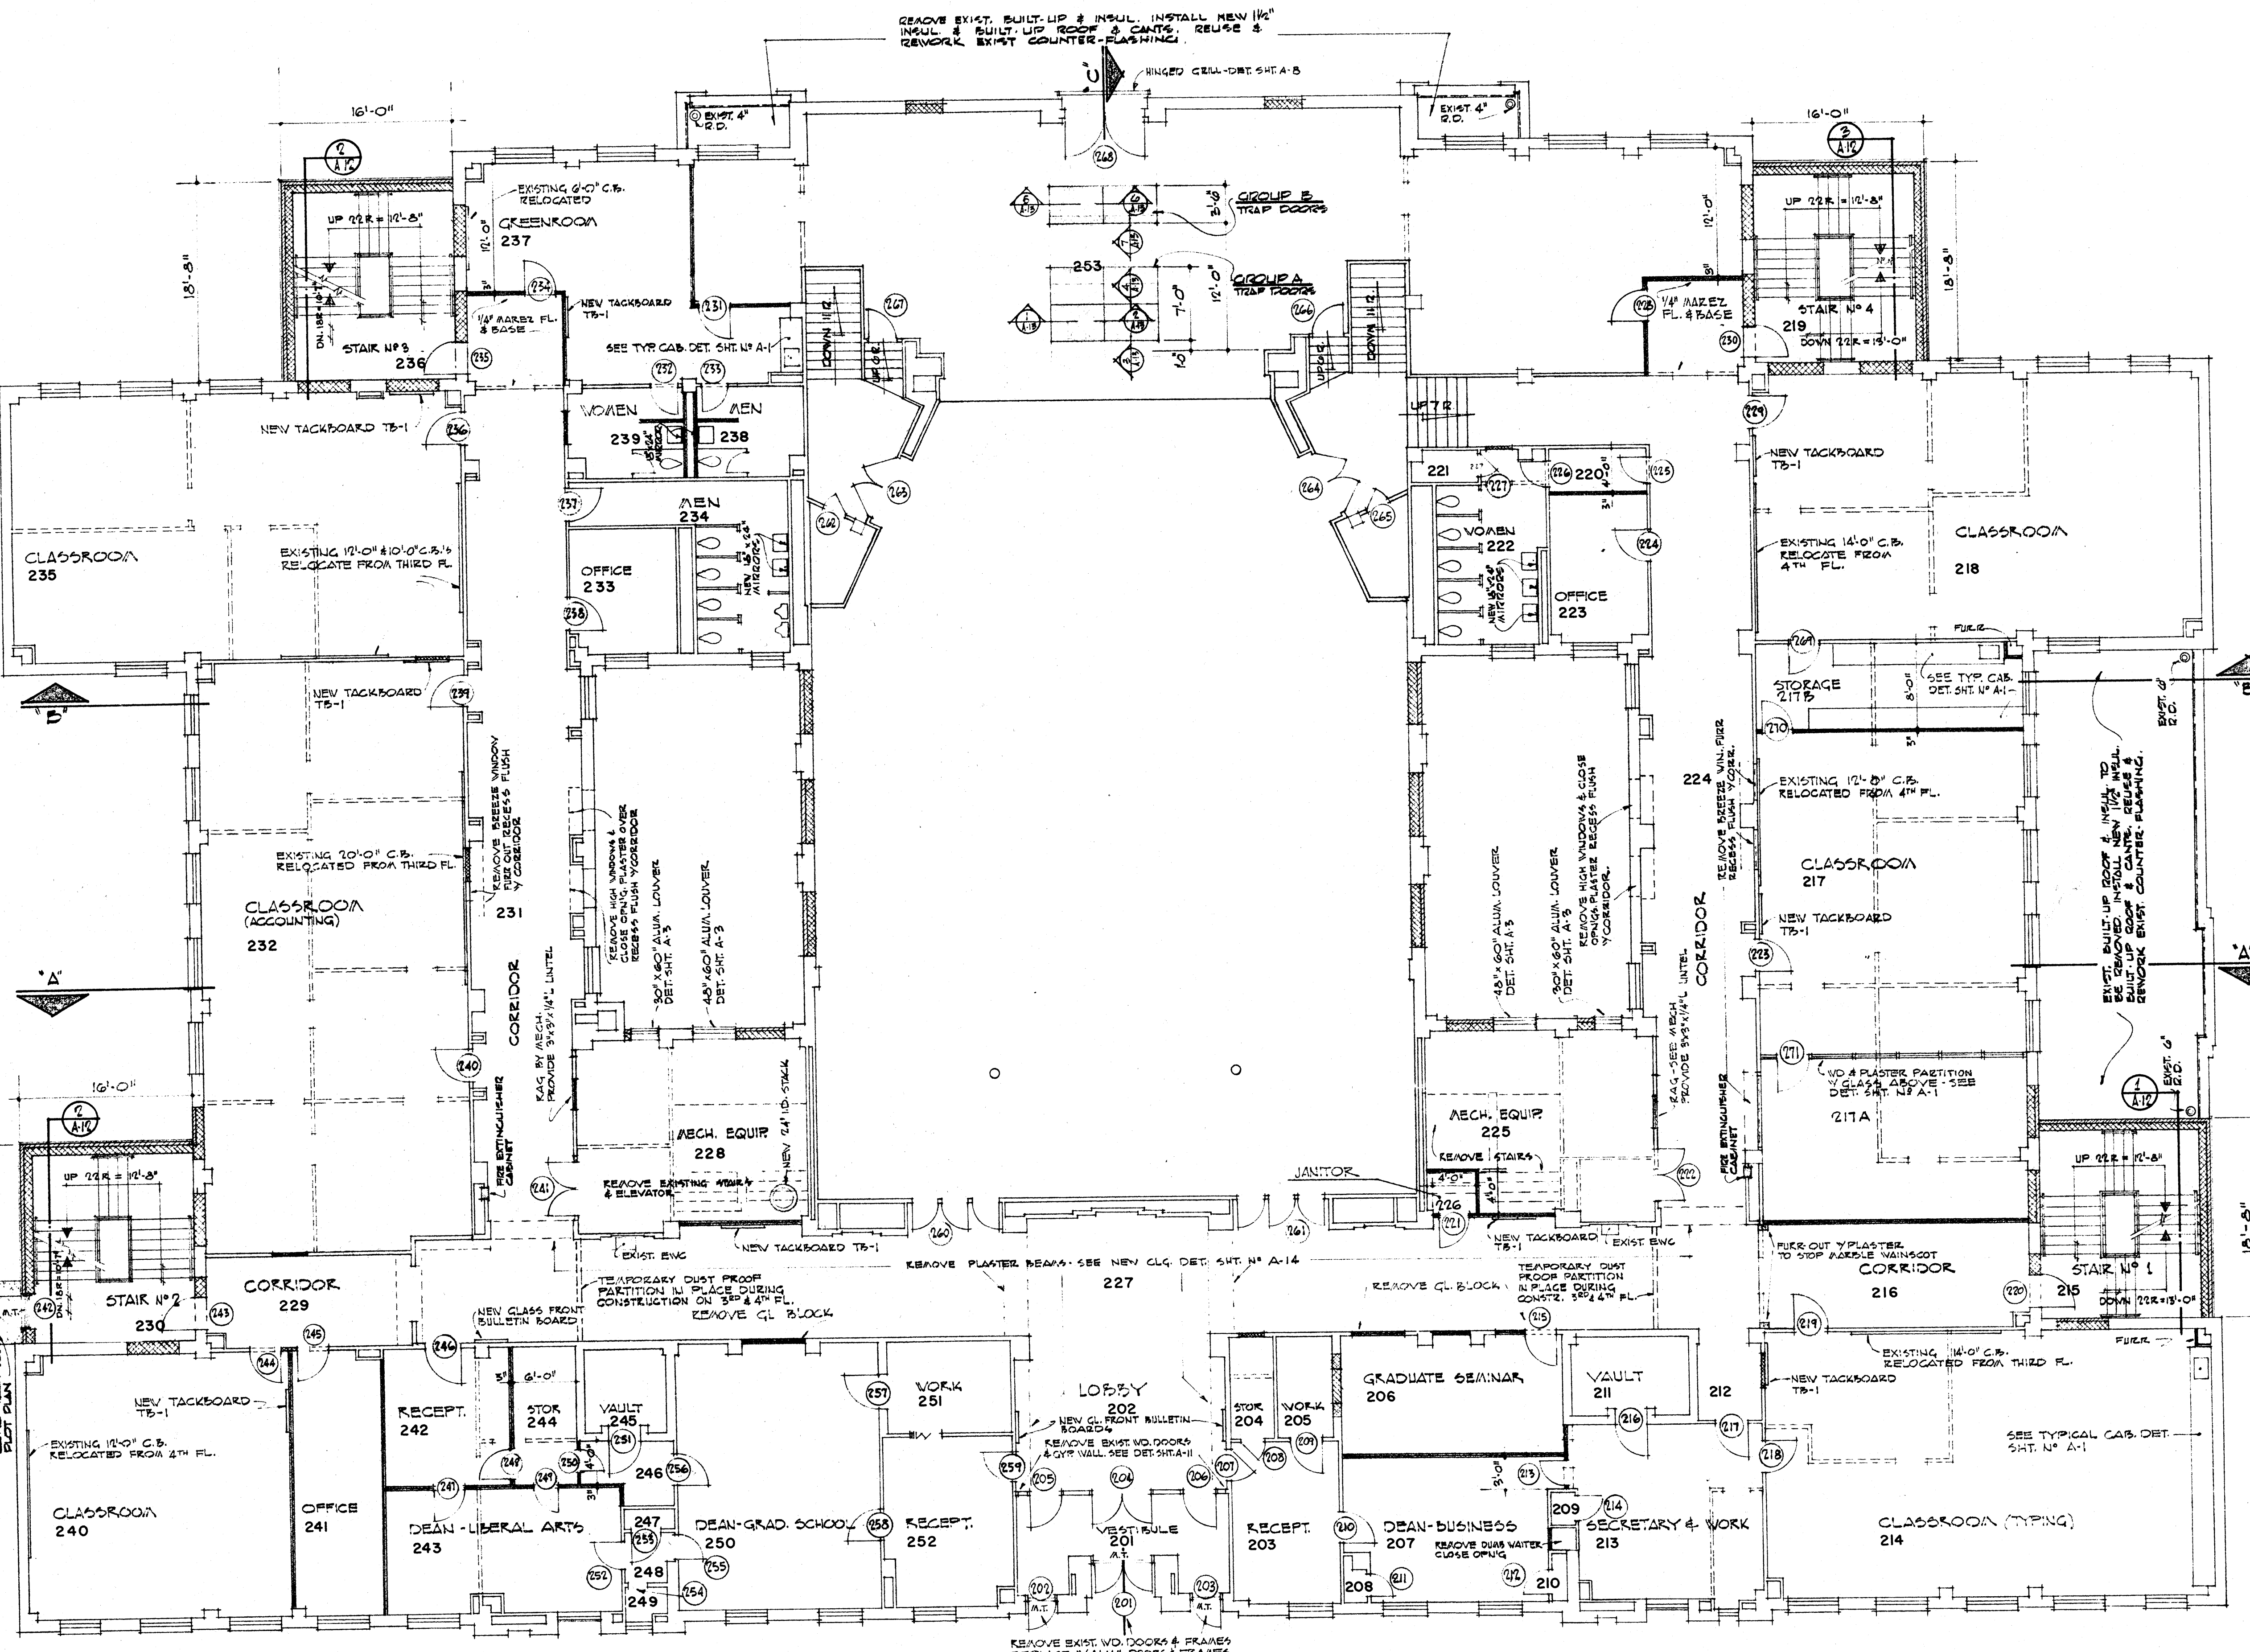

SECOND FLOOR PLAN SCALE 1/8" = 1'-0"

	DATE	2-21-60	RENOVATIONS TO WILSON HALL ARKANSAS STATE COLLEGE JONESBORO, ARKANSAS	SHEET NUMBER A-4 COMMISSION NUMBER 43860
	DRAWN BY	H.R. JONAS		
	CHECKED BY			
	REVISIONS			

STUCK, FRIER, LANE & SCOTT, INC., ARCHITECTS
 601 SOUTHWEST DRIVE • JONESBORO, ARKANSAS




DOOR REFERENCE SCHEDULE - THIRD FLOOR

MARK	SIZE	TYPE	THRESHOLD	FRAME	HARDWARE	DOOR
301	3'-0" x 7'-0" x 1 3/4"	D-5	H.A.	4		
302	3'-0" x 7'-0" x 1 3/4"	D-1	WOOD	6	24x24	
303	EXISTING		EXIST.	1	24x24	
304	EXISTING		EXIST.	6(1-DR)	2-18x12	
305	EXISTING		EXIST.	6	18x8	
306	3'-0" x 7'-0" x 1 3/4"	D-1	WOOD	6	18x8	
307	3'-0" x 7'-0" x 1 3/4"	D-1	WOOD	6	18x8	
308	3'-0" x 7'-0" x 1 3/4"	D-1	WOOD	6	18x8	
309	3'-0" x 7'-0" x 1 3/4"	D-1	WOOD	6	18x8	
310	3'-0" x 7'-0" x 1 3/4"	D-1	WOOD	6	18x8	
311	EXISTING		EXIST.	6	18x8	
312	3'-0" x 7'-0" x 1 3/4"	D-1	WOOD	6	18x8	
313	3'-0" x 7'-0" x 1 3/4"	D-2	WOOD	6	18x8	
314	3'-0" x 7'-0" x 1 3/4"	D-3	WOOD	2	24x24	
315	3'-0" x 7'-0" x 1 3/4"	D-2	WOOD	6	18x8	
316	3'-0" x 7'-0" x 1 3/4"	D-2	WOOD	6	18x8	
317	3'-0" x 7'-0" x 1 3/4"	D-7	WOOD	6	18x8	
318	3'-0" x 7'-0" x 1 3/4"	D-7	WOOD	6	18x8	
319	3'-0" x 7'-0" x 1 3/4"	D-7	WOOD	6	18x8	
320	3'-0" x 7'-0" x 1 3/4"	D-2	WOOD	6		
321	3'-0" x 7'-0" x 1 3/4"	D-5	H.A.	4		
322	3'-0" x 7'-0" x 1 3/4"	D-2	WOOD	6		
323	(2) 2'-0" x 7'-0" x 1 3/4"	D-5	EXIST.	8		
324	3'-0" x 7'-0" x 1 3/4"	D-3	WOOD	1	24x24	
325	EXISTING		EXIST.	6	24x36	
326	EXISTING		EXIST.	6	24x36	
327	EXISTING		EXIST.	6	18x8	
328	EXISTING		EXIST.	-	18x8	
329	EXISTING		EXIST.	-	18x8	
330	3'-0" x 7'-0" x 1 3/4"	D-5	H.A.	4		
331	3'-0" x 7'-0" x 1 3/4"	D-3	WOOD	1	24x24	
332	3'-0" x 7'-0" x 1 3/4"	D-2	WOOD	6	24x24	
333	3'-0" x 7'-0" x 1 3/4"	D-5	H.A.	4		
334	EXISTING		EXIST.	-	18x8	
335	EXISTING		EXIST.	-	18x8	
336	EXISTING		EXIST.	6	18x8	
337	EXISTING		EXIST.	6	24x24	
338	EXISTING		EXIST.	6	24x24	
339	3'-0" x 7'-0" x 1 3/4"	D-2	WOOD	6	24x24	
340	(2) 2'-0" x 7'-0" x 1 3/4"	D-5	H.A.	8		
341	EXISTING		EXIST.	6	24x24	
342	(2) 2'-0" x 7'-0" x 1 3/4"	D-4	EXIST.	11		
343	(2) 2'-0" x 7'-0" x 1 3/4"	D-4	EXIST.	11		
344	EXISTING *		EXIST.	6		
345	EXISTING		EXIST.	6		
346	EXISTING		EXIST.	6		
347	3'-0" x 7'-0" x 1 3/4"	D-3	WOOD	1	24x24	
348	(2) 2'-0" x 7'-0" x 1 3/4"	D-4	WOOD	12		

* OMIT THESE DOORS ON BASE ISO. INCLUDE UNDER ALT. N° 1

FOLLOWING DOORS OMITTED UNDER ALT. N° 1. SEE SHT. N° A-18

349	(2) 3'-0" x 4'-0" x 1 3/4"	E	WOOD	16	
350	2'-0" x 6'-0" x 1 3/4"	D	WOOD	2	18x8
351	2'-0" x 6'-0" x 1 3/4"	D	WOOD	2	18x8

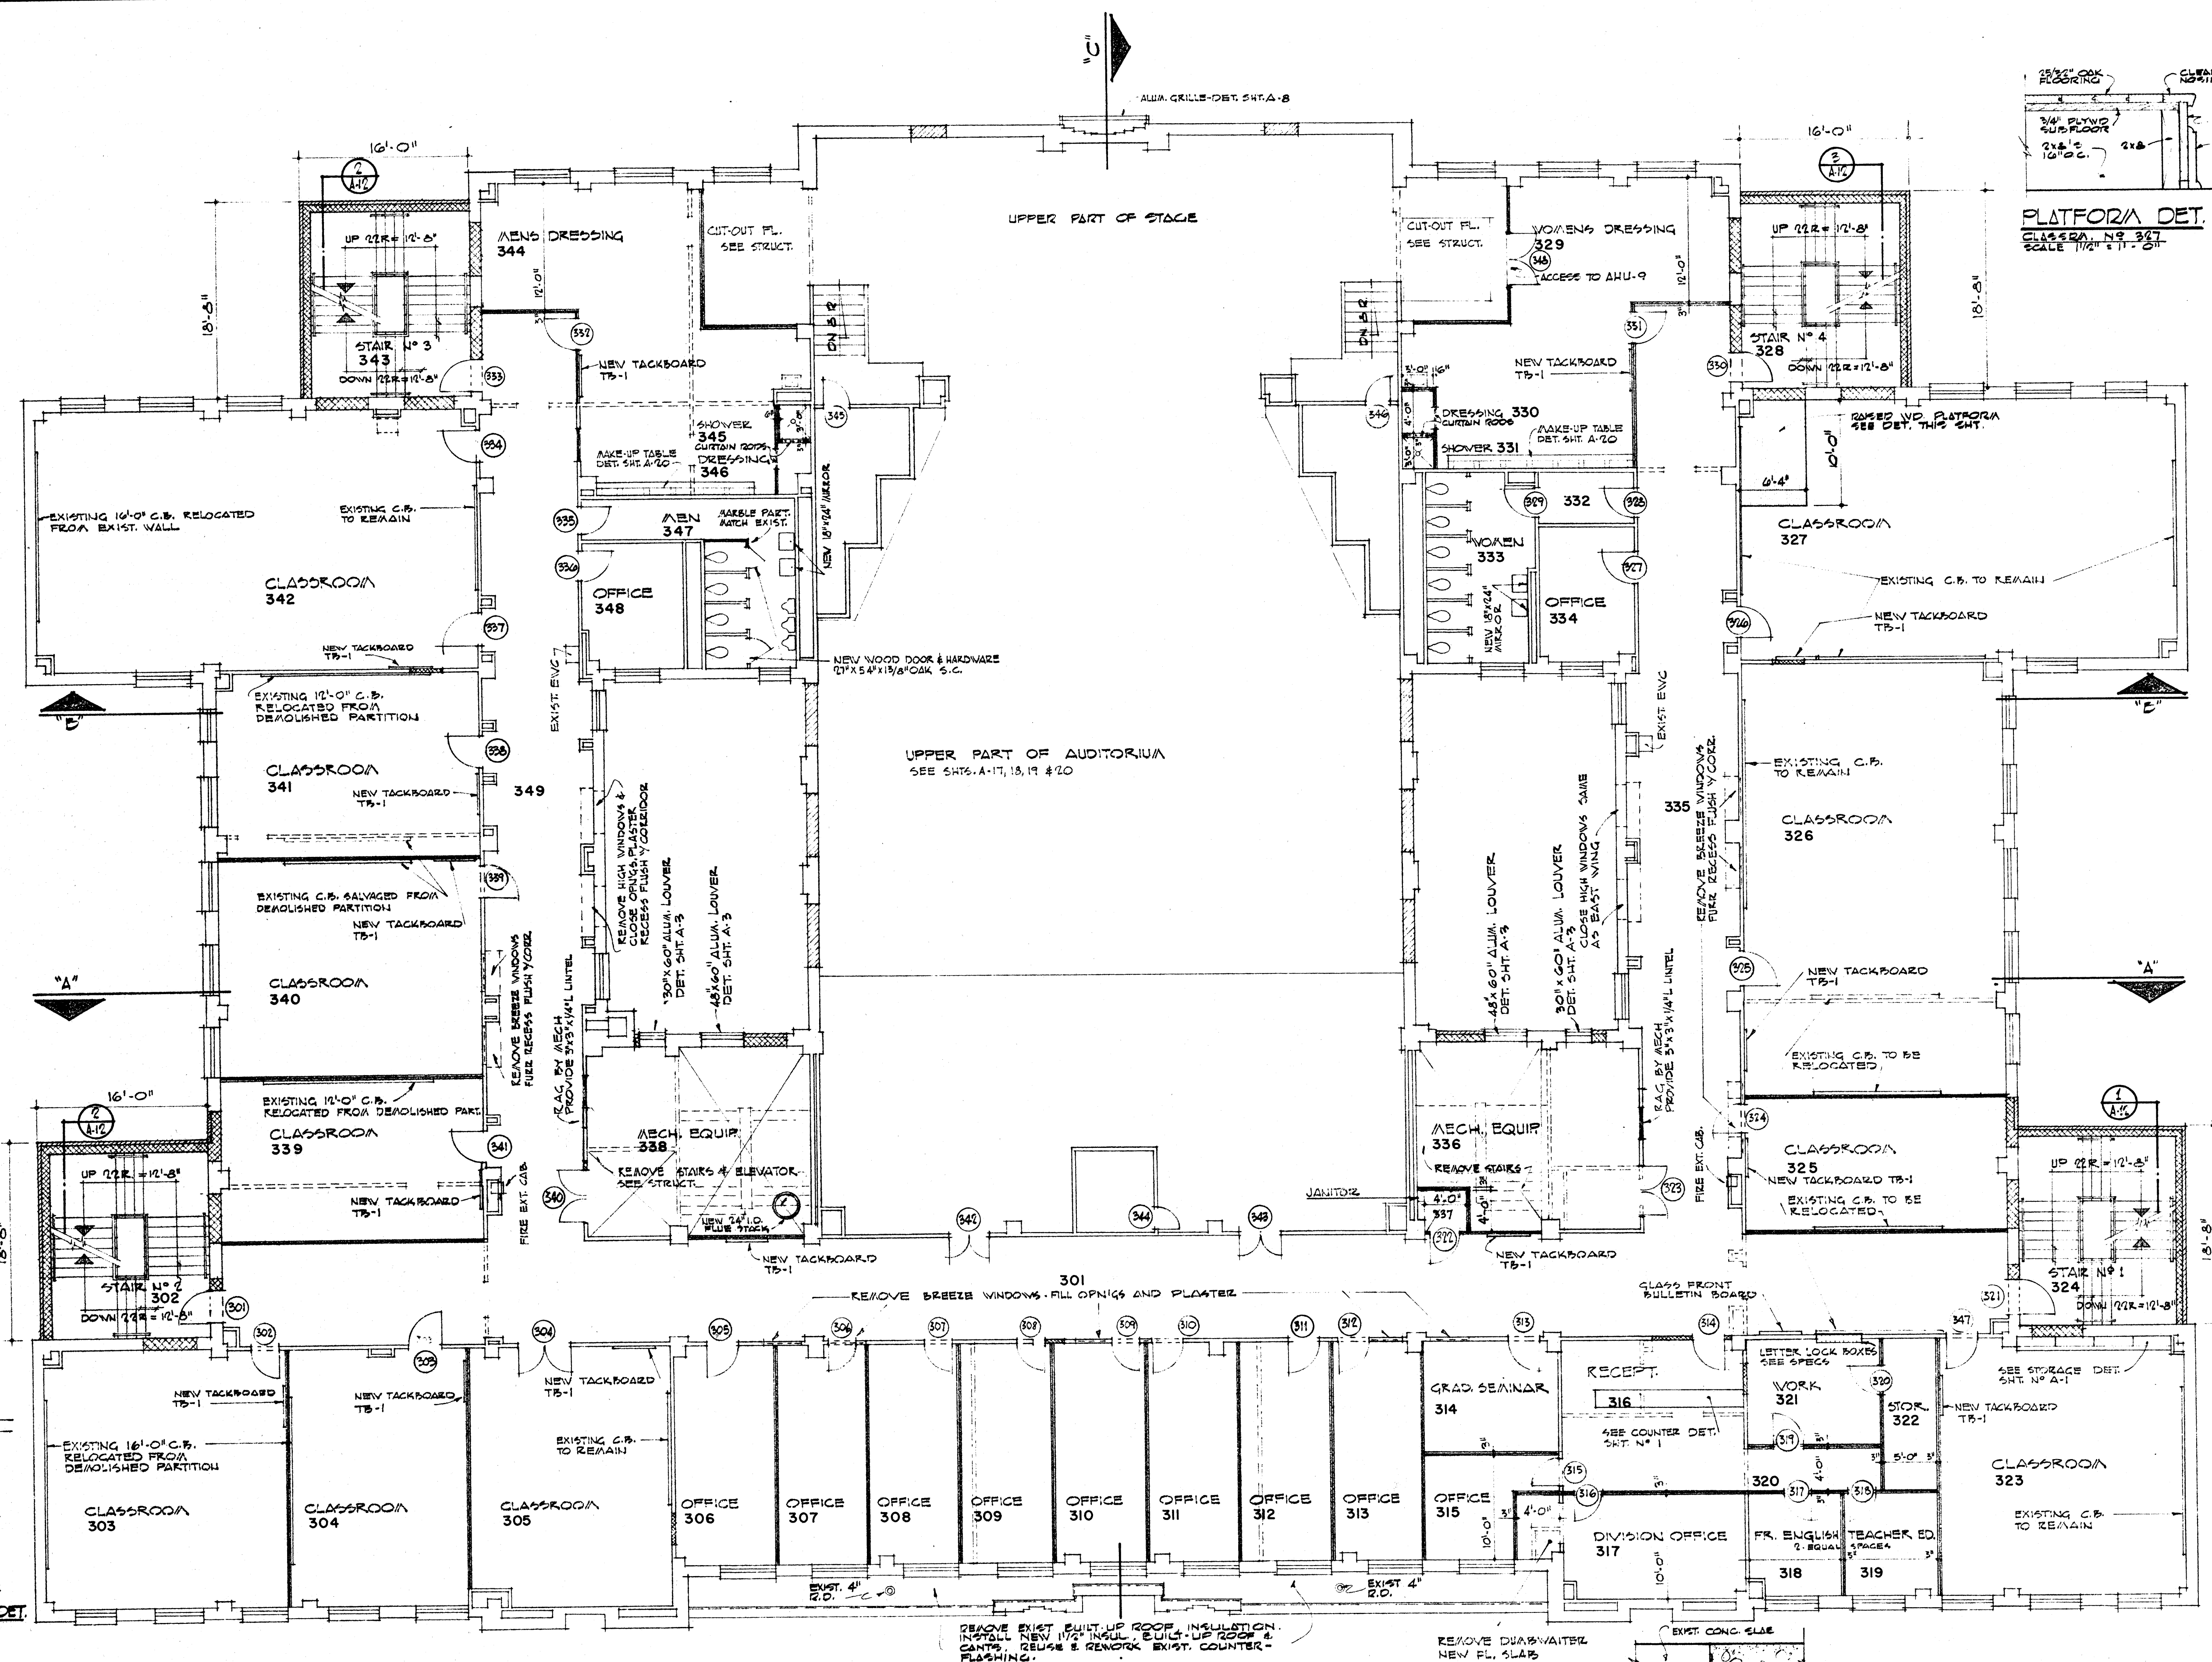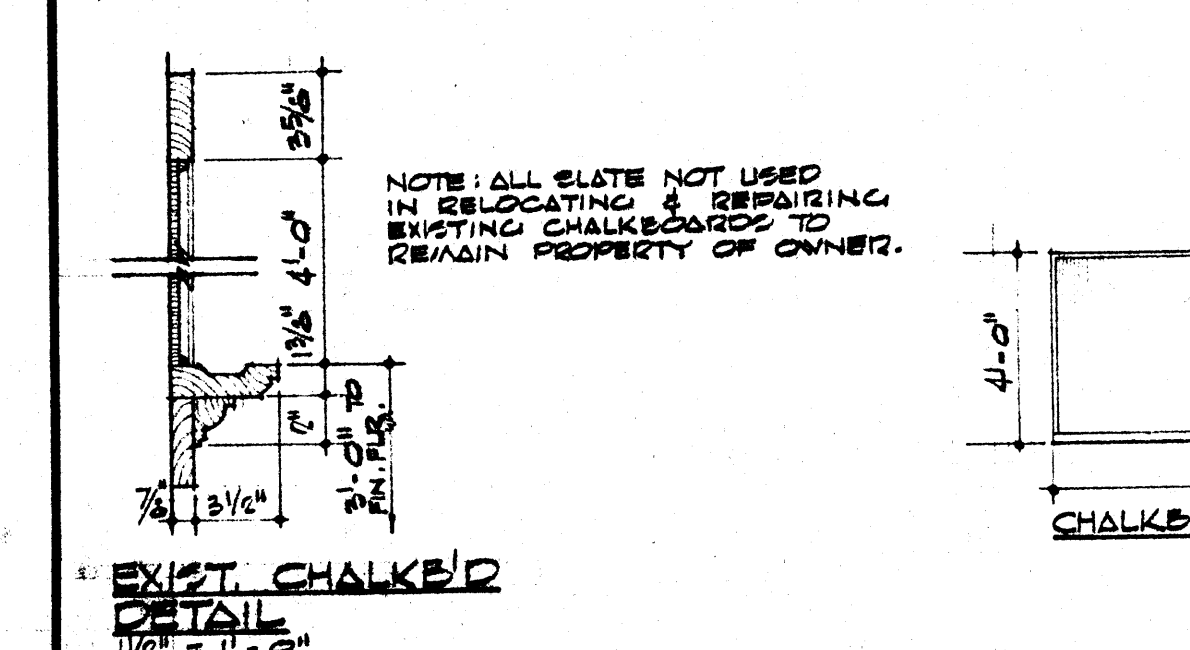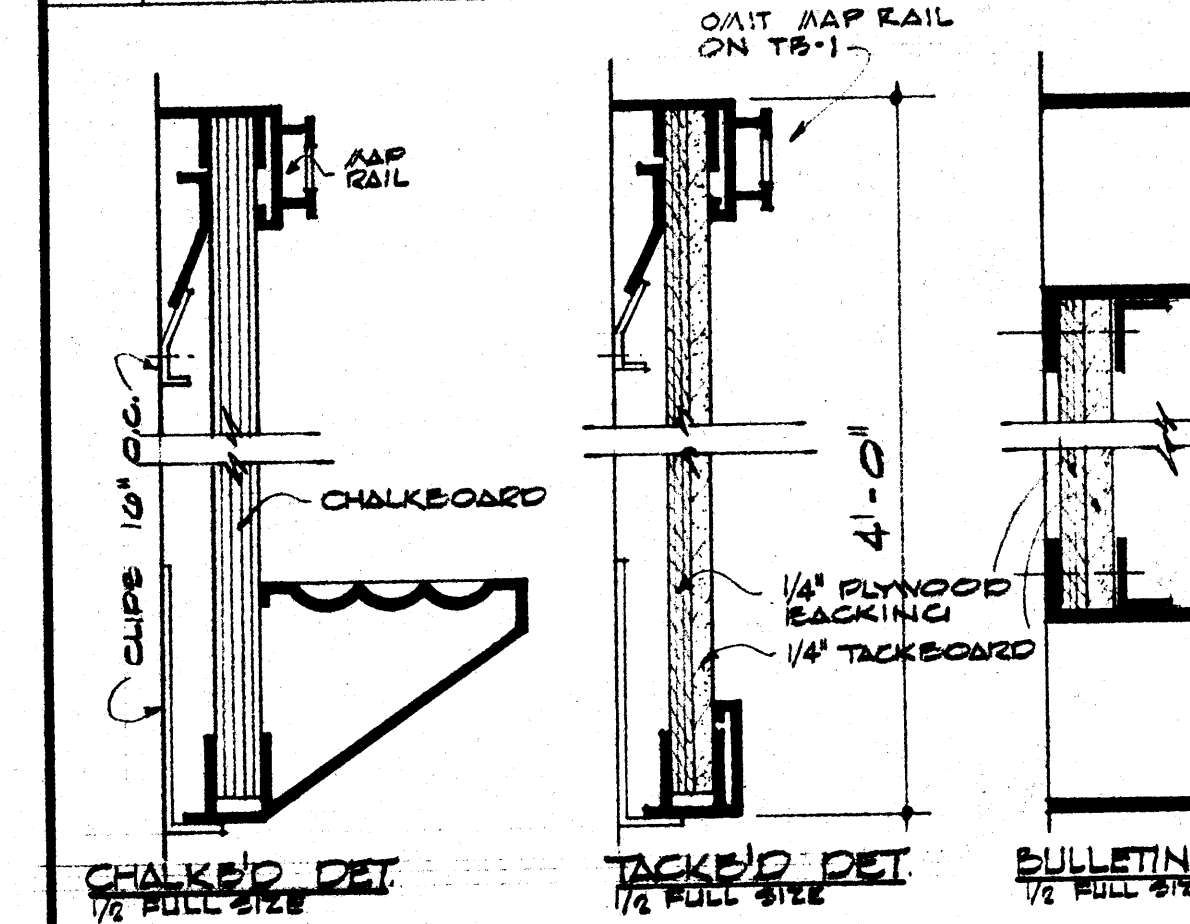

THIRD FLOOR PLAN SCALE 1/8" = 1'-0"

DATE 2-21-66

DRAWN BY HREJOM

CHECKED BY

REVISIONS


RENOVATIONS TO WILSON HALL ARKANSAS STATE COLLEGE JONESBORO, ARKANSAS

STUCK, FRIER, LANE & SCOTT, INC., ARCHITECTS


601 SOUTHWEST DRIVE • JONESBORO, ARKANSAS

SHEET NUMBER A-5


COMMISSION NUMBER 42866

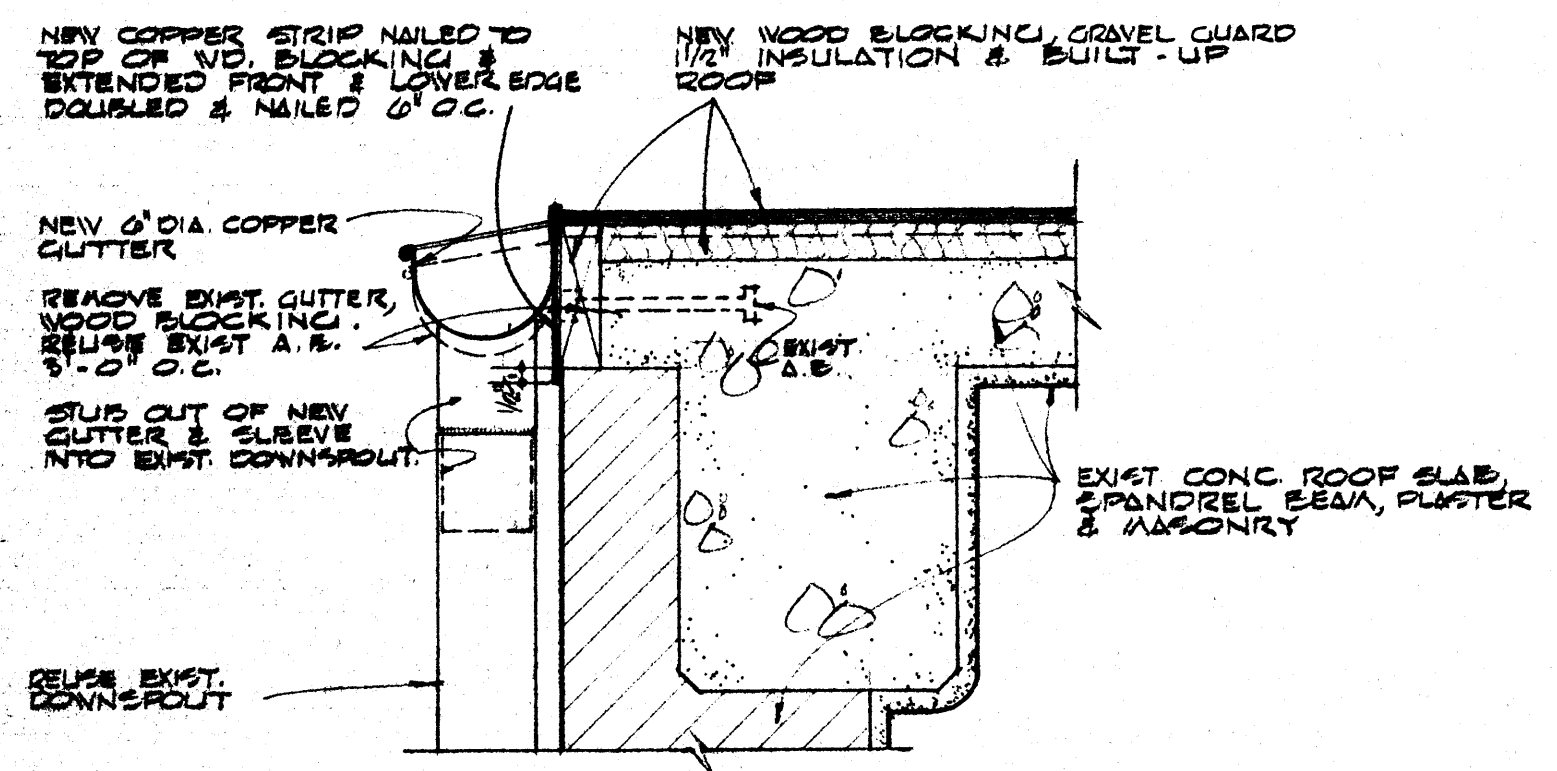


DETAIL 1
SCALE 1/2" = 1'-0"

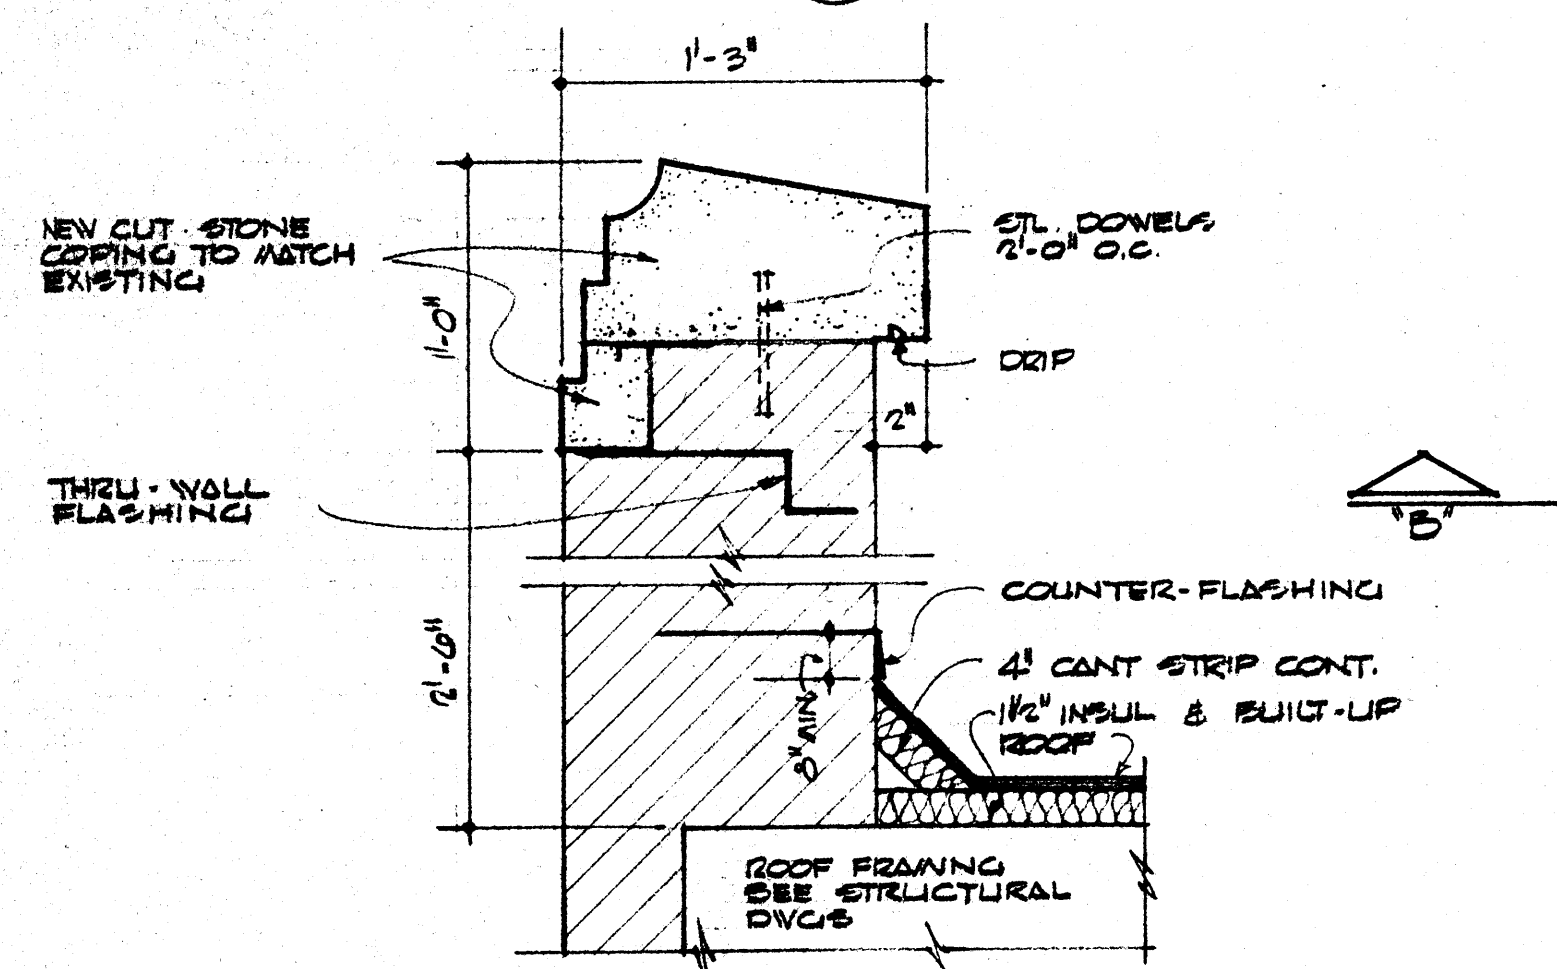


DETAIL 2
SCALE 1/2" = 1'-0"

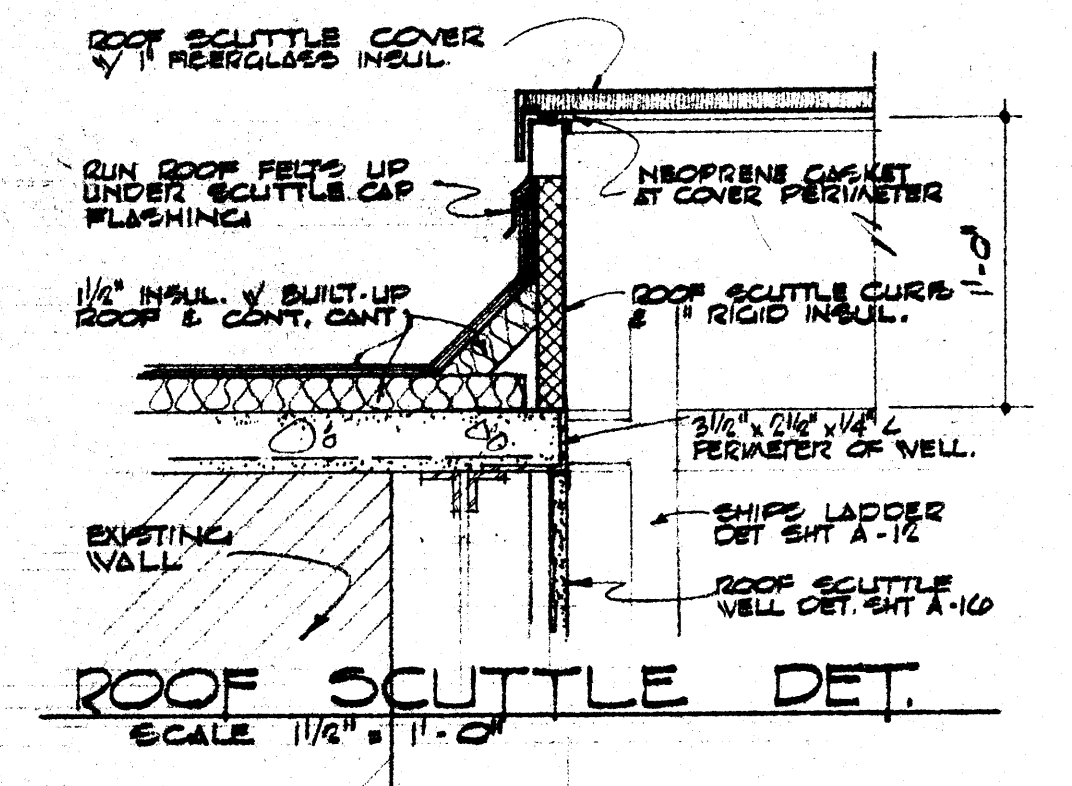


ROOF SCUTTLE DET.
SCALE 1/2" = 1'-0"

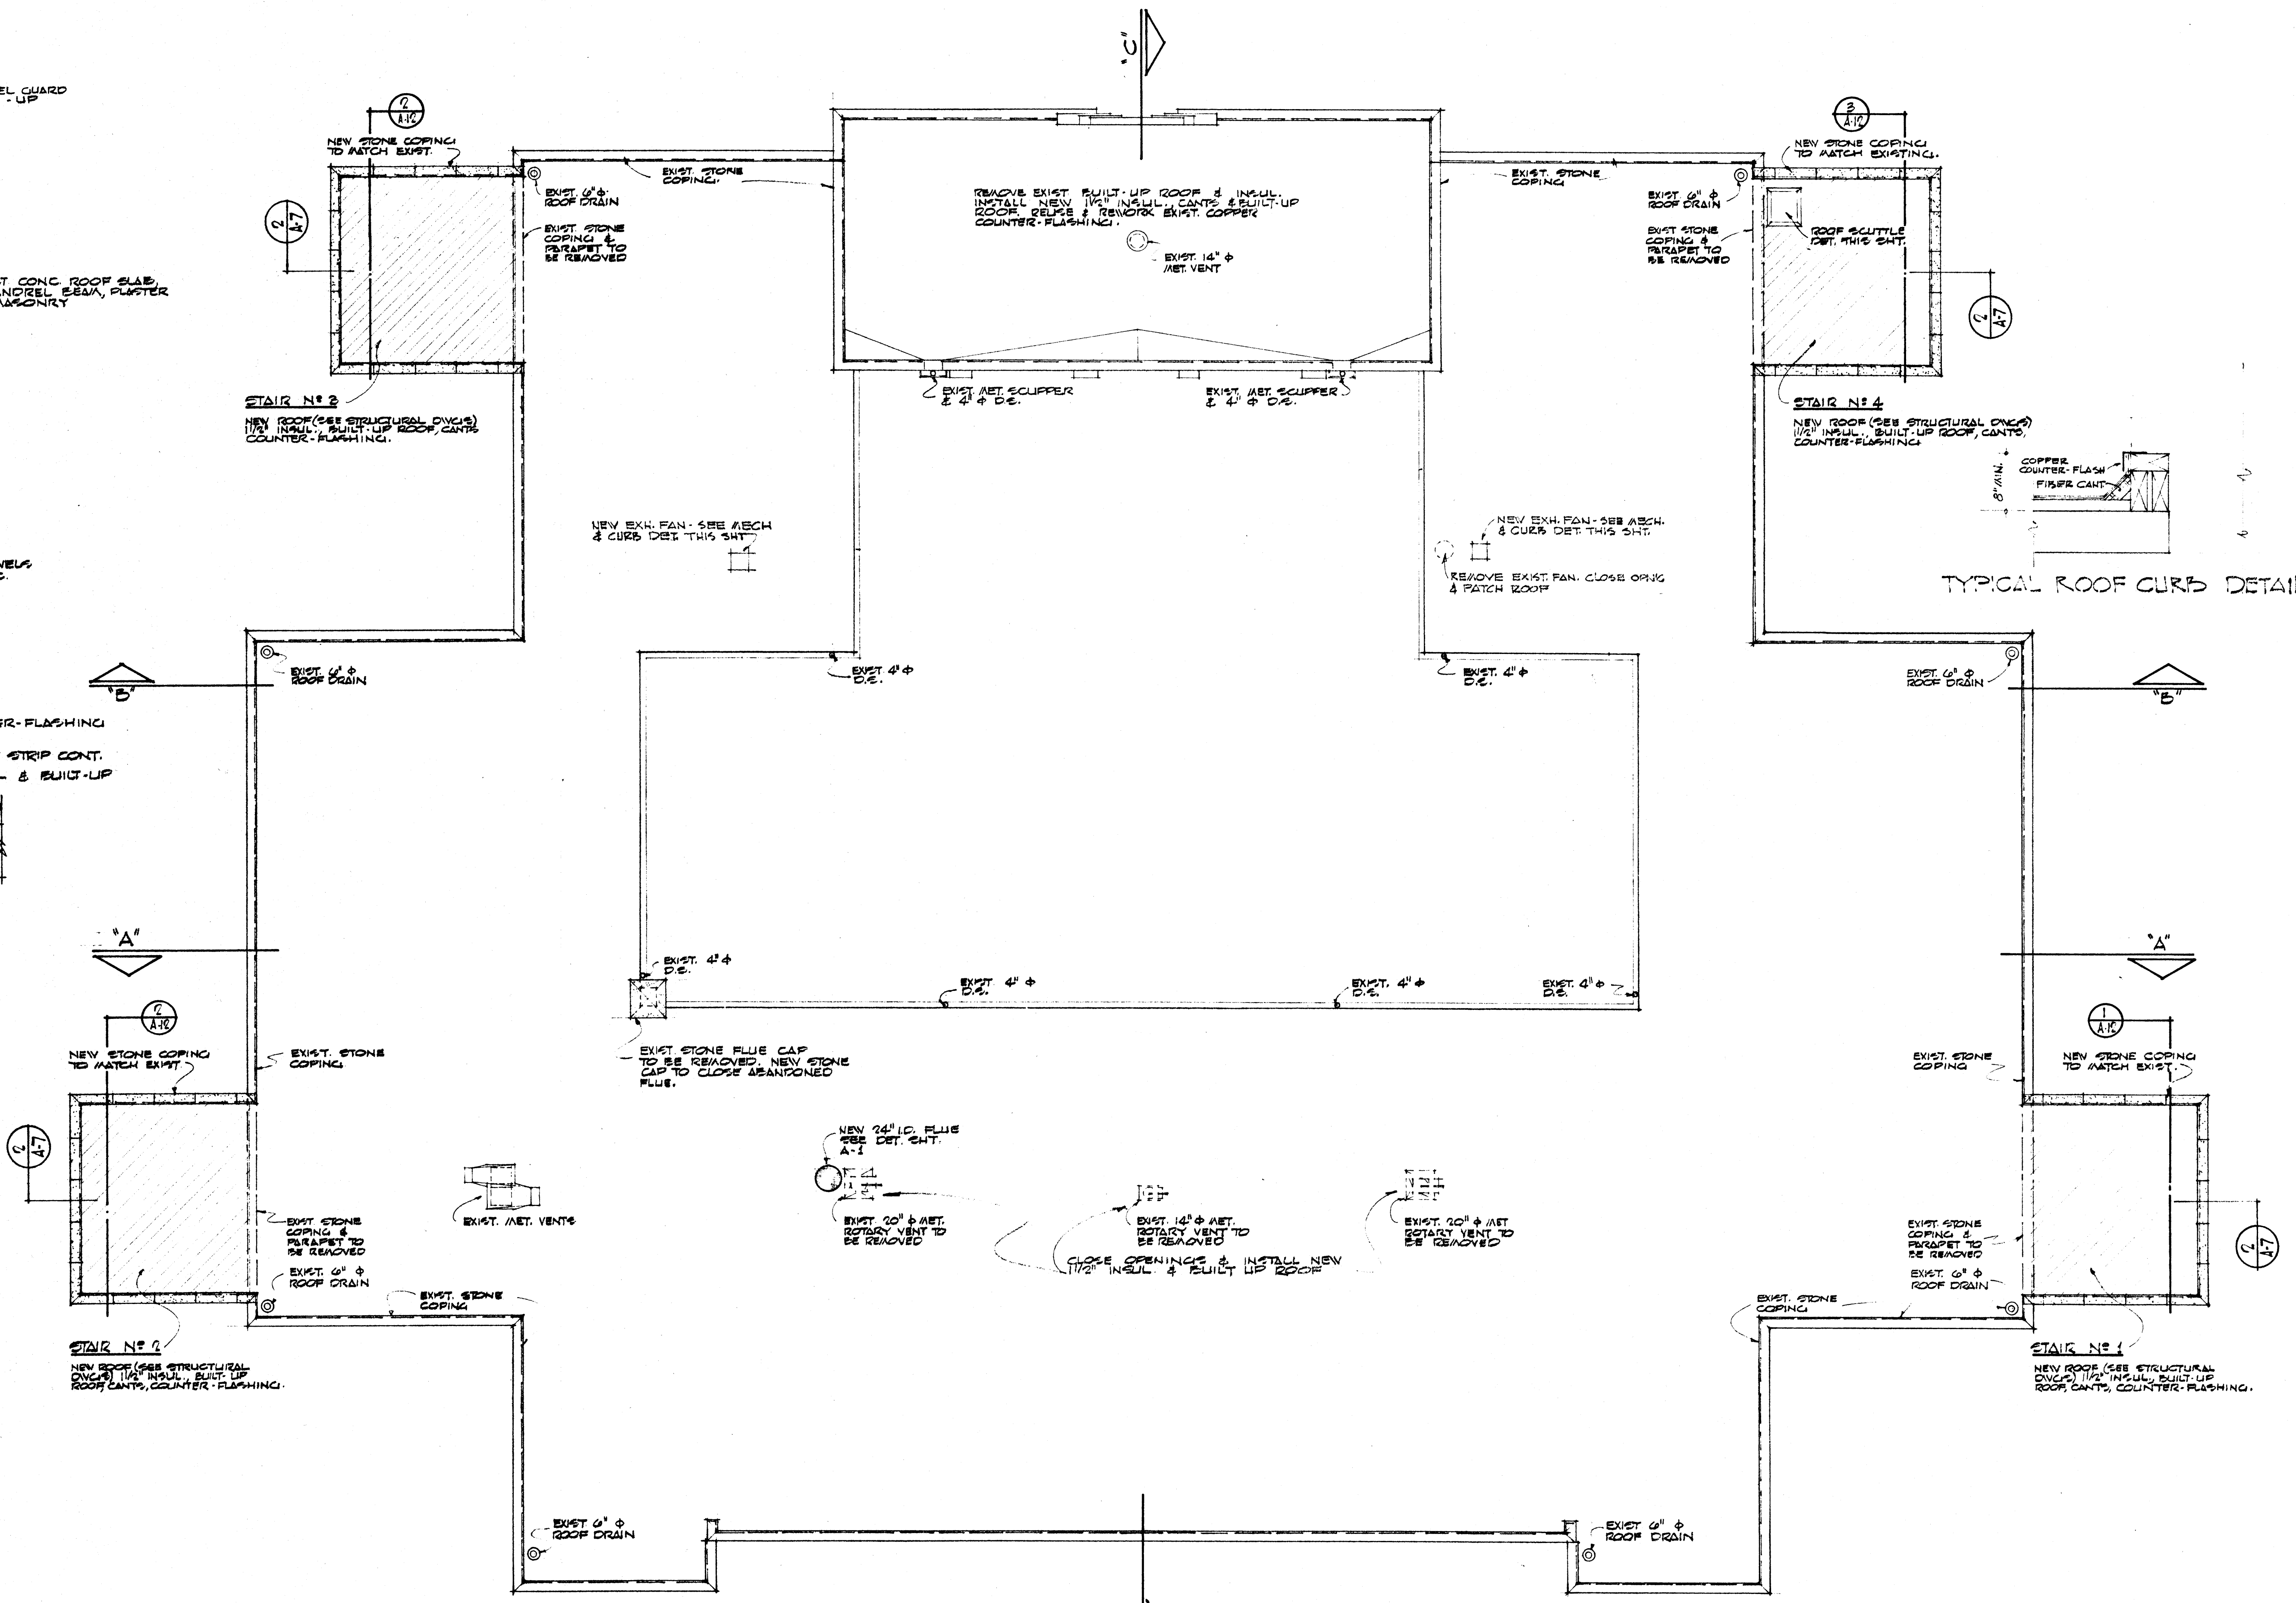

ROOF PLAN SCALE 1/8" = 1'-0"

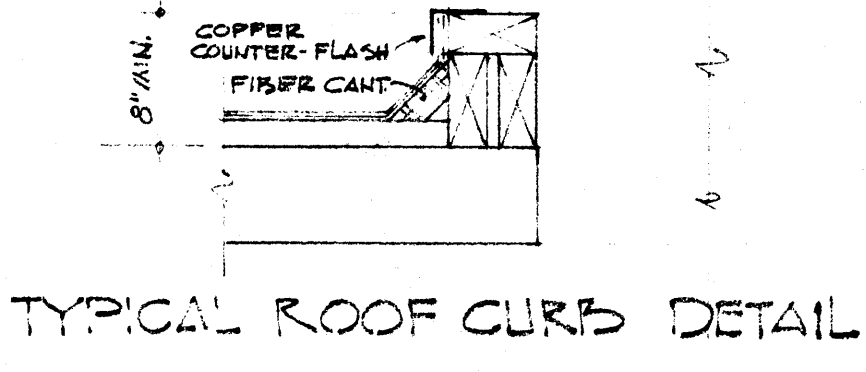

	DATE	2-21-66	RENOVATIONS TO WILSON HALL ARKANSAS STATE COLLEGE JONESBORO, ARKANSAS	SHEET NUMBER
	DRAWN BY	JDA		STUCK, FRIER, LANE & SCOTT, INC., ARCHITECTS 601 SOUTHWEST DRIVE • JONESBORO, ARKANSAS
	CHECKED BY			
	REVISIONS			

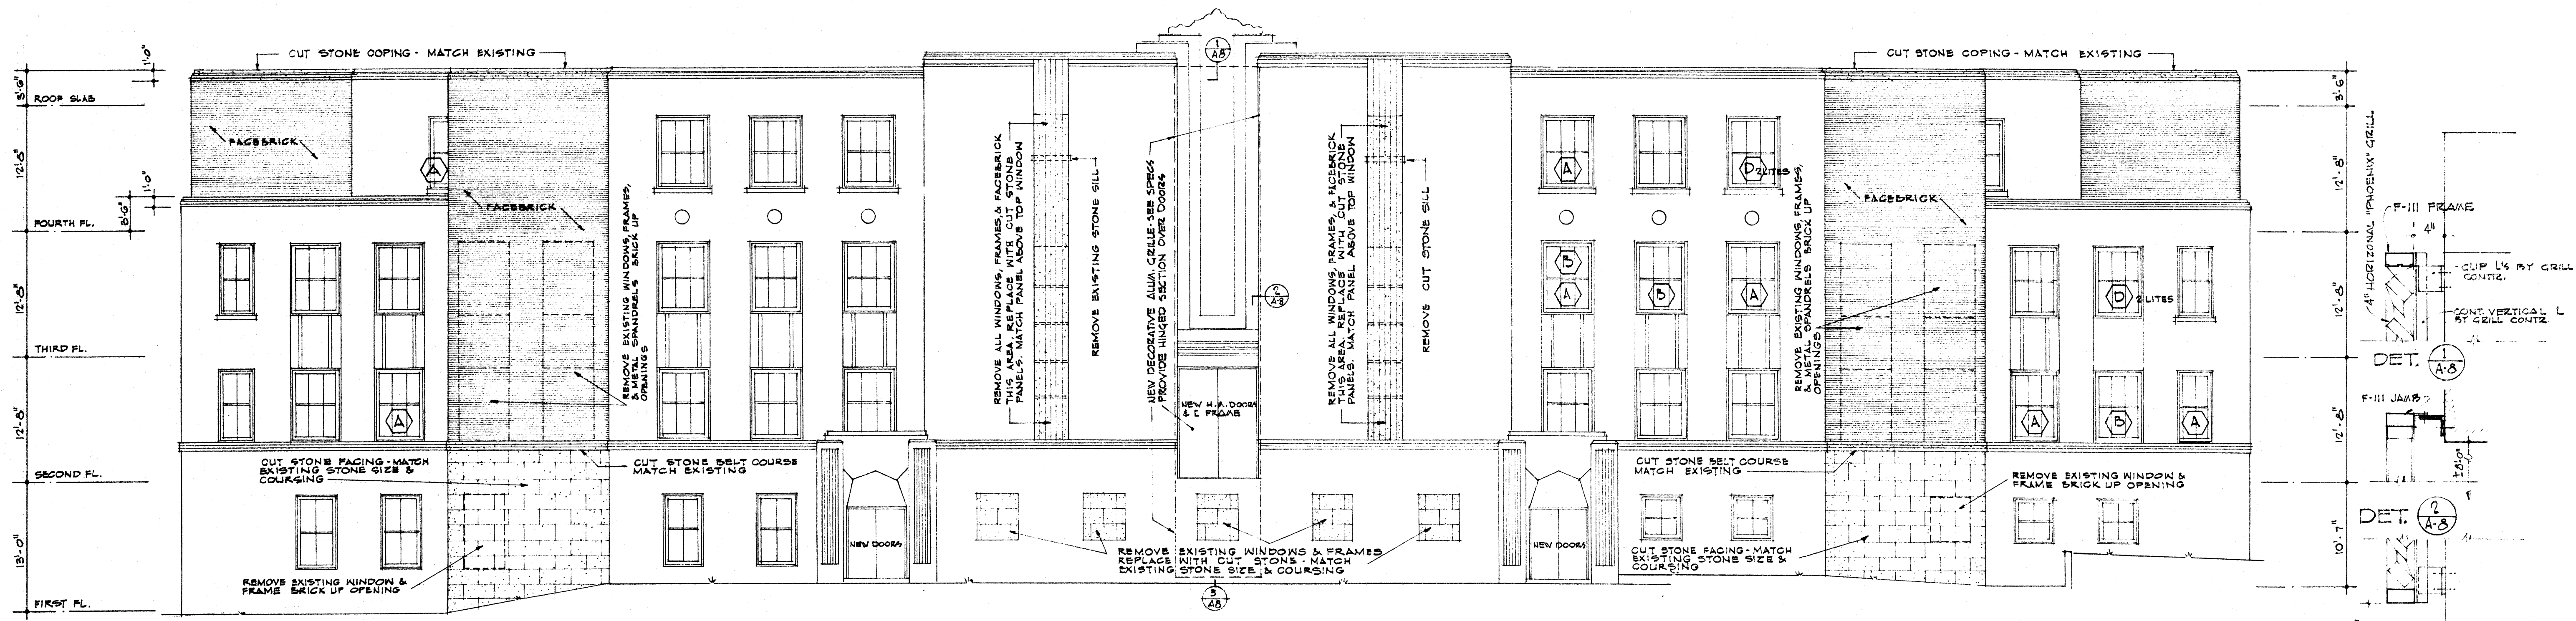


S O U T H E L E V A T I O N SCALE 1/8" = 1'-0"

EXISTING WINDOW LEGEND


- (A) NEW LOWER SASH
- (B) NEW UPPER SASH
- (C) NEW OPENING COMPLETE (FRAME, SASH, & TRIM - REUSE STOOL)
- (D) REGLAZE NUMBER OF LITES INDICATED

DECORATIVE GRILLE DETAILS
1/2" = 1'-0"

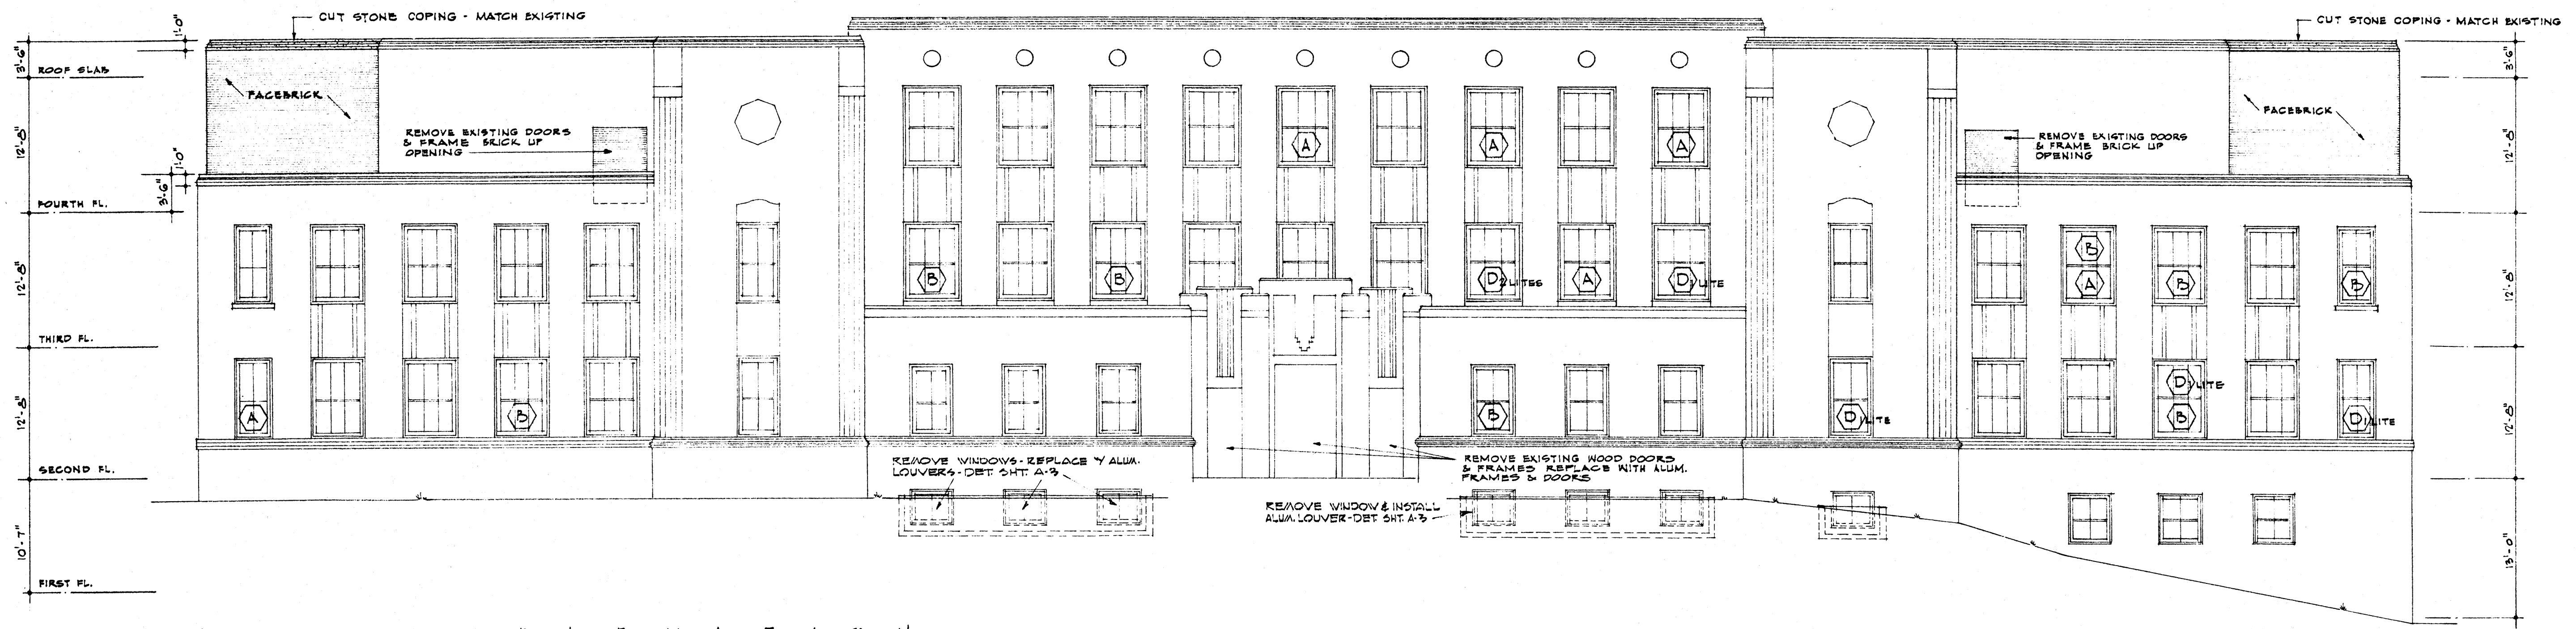

N O R T H E L E V A T I O N SCALE 1/8" = 1'-0"


	DATE 2-21-66	RENOVATIONS TO WILSON HALL ARKANSAS STATE COLLEGE JONESBORO, ARKANSAS	SHEET NUMBER A-8	
	DRAWN BY DEB.HRE		STUCK, FRIER, LANE & SCOTT, INC., ARCHITECTS 601 SOUTHWEST DRIVE • JONESBORO, ARKANSAS	COMMISSION NUMBER 42866
	CHECKED BY			
	REVISIONS			

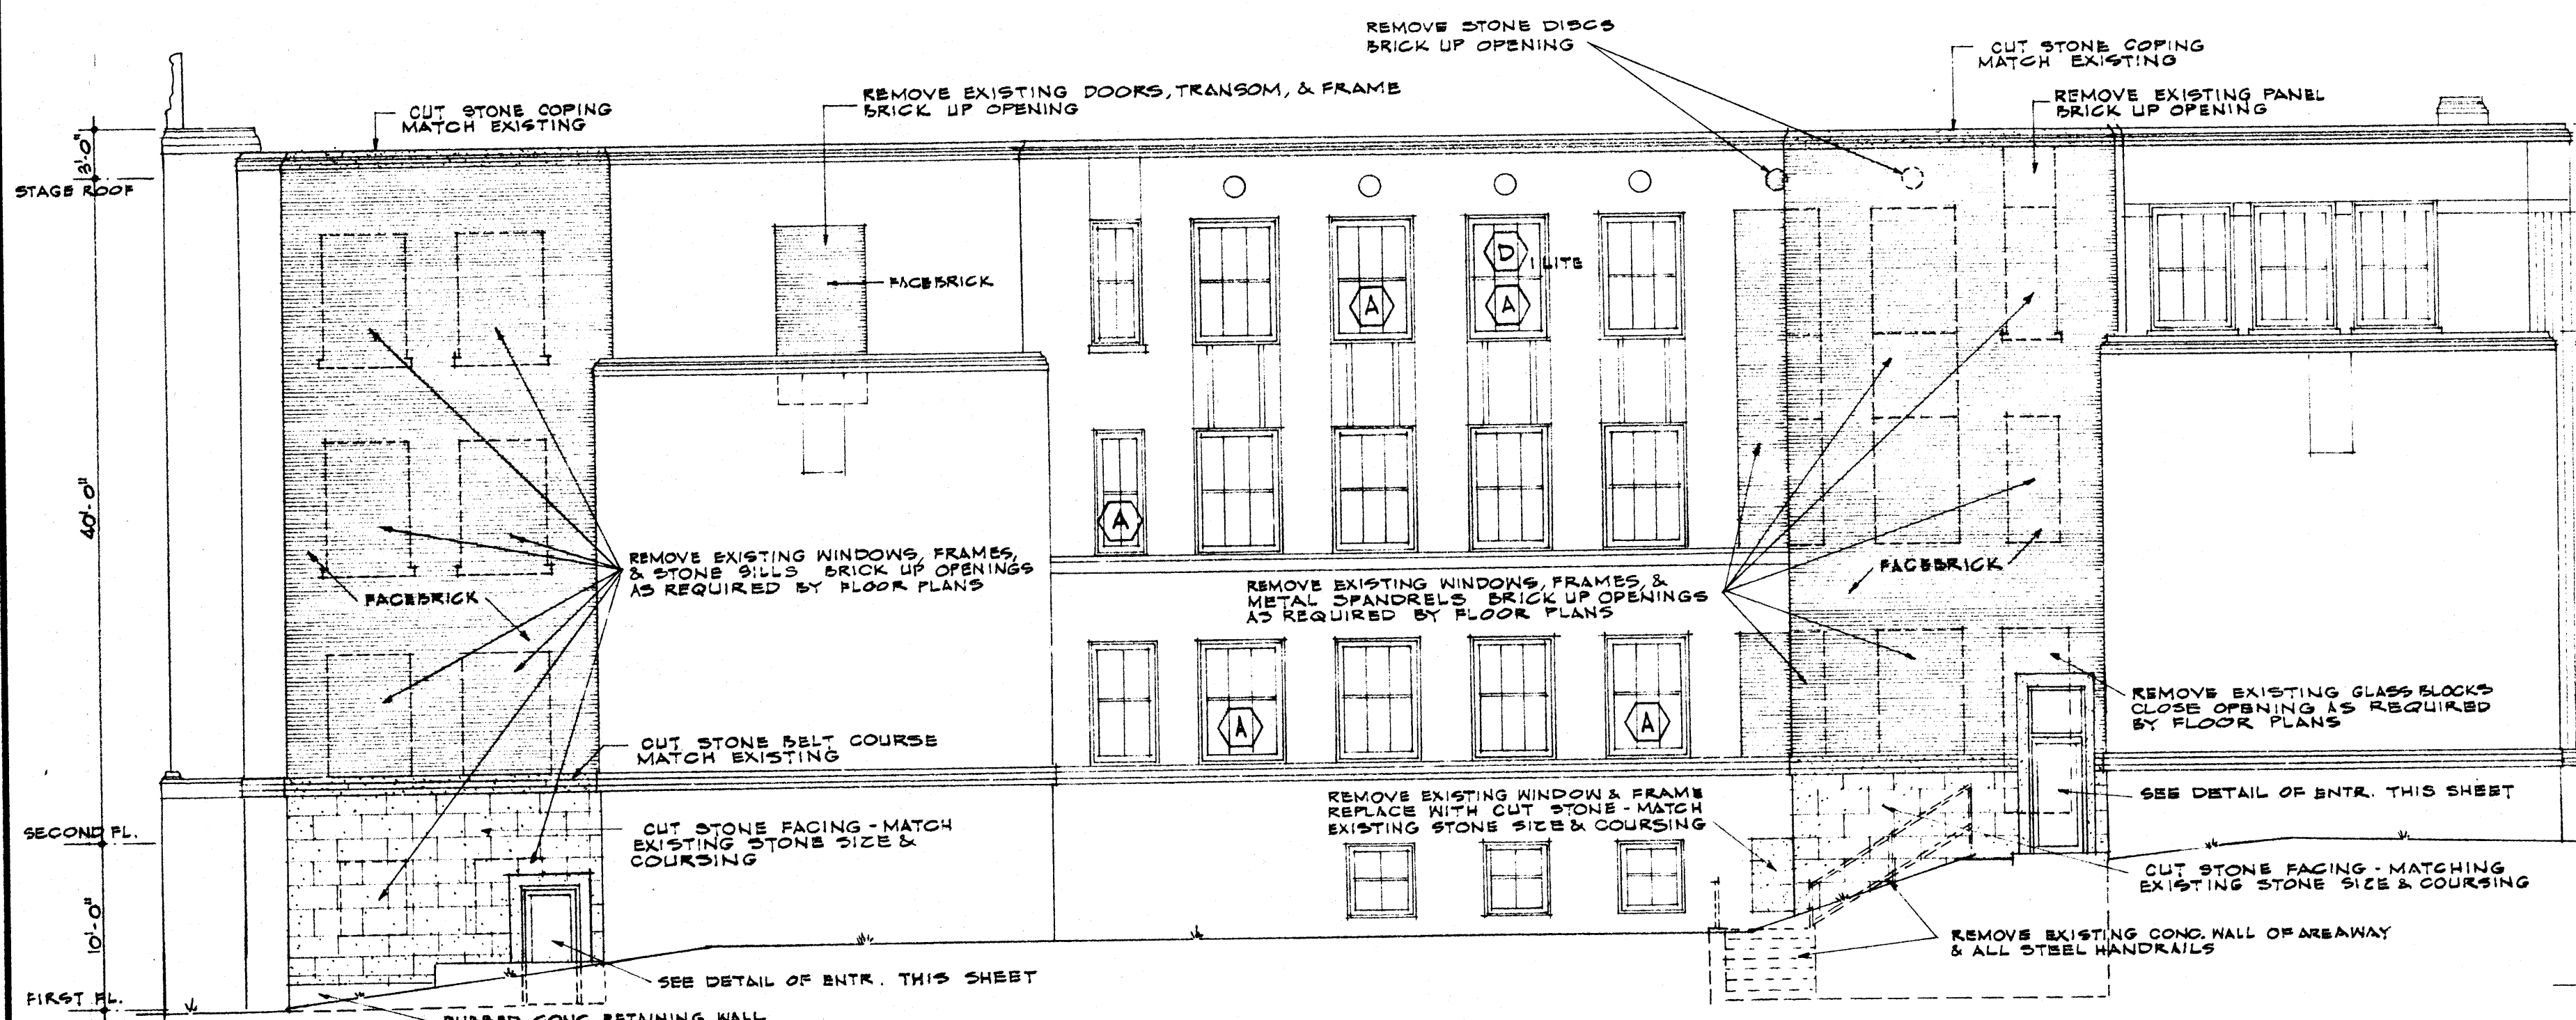







EAST ELEVATION SCALE 1/8" = 1'-0"

EXISTING WINDOW LEGEND








- (A) NEW LOWER SASH
- (B) NEW UPPER SASH
- (C) NEW OPENING COMPLETE (FRAME, SASH, & TRIM - REUSE STOOD)
- (D) REGLAZE NUMBER OF LITES INDICATED

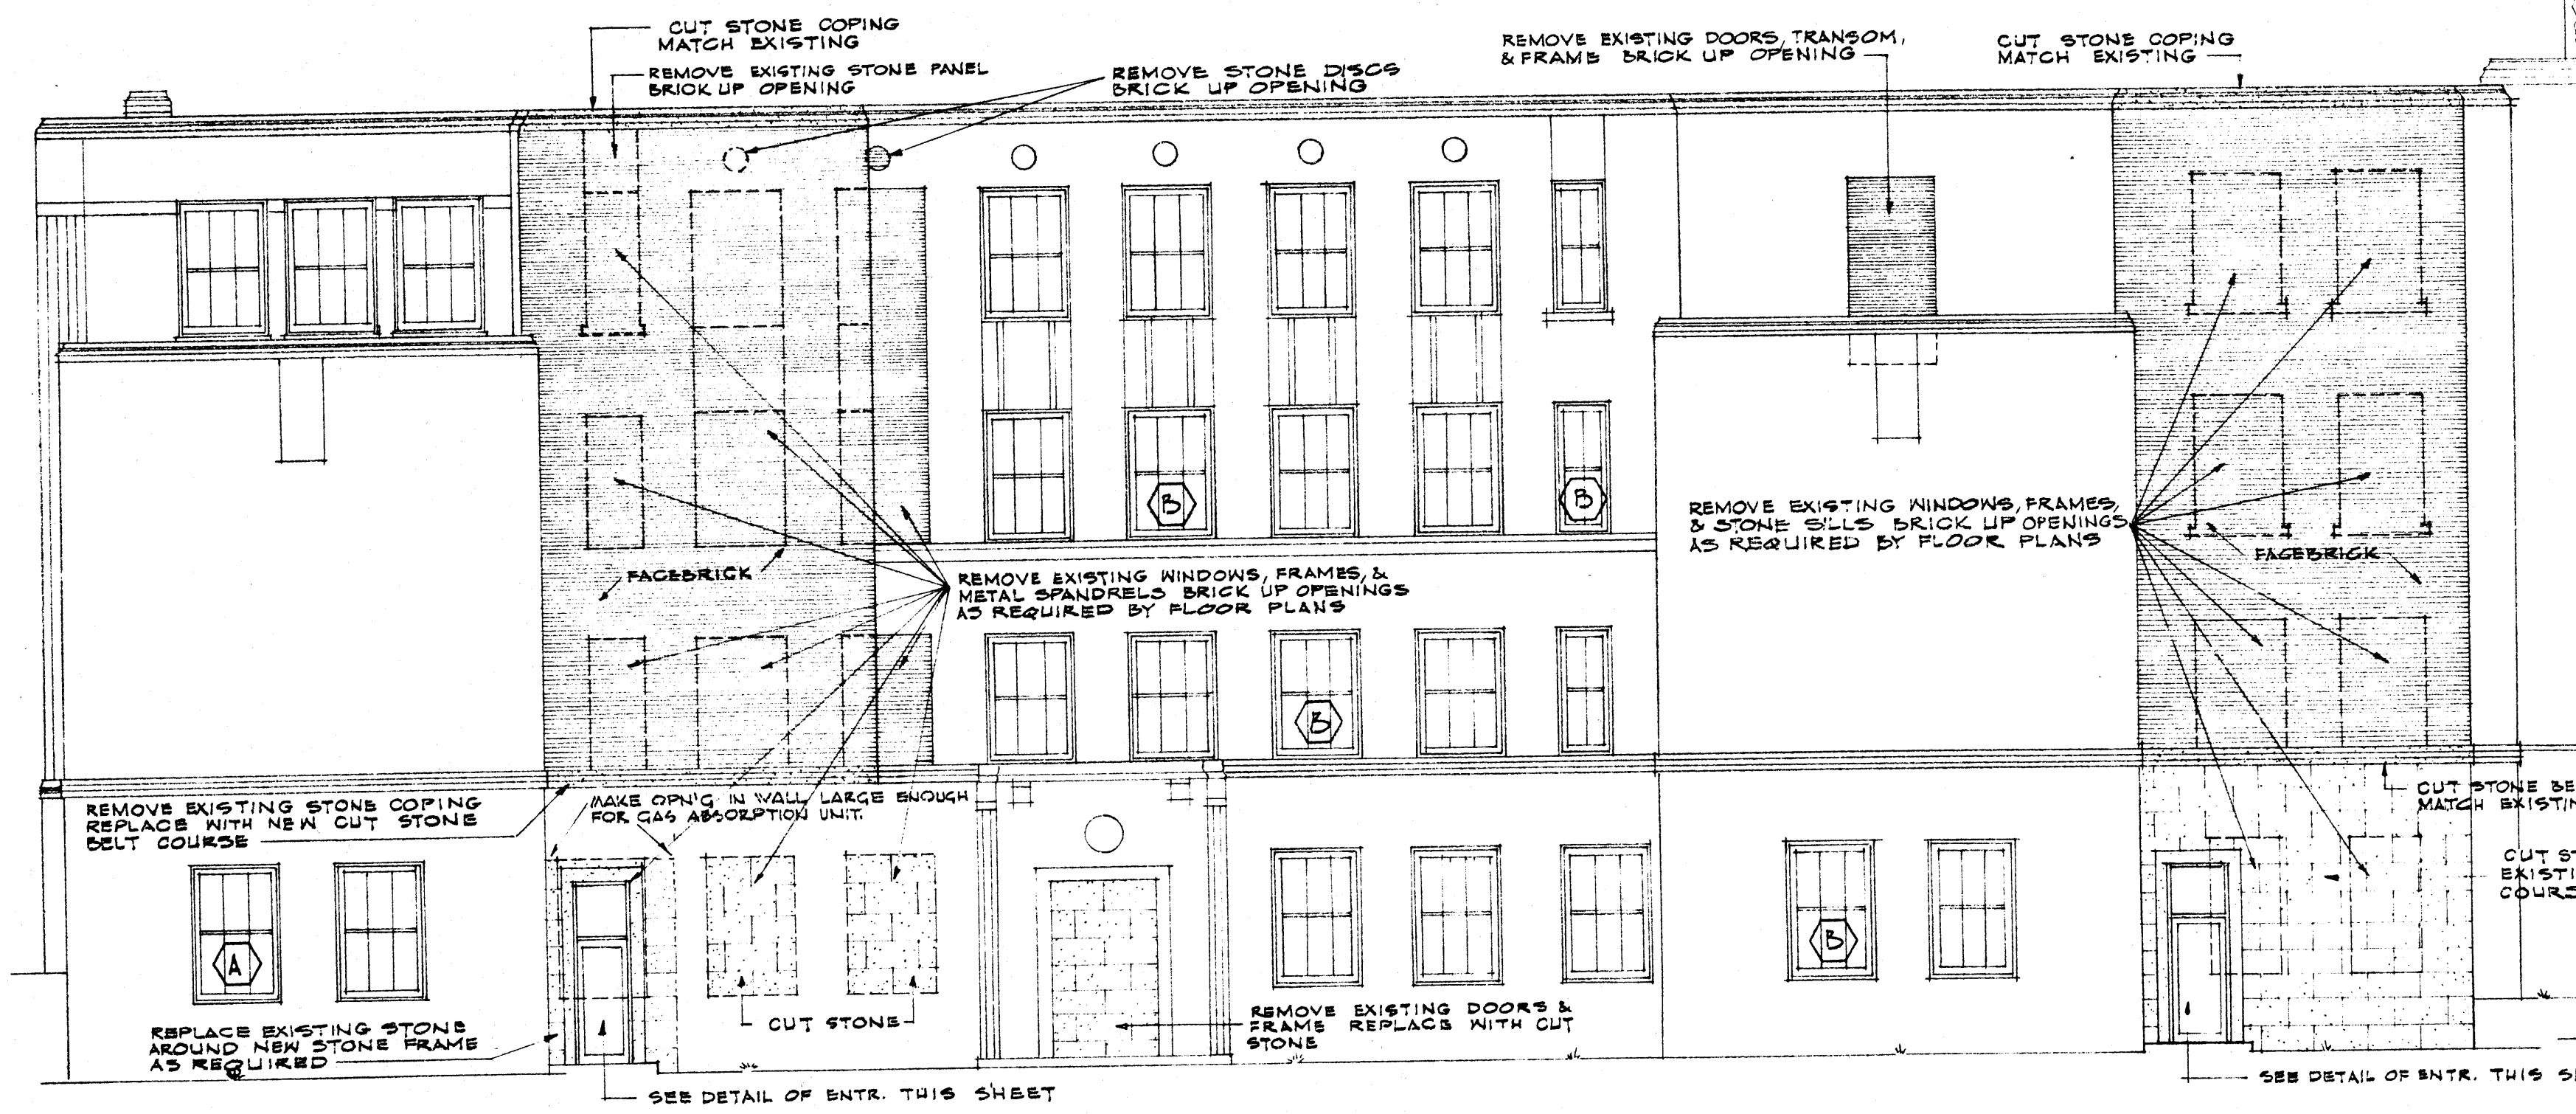







WEST ELEVATION SCALE 1/8" = 1'-0"

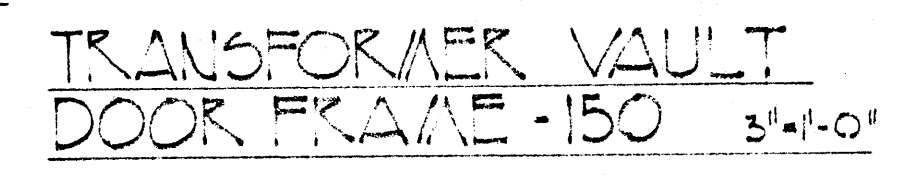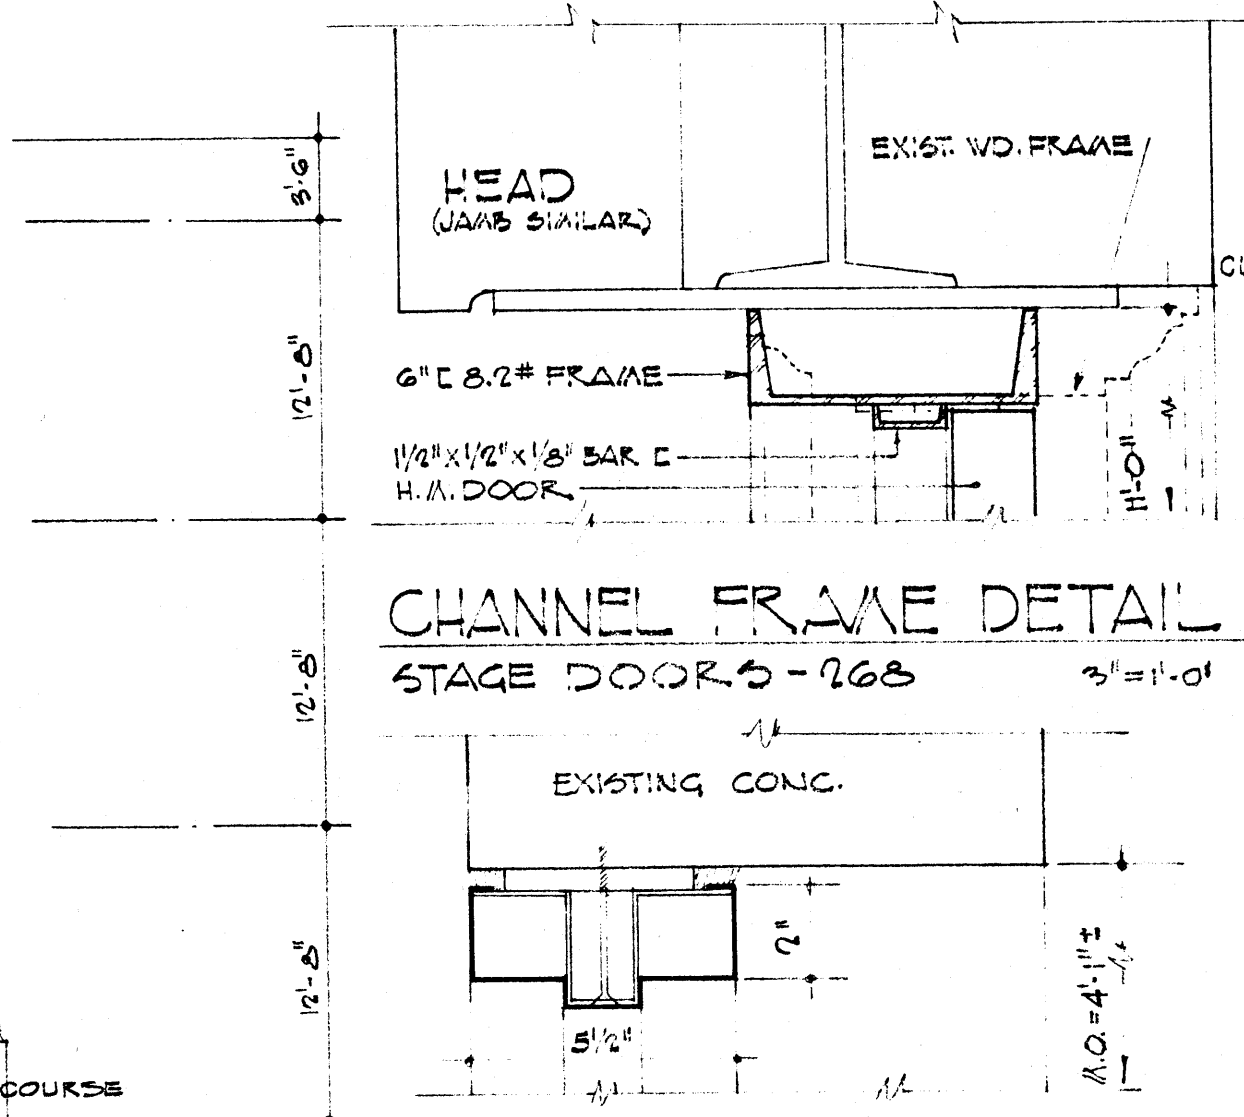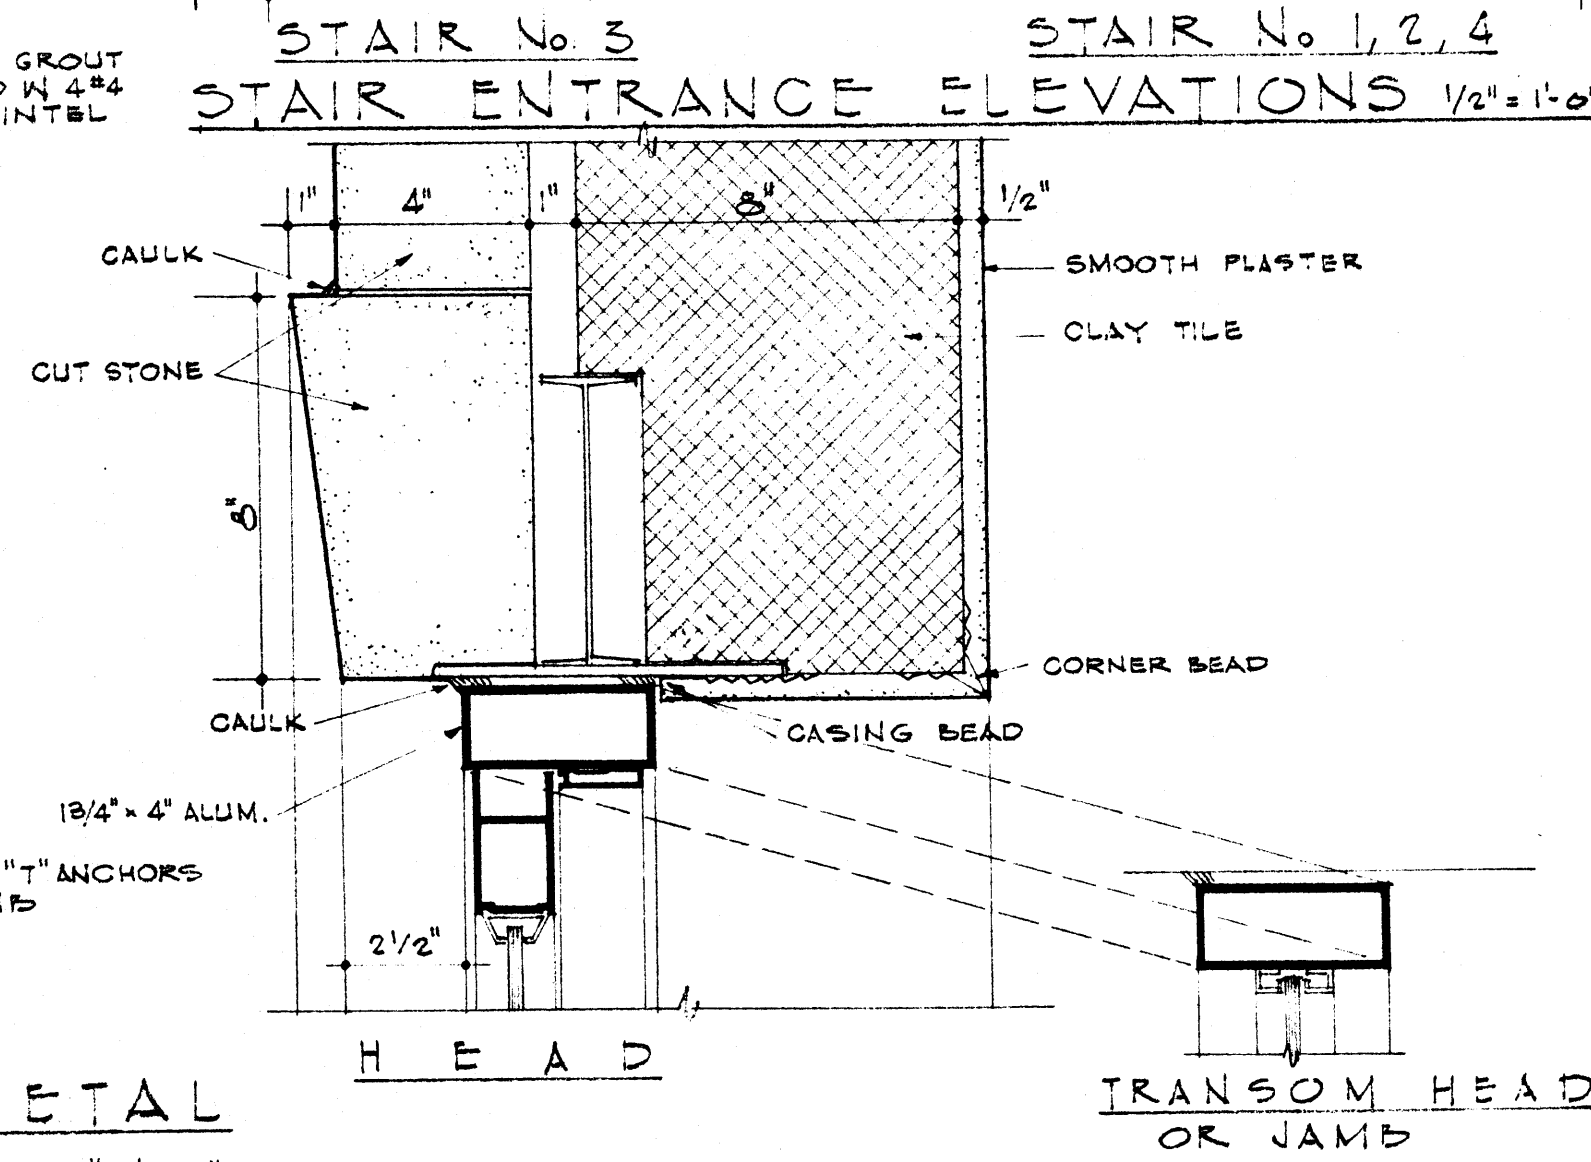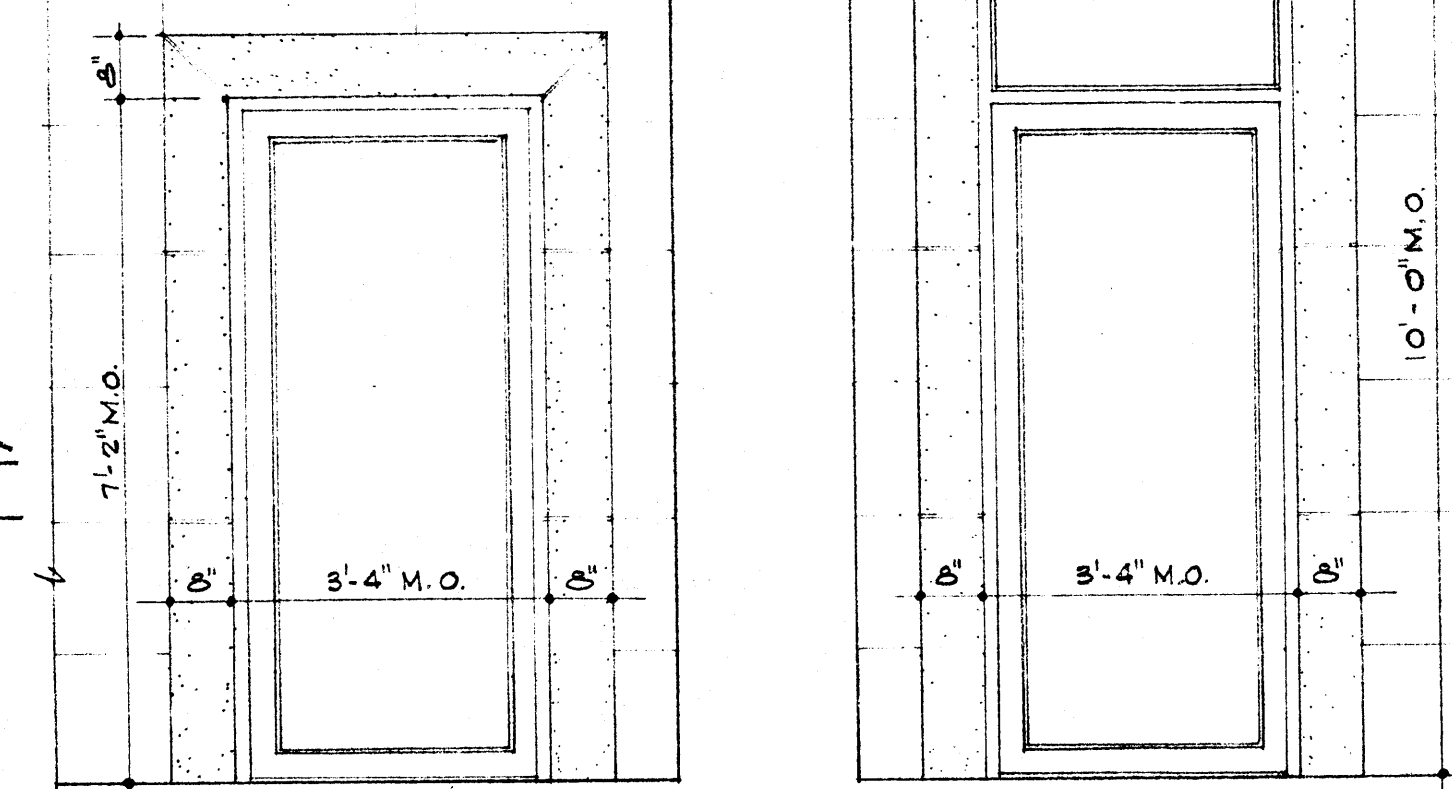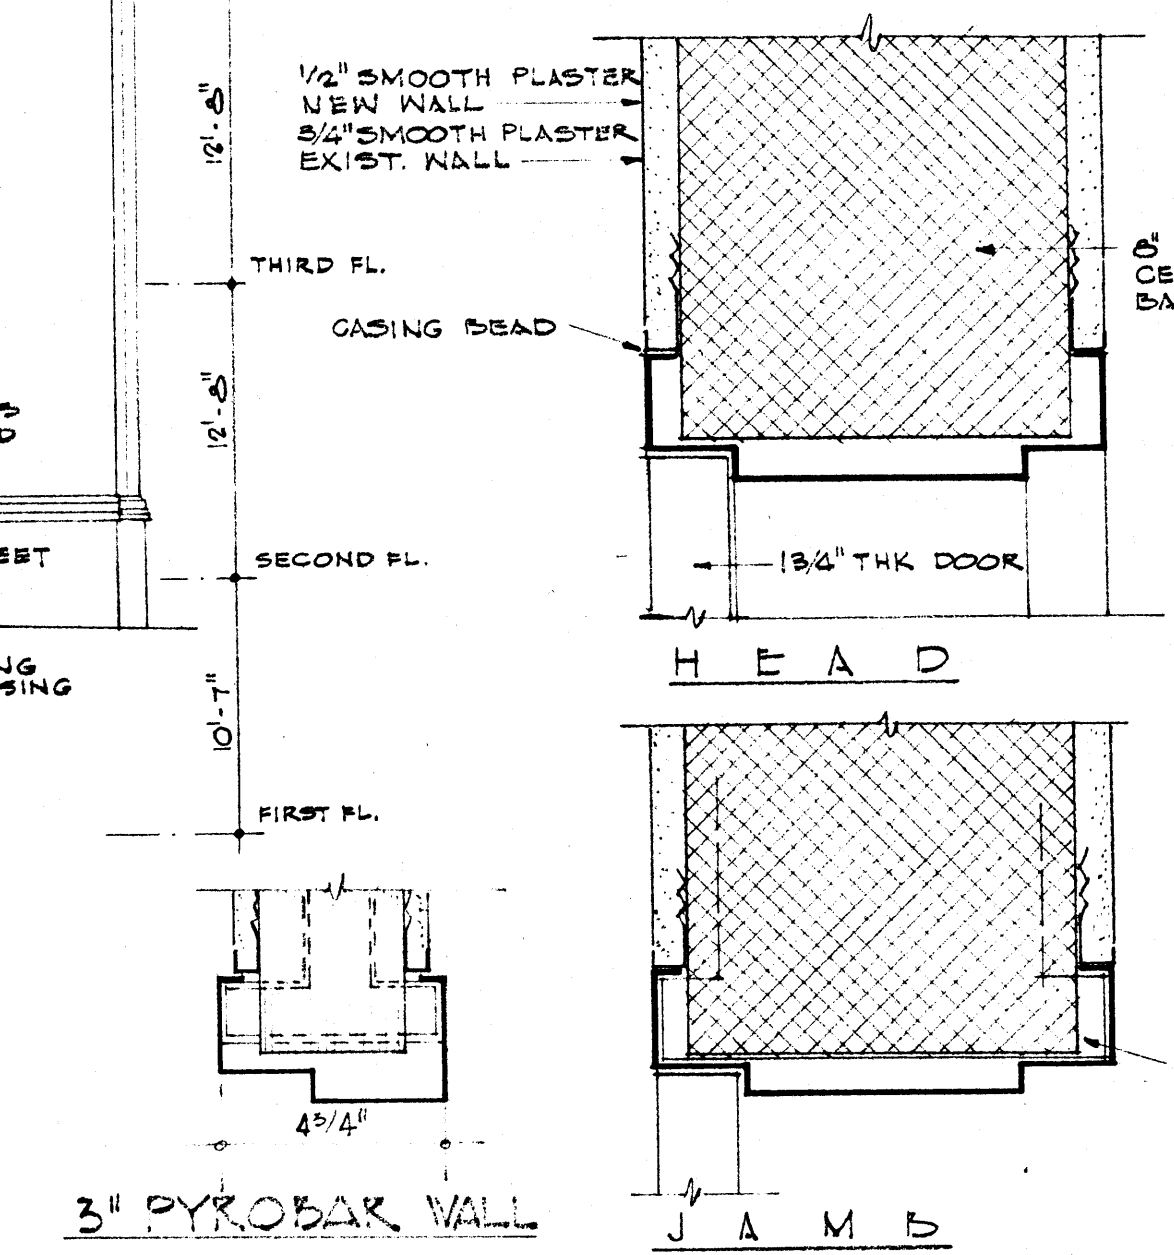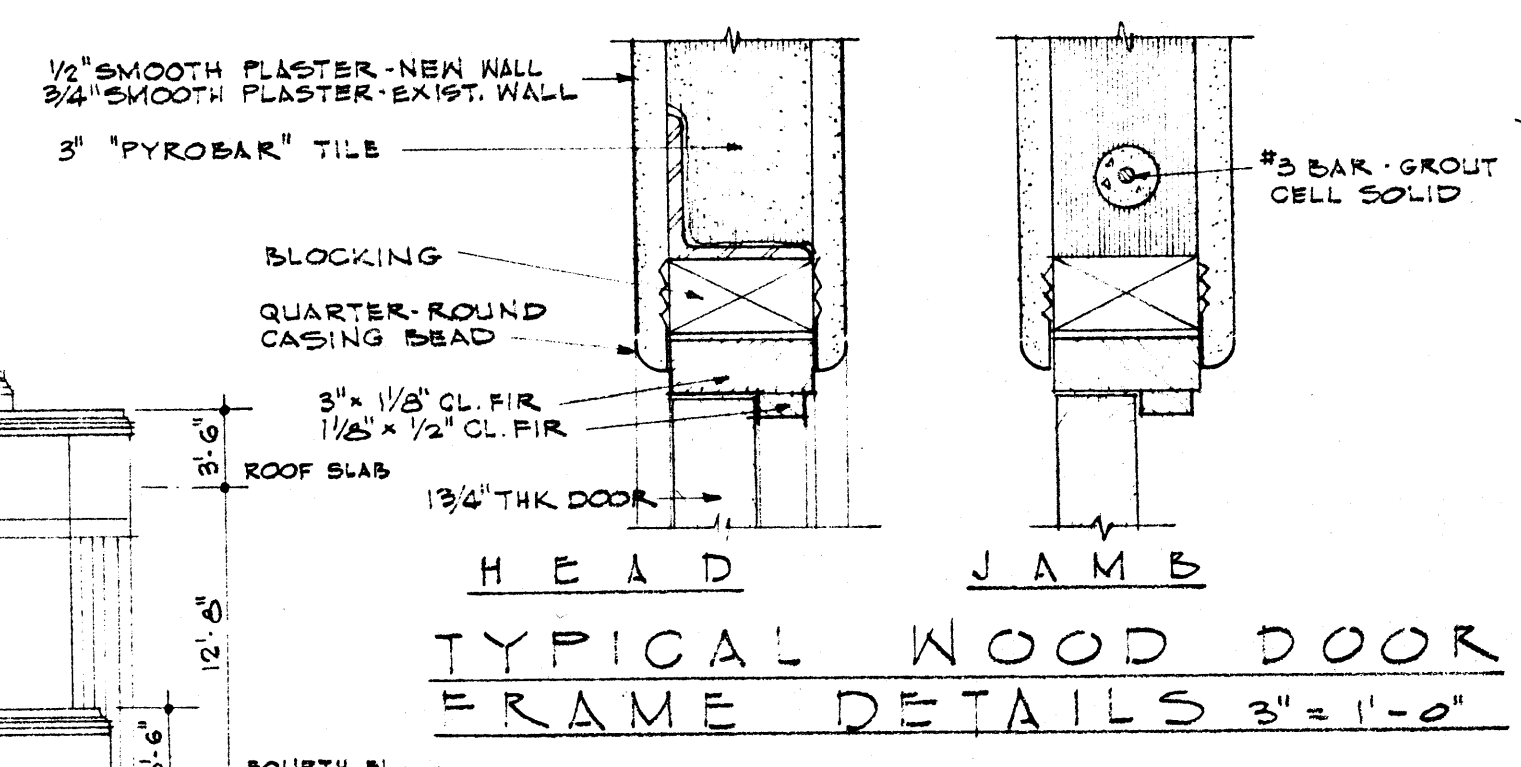

	DATE 2-21-66	RENOVATIONS TO WILSON HALL ARKANSAS STATE COLLEGE JONESBORO, ARKANSAS	SHEET NUMBER A-9	
	DRAWN BY DEB. HRS		STUCK, FRIER, LANE & SCOTT, INC., ARCHITECTS 601 SOUTHWEST DRIVE • JONESBORO, ARKANSAS	COMMISSION NUMBER 43806
	CHECKED BY			
	REVISIONS			

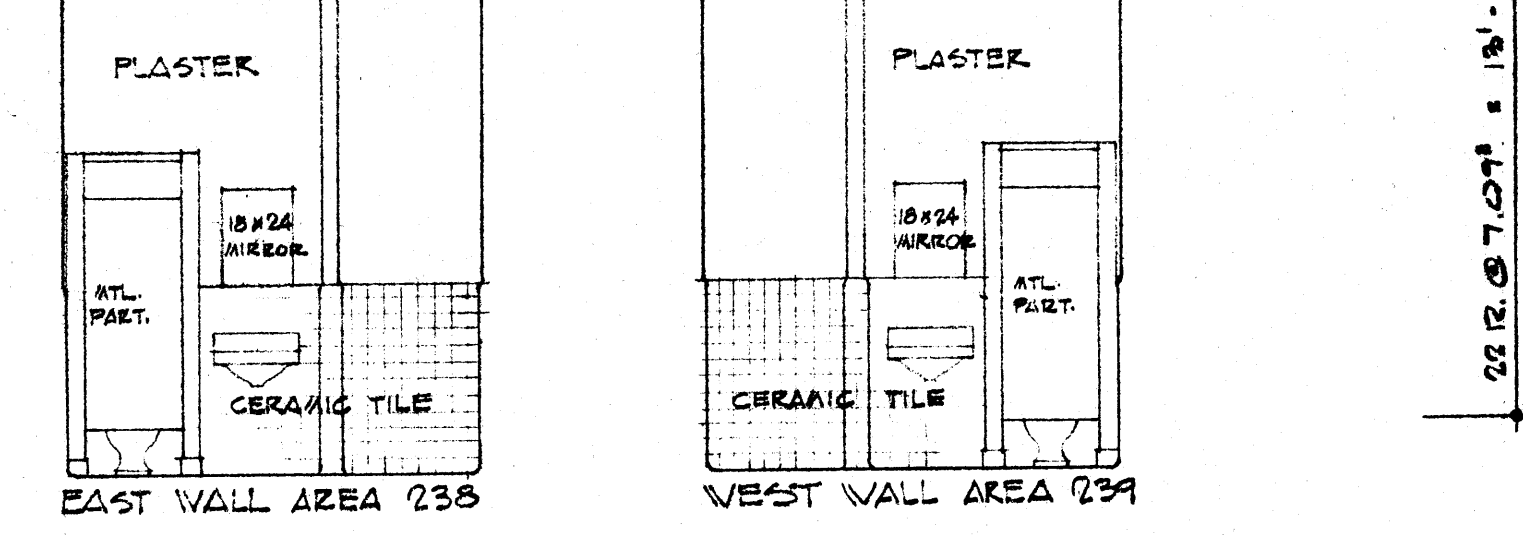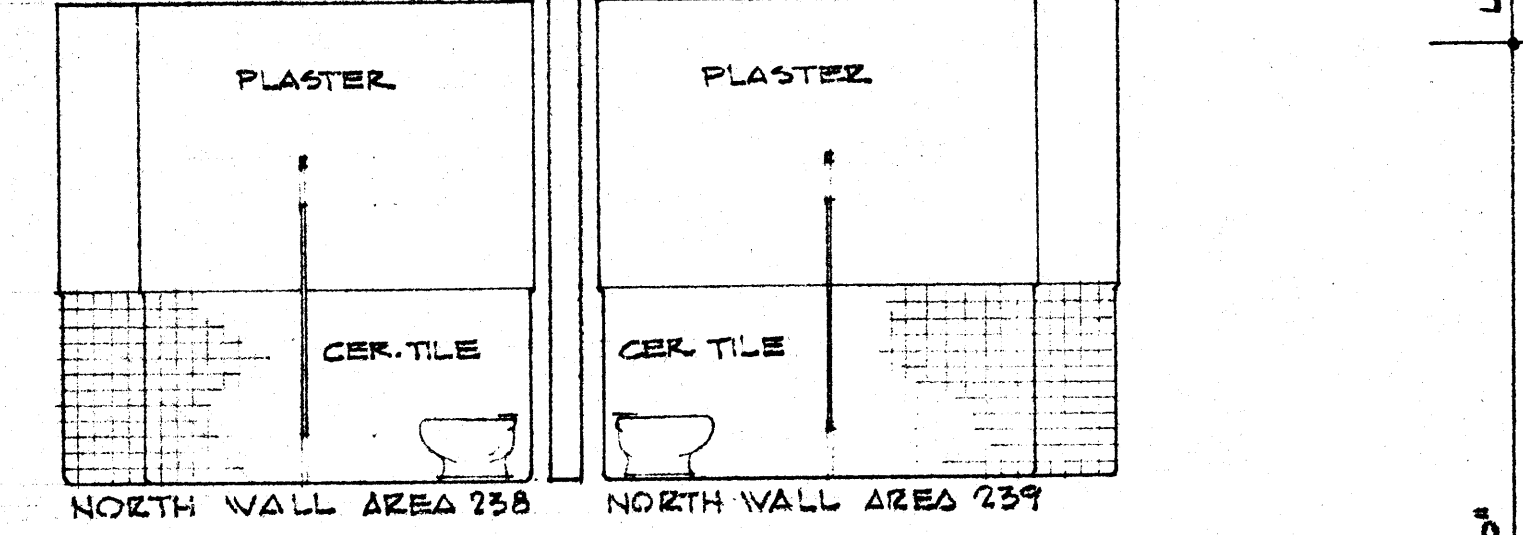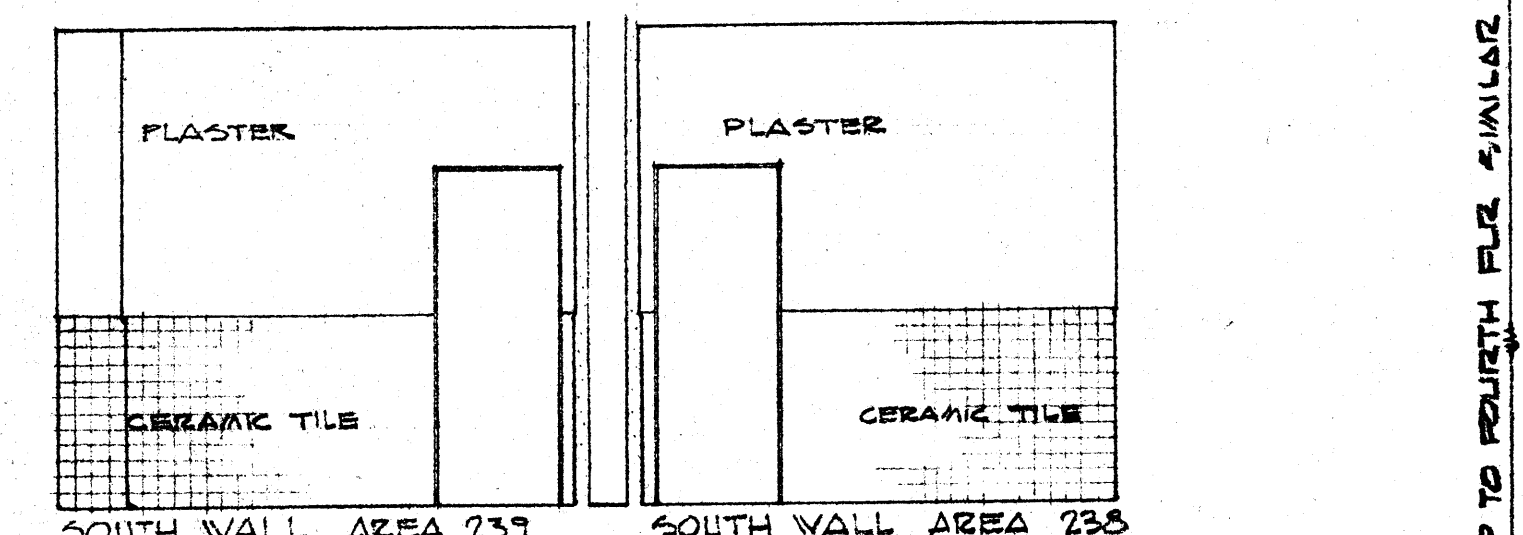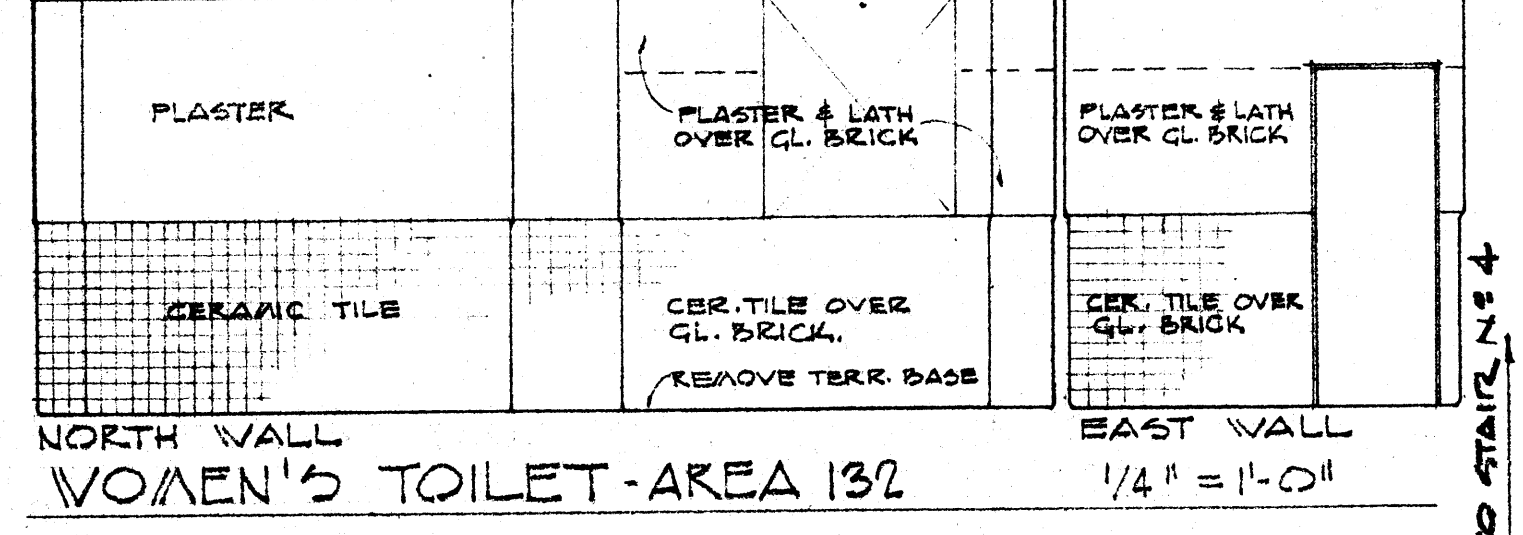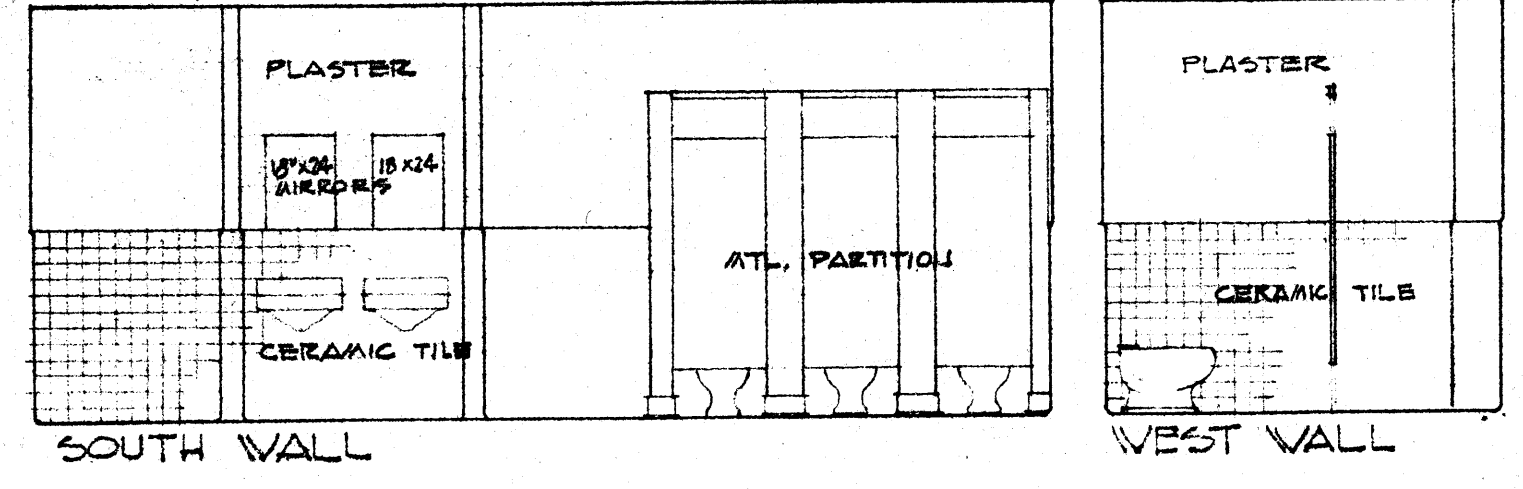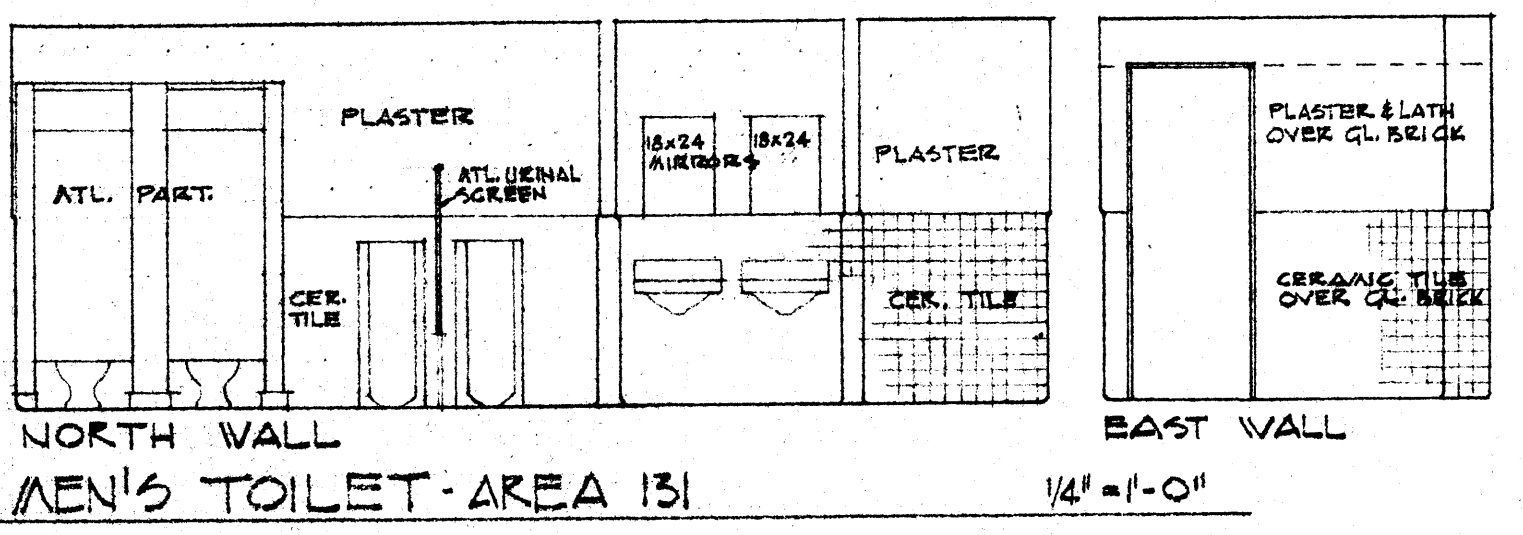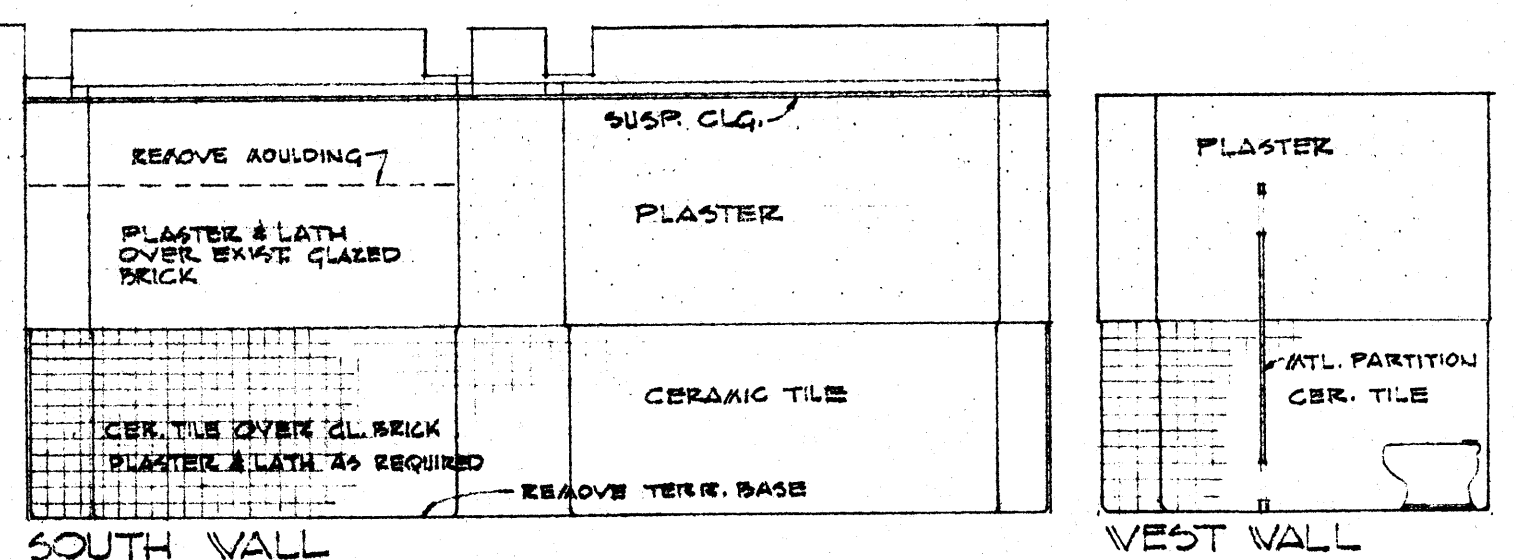


MEN'S TOILET - AREA 238
 WOMEN'S TOILET - AREA 239
 SCALE: 1/4" = 1'-0"

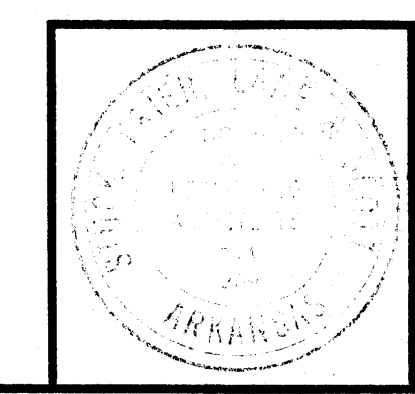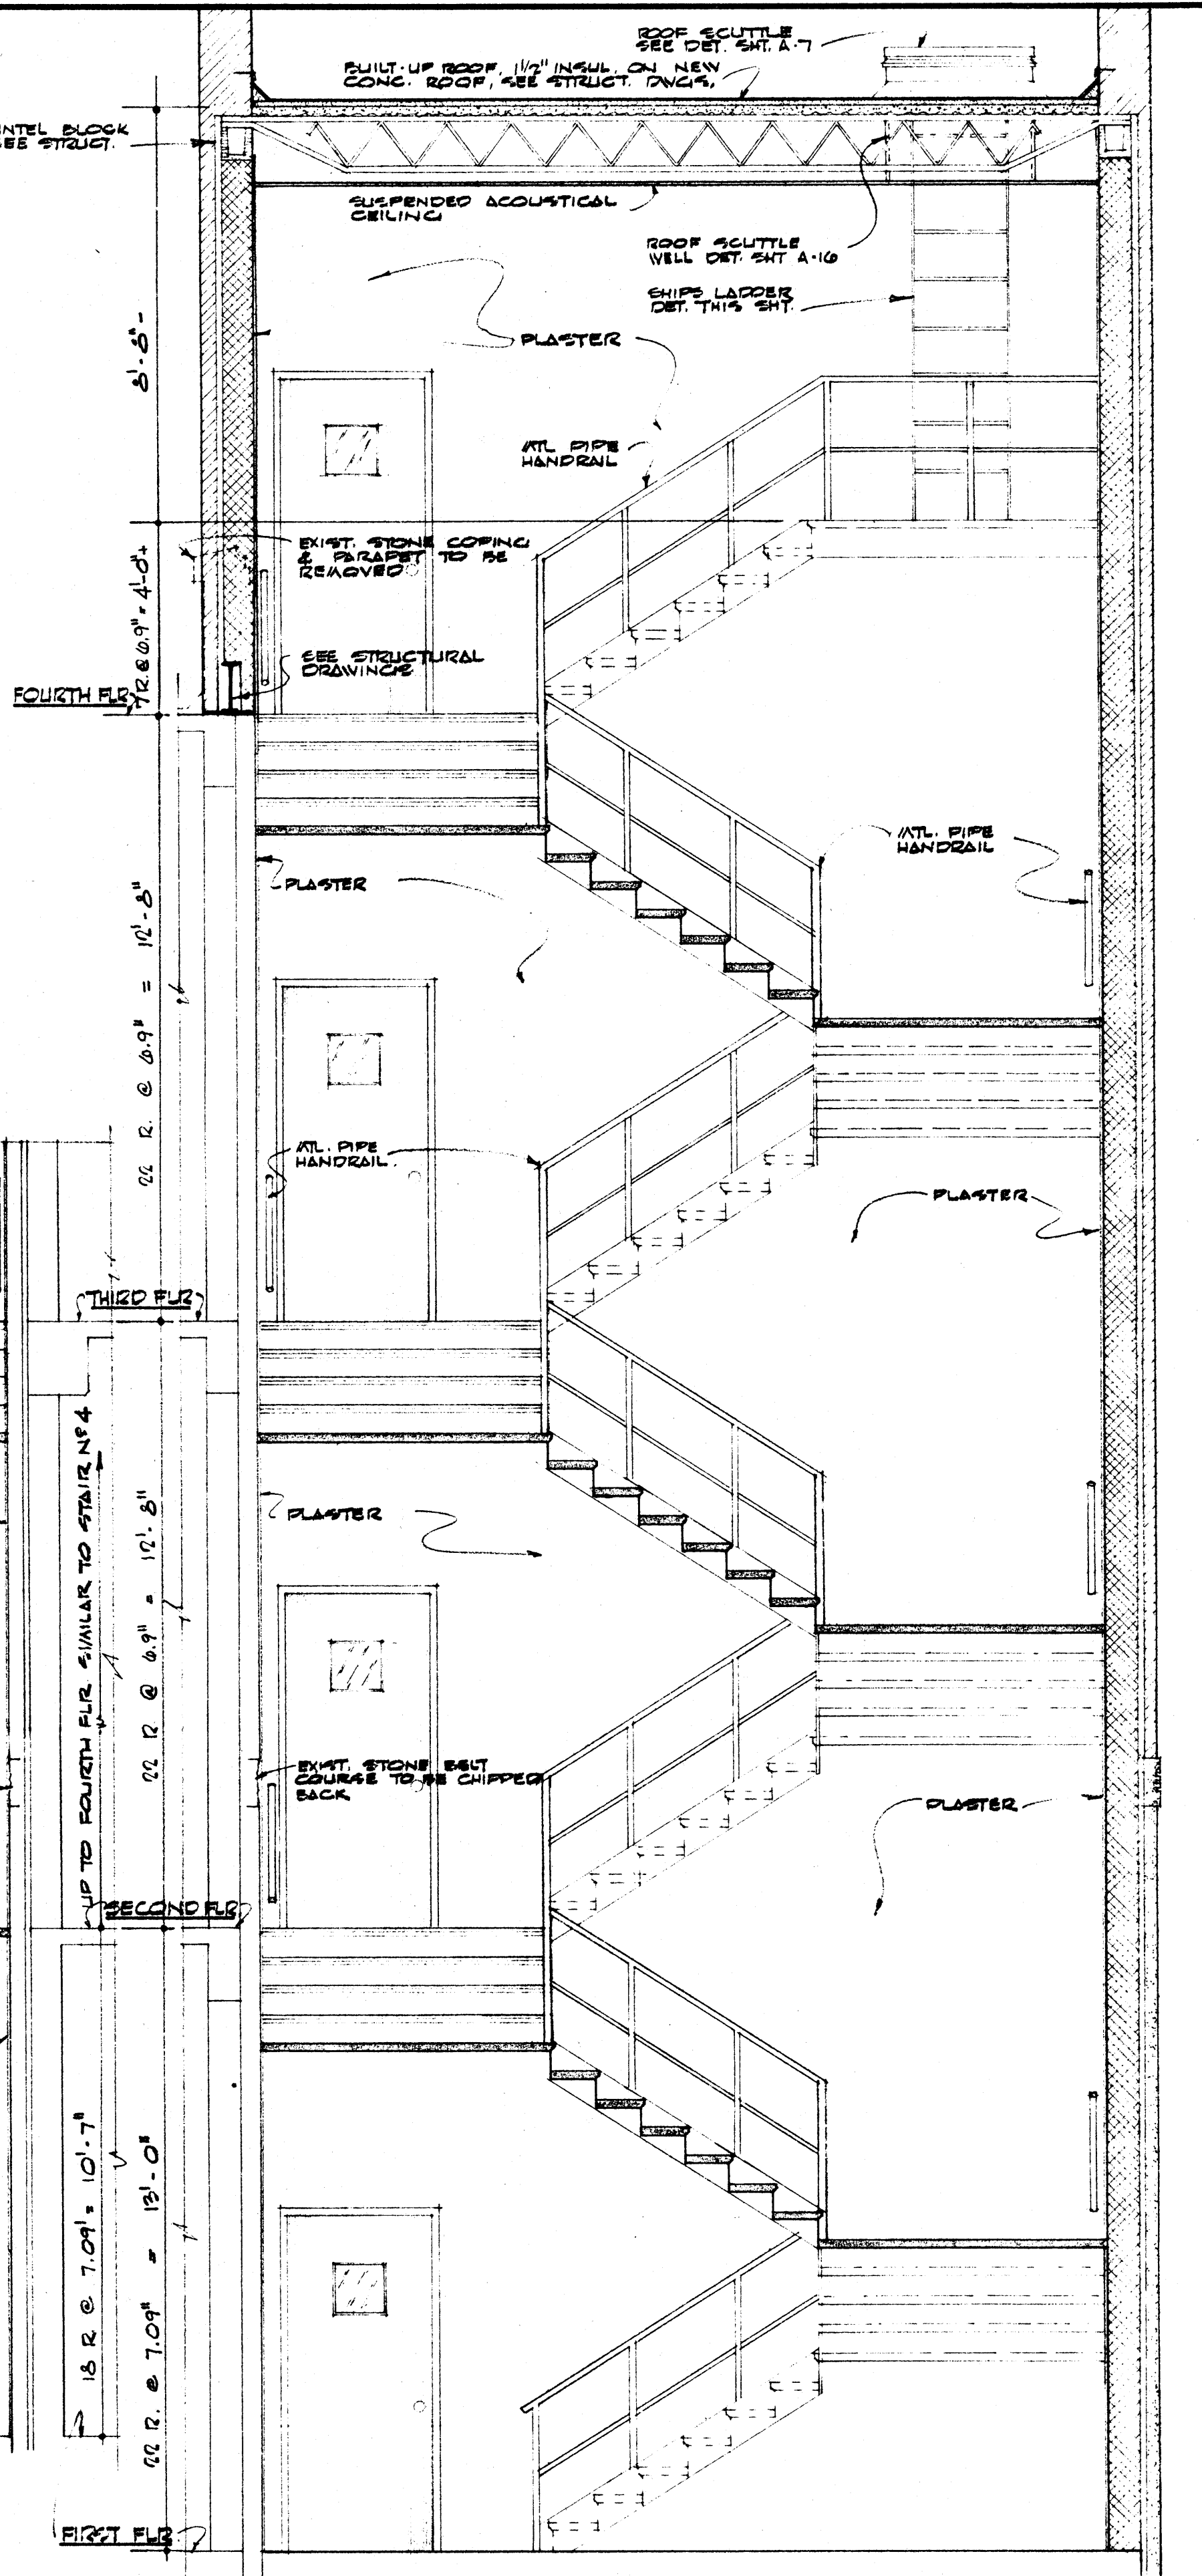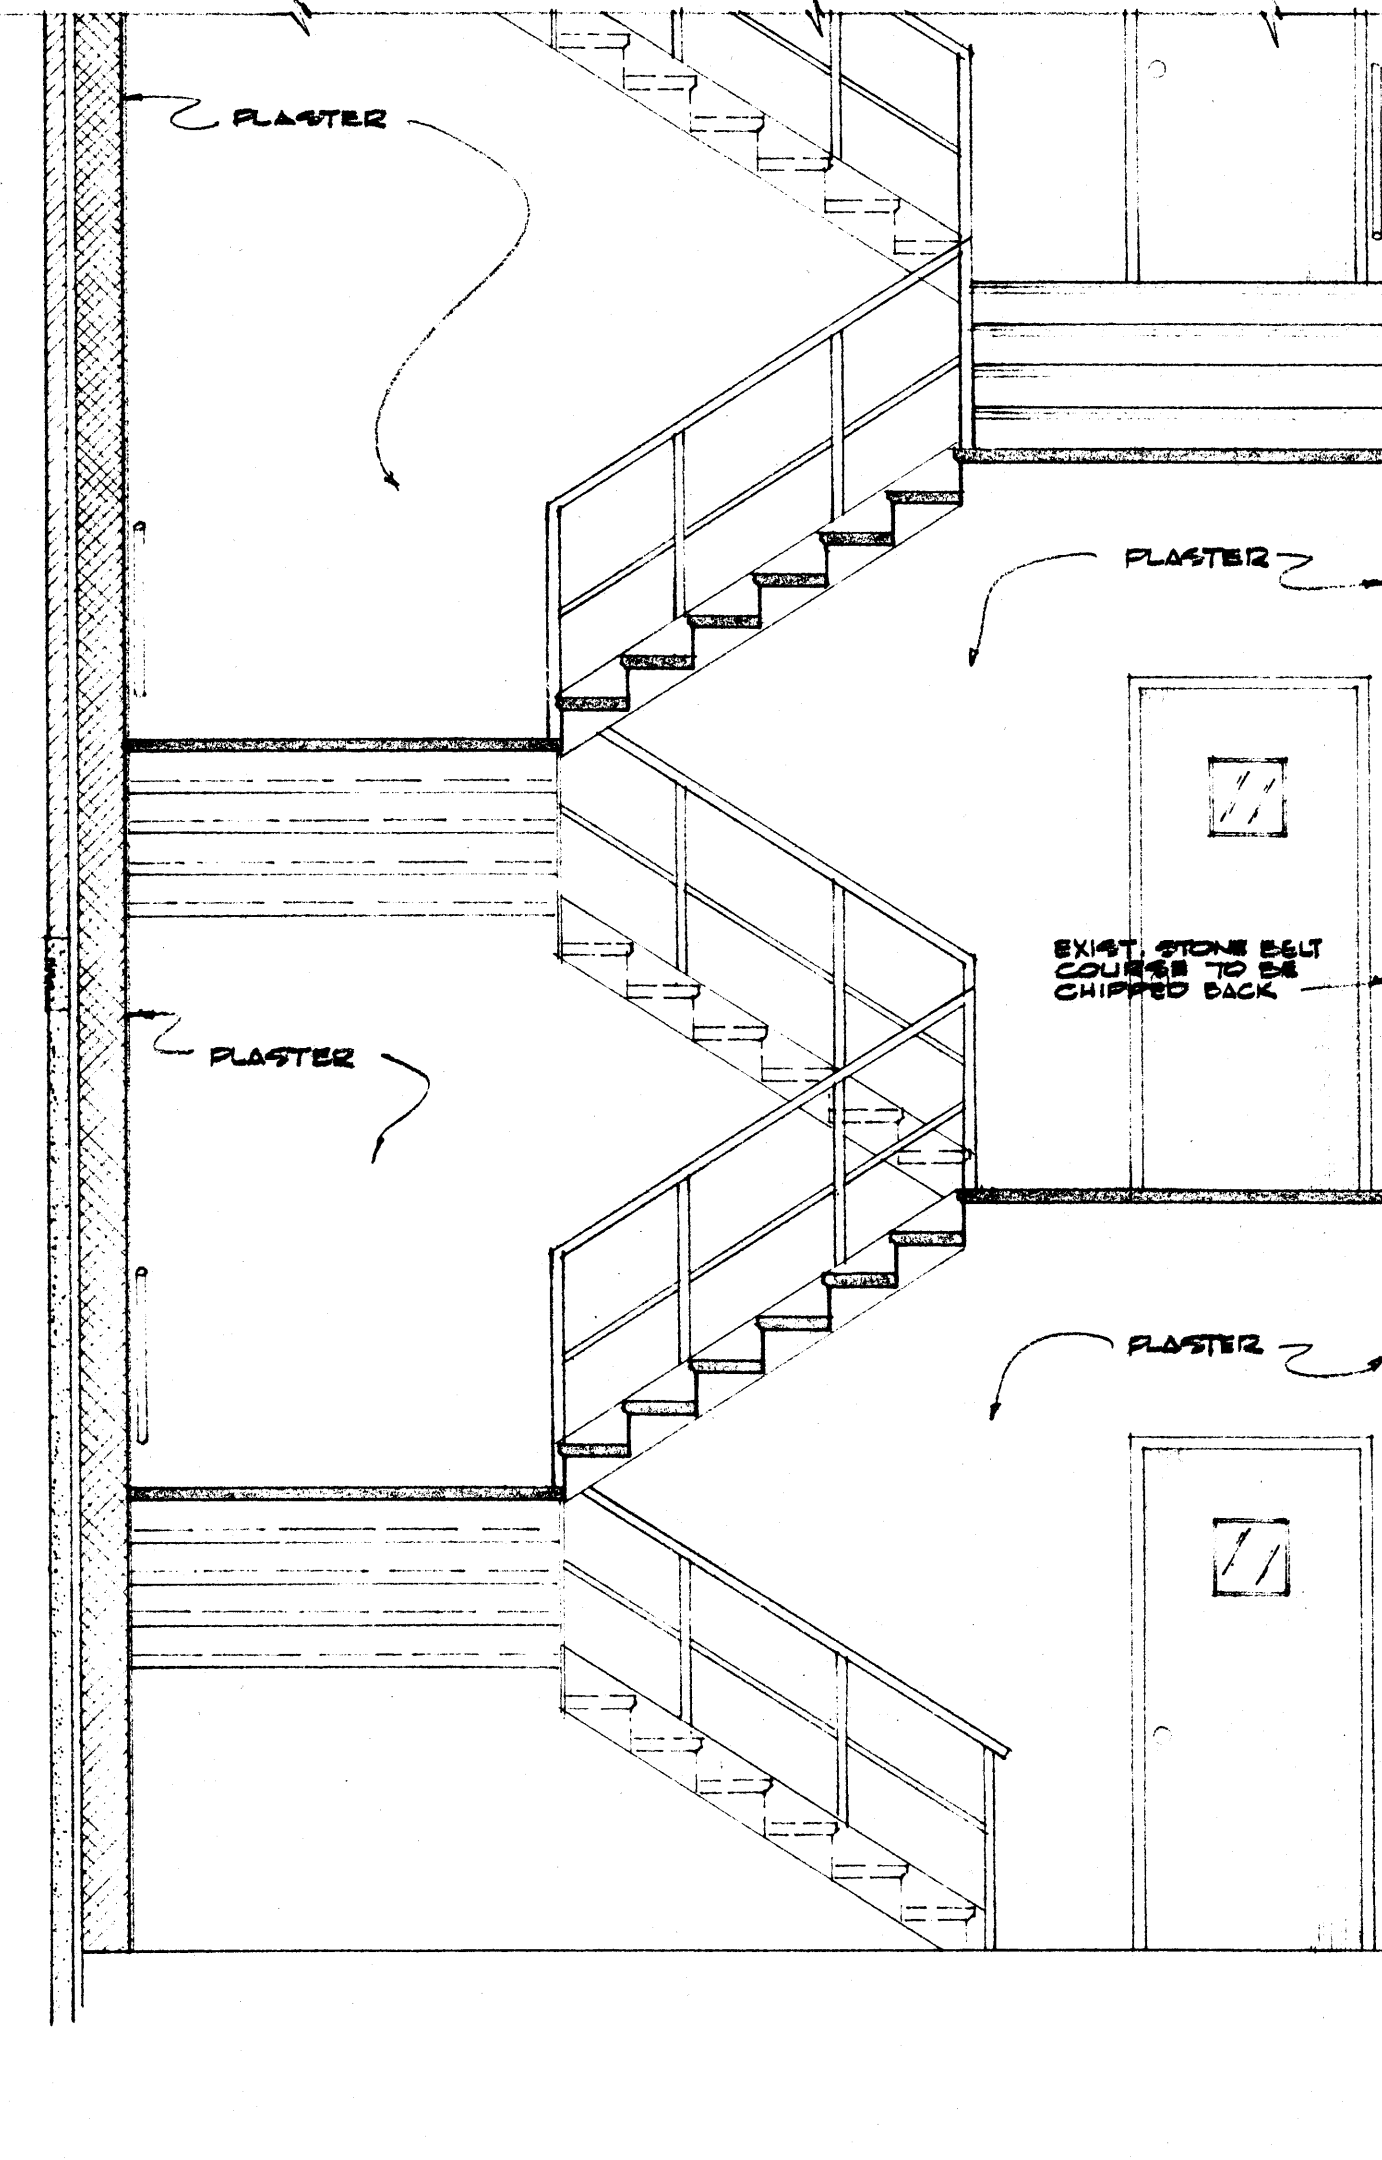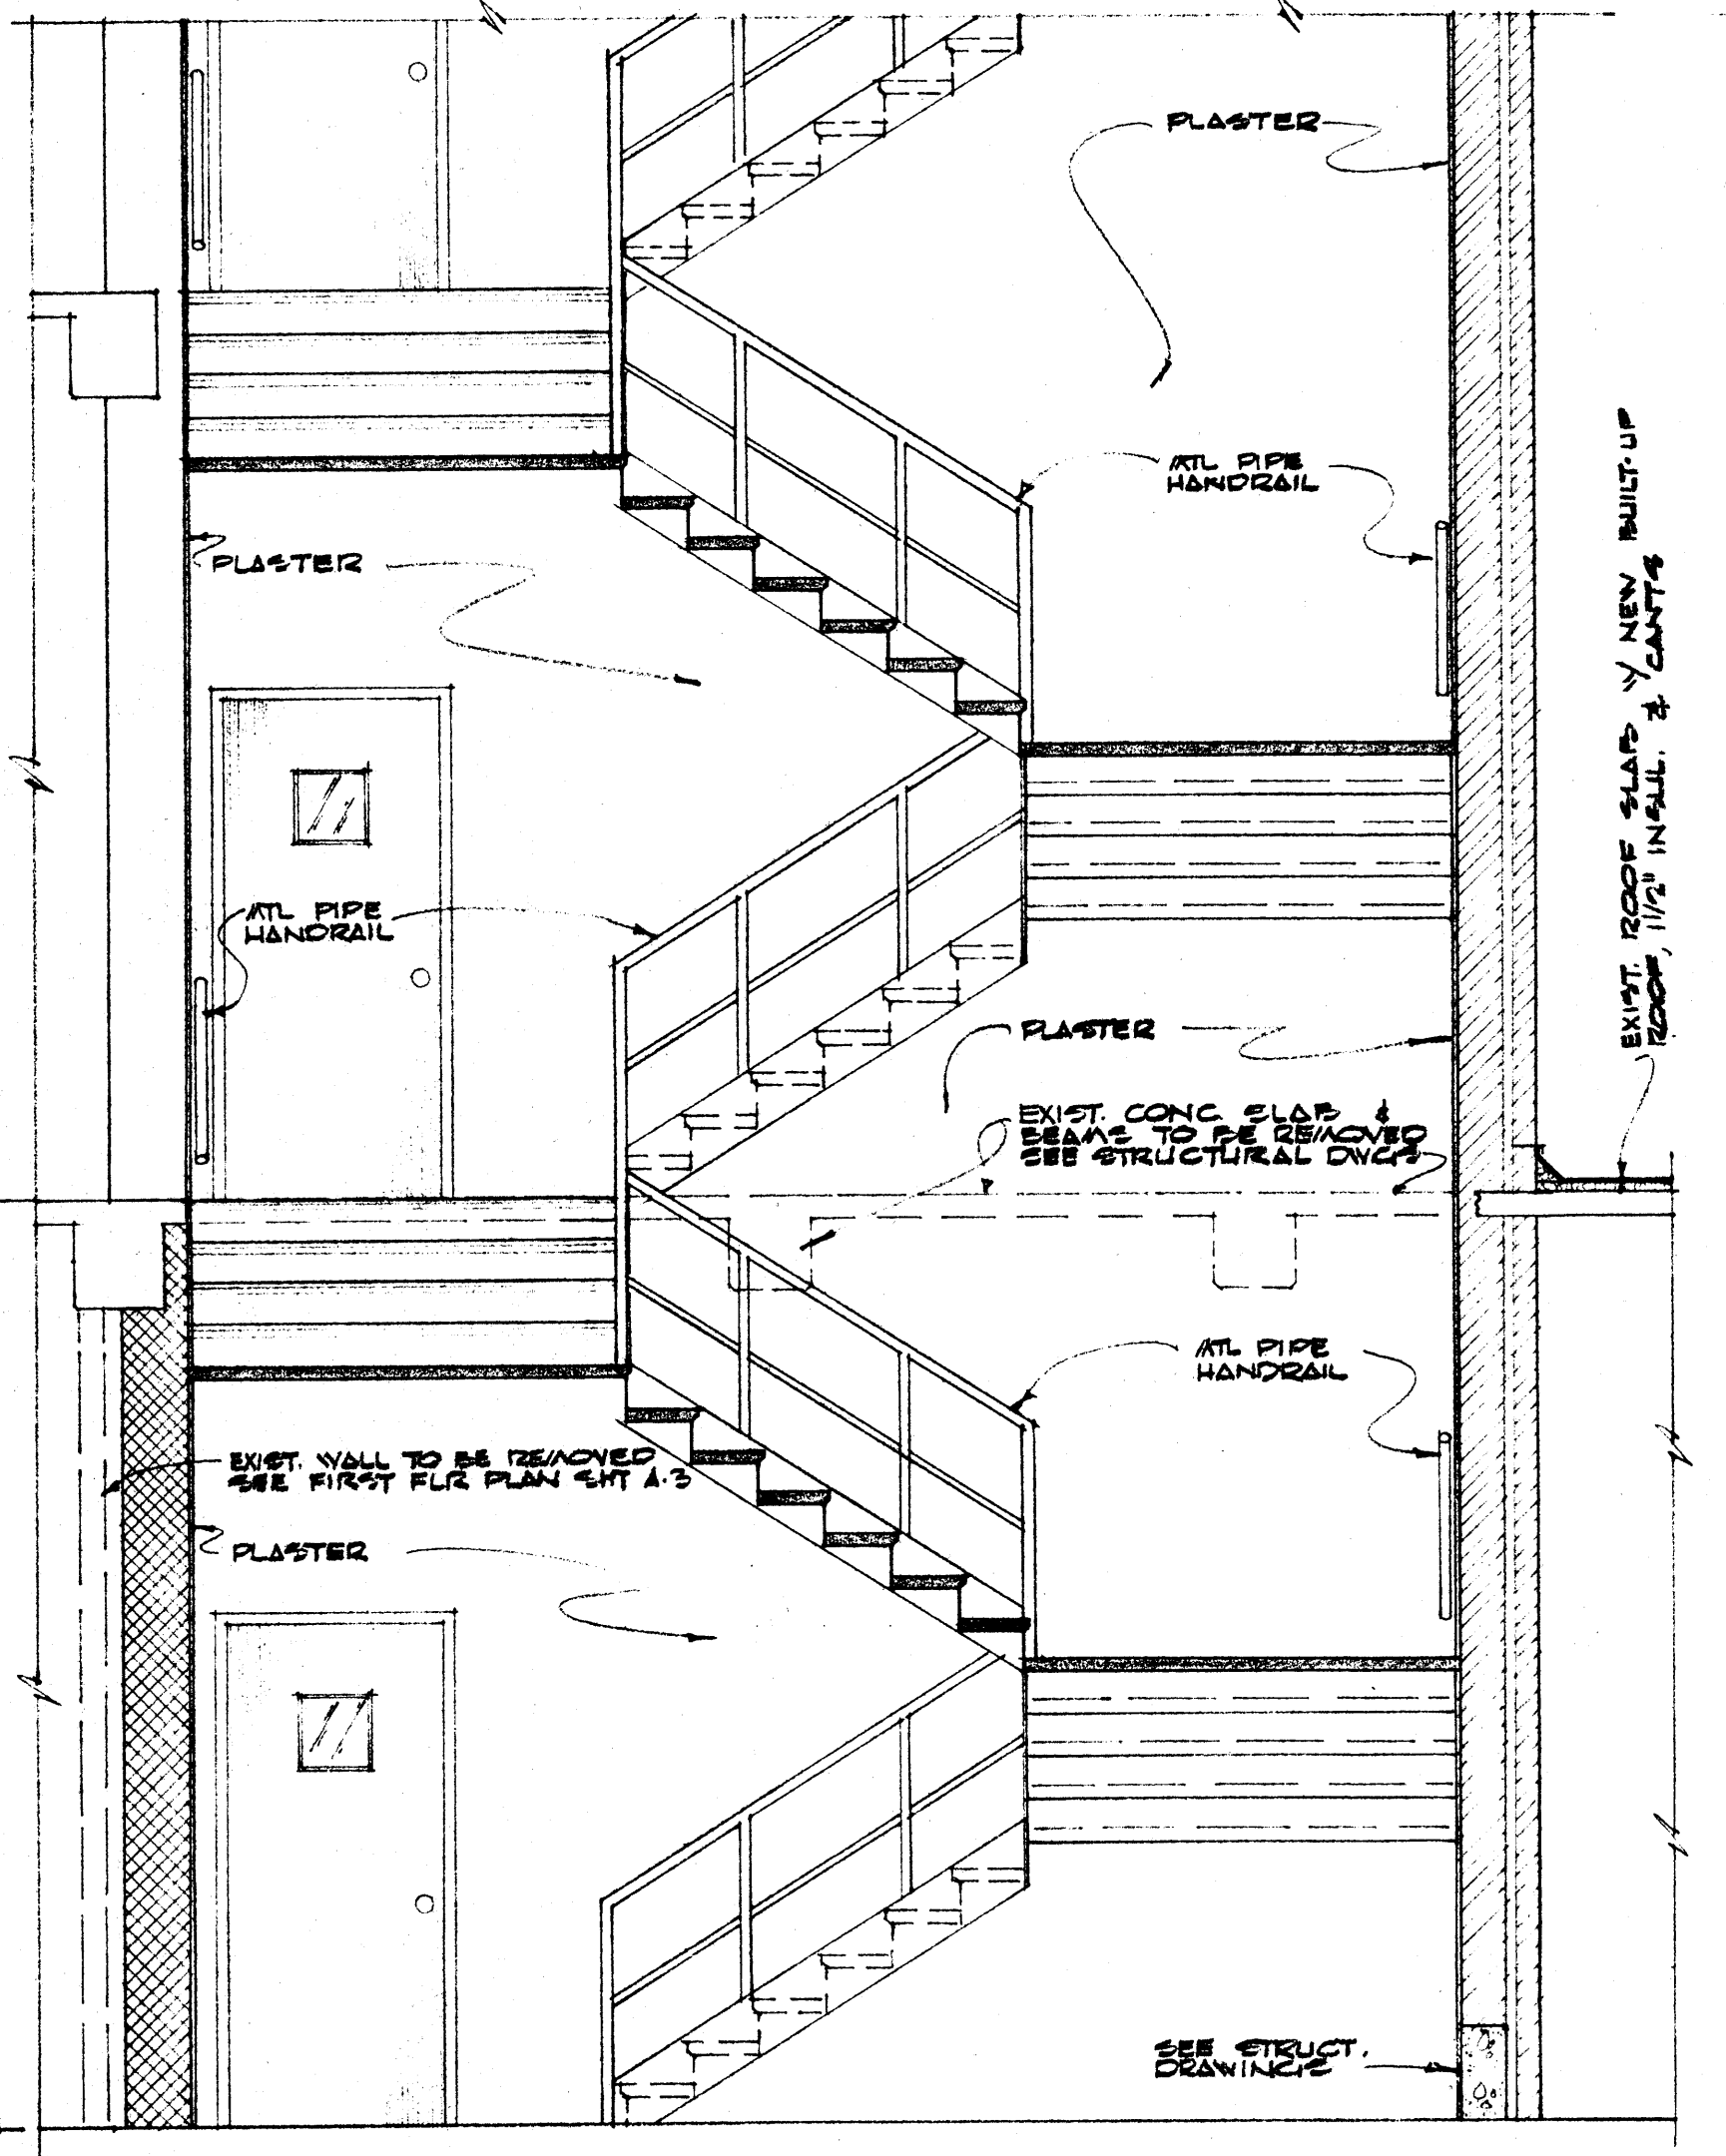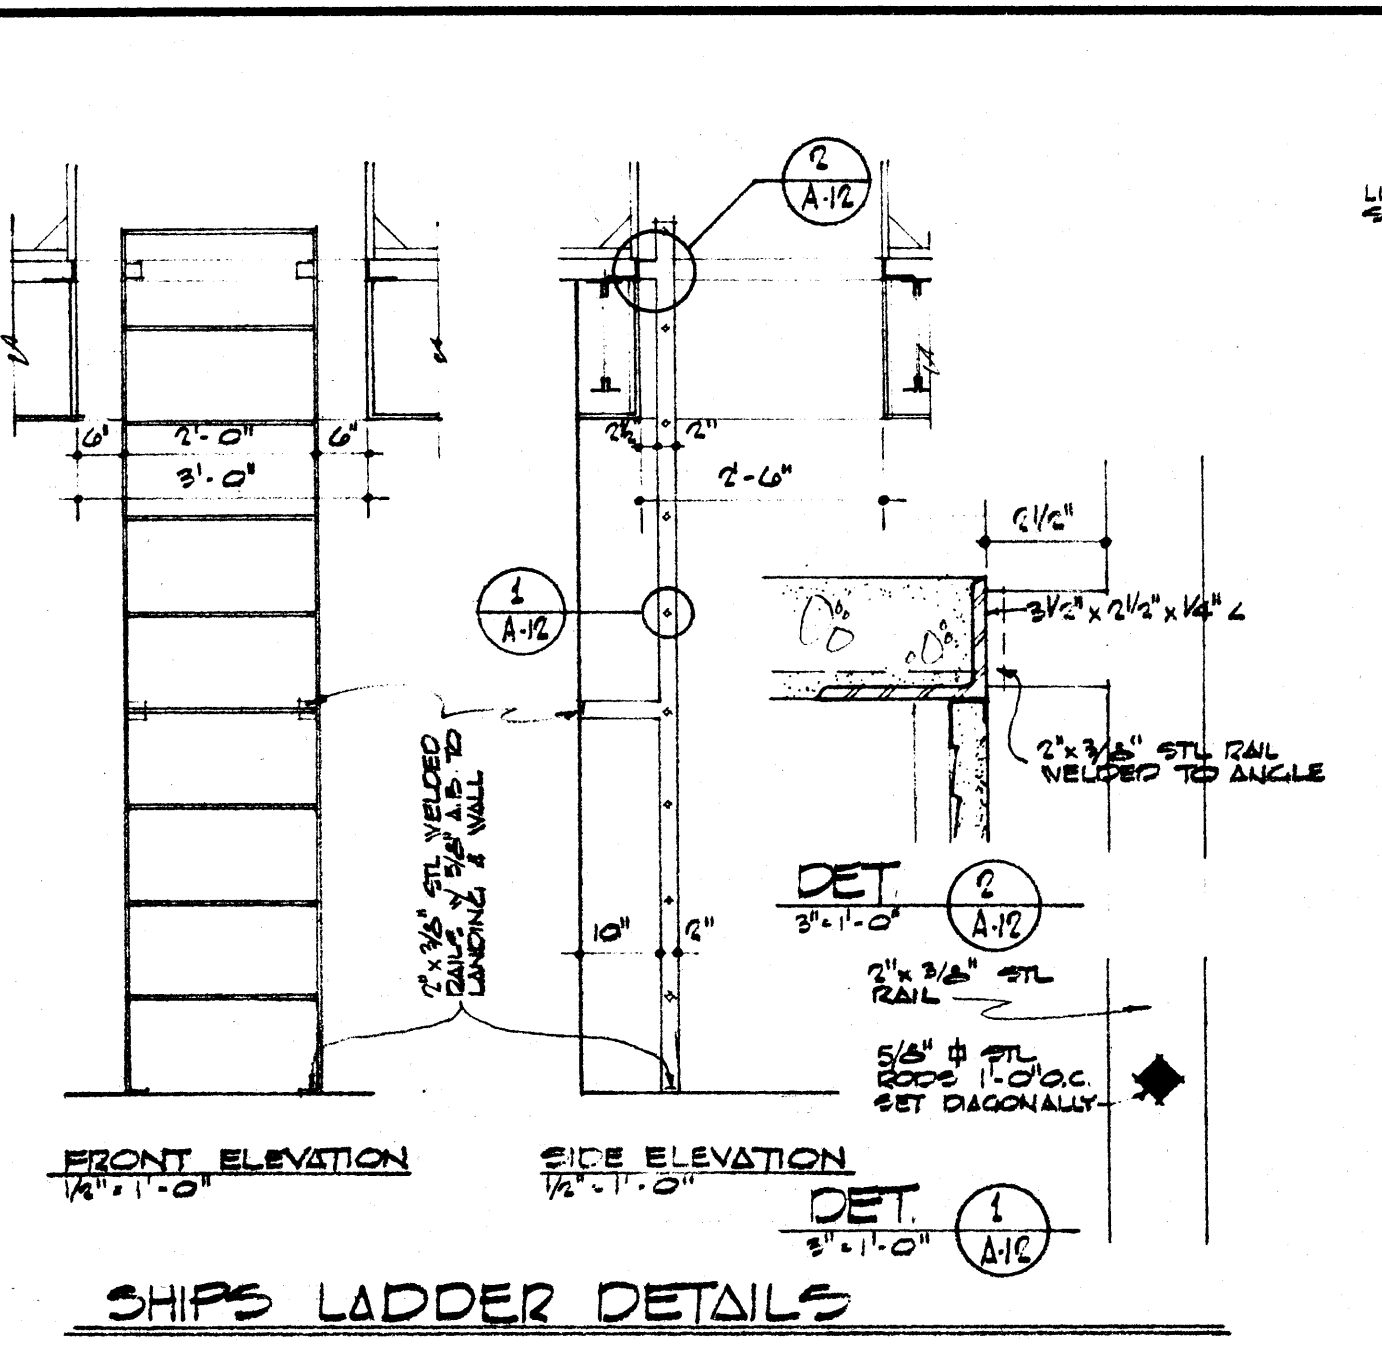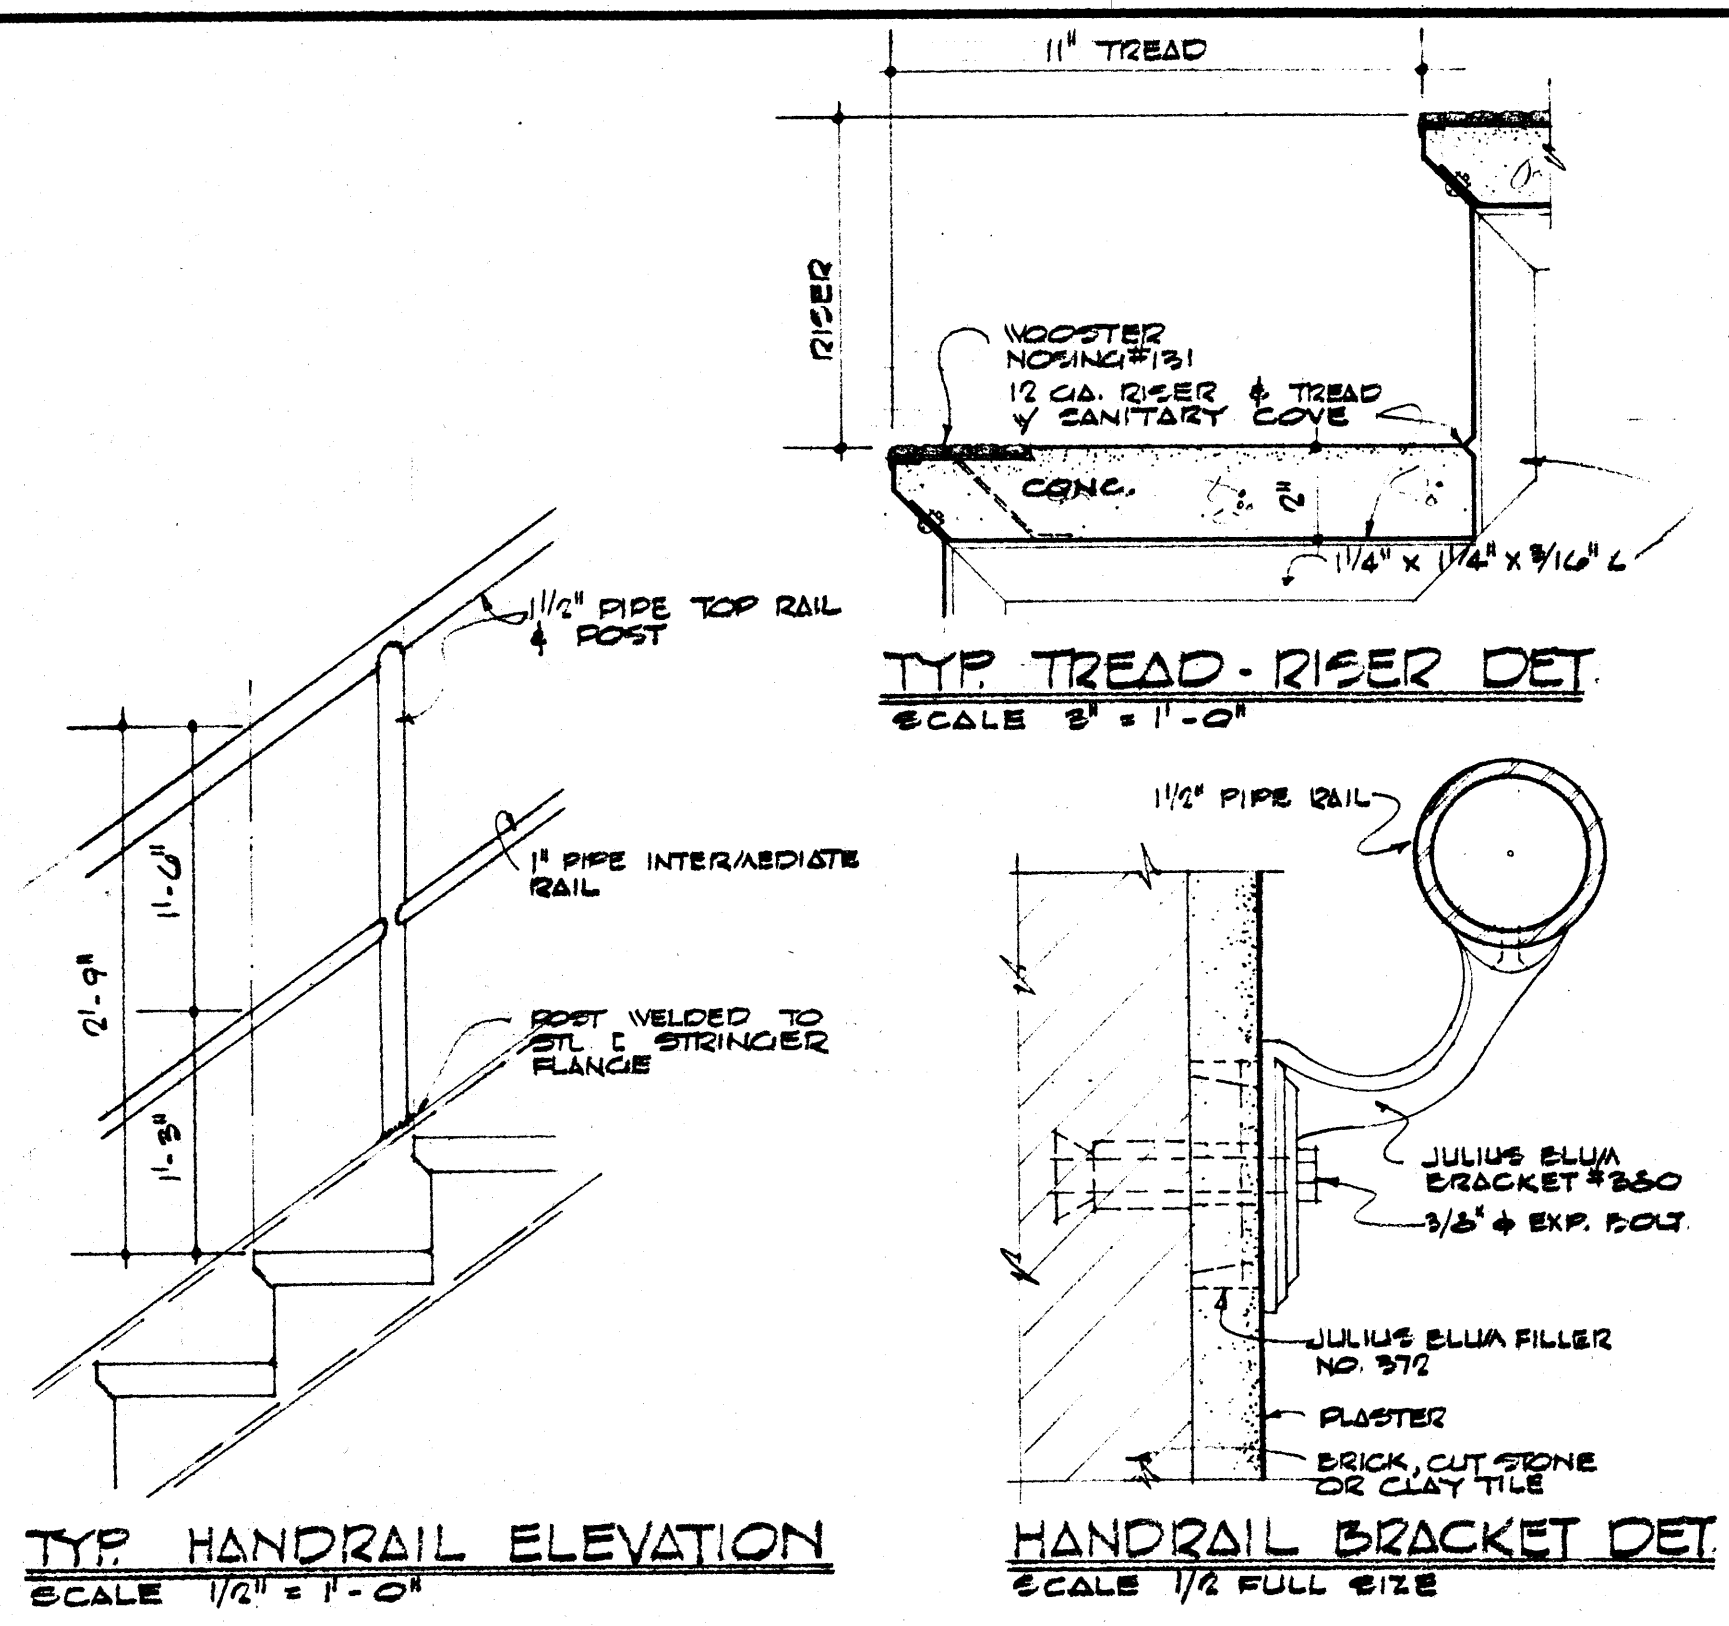

DATE
 2-21-66
 DRAWN BY
 JDA, HRS
 CHECKED BY
 REVISIONS


RENOVATIONS TO
 WILSON HALL
 ARKANSAS STATE COLLEGE
 JONESBORO, ARKANSAS
STUCK, FRIER, LANE & SCOTT, INC., ARCHITECTS
 601 SOUTHWEST DRIVE • JONESBORO, ARKANSAS

SHEET NUMBER
A-12
 COMMISSION NUMBER
 43866

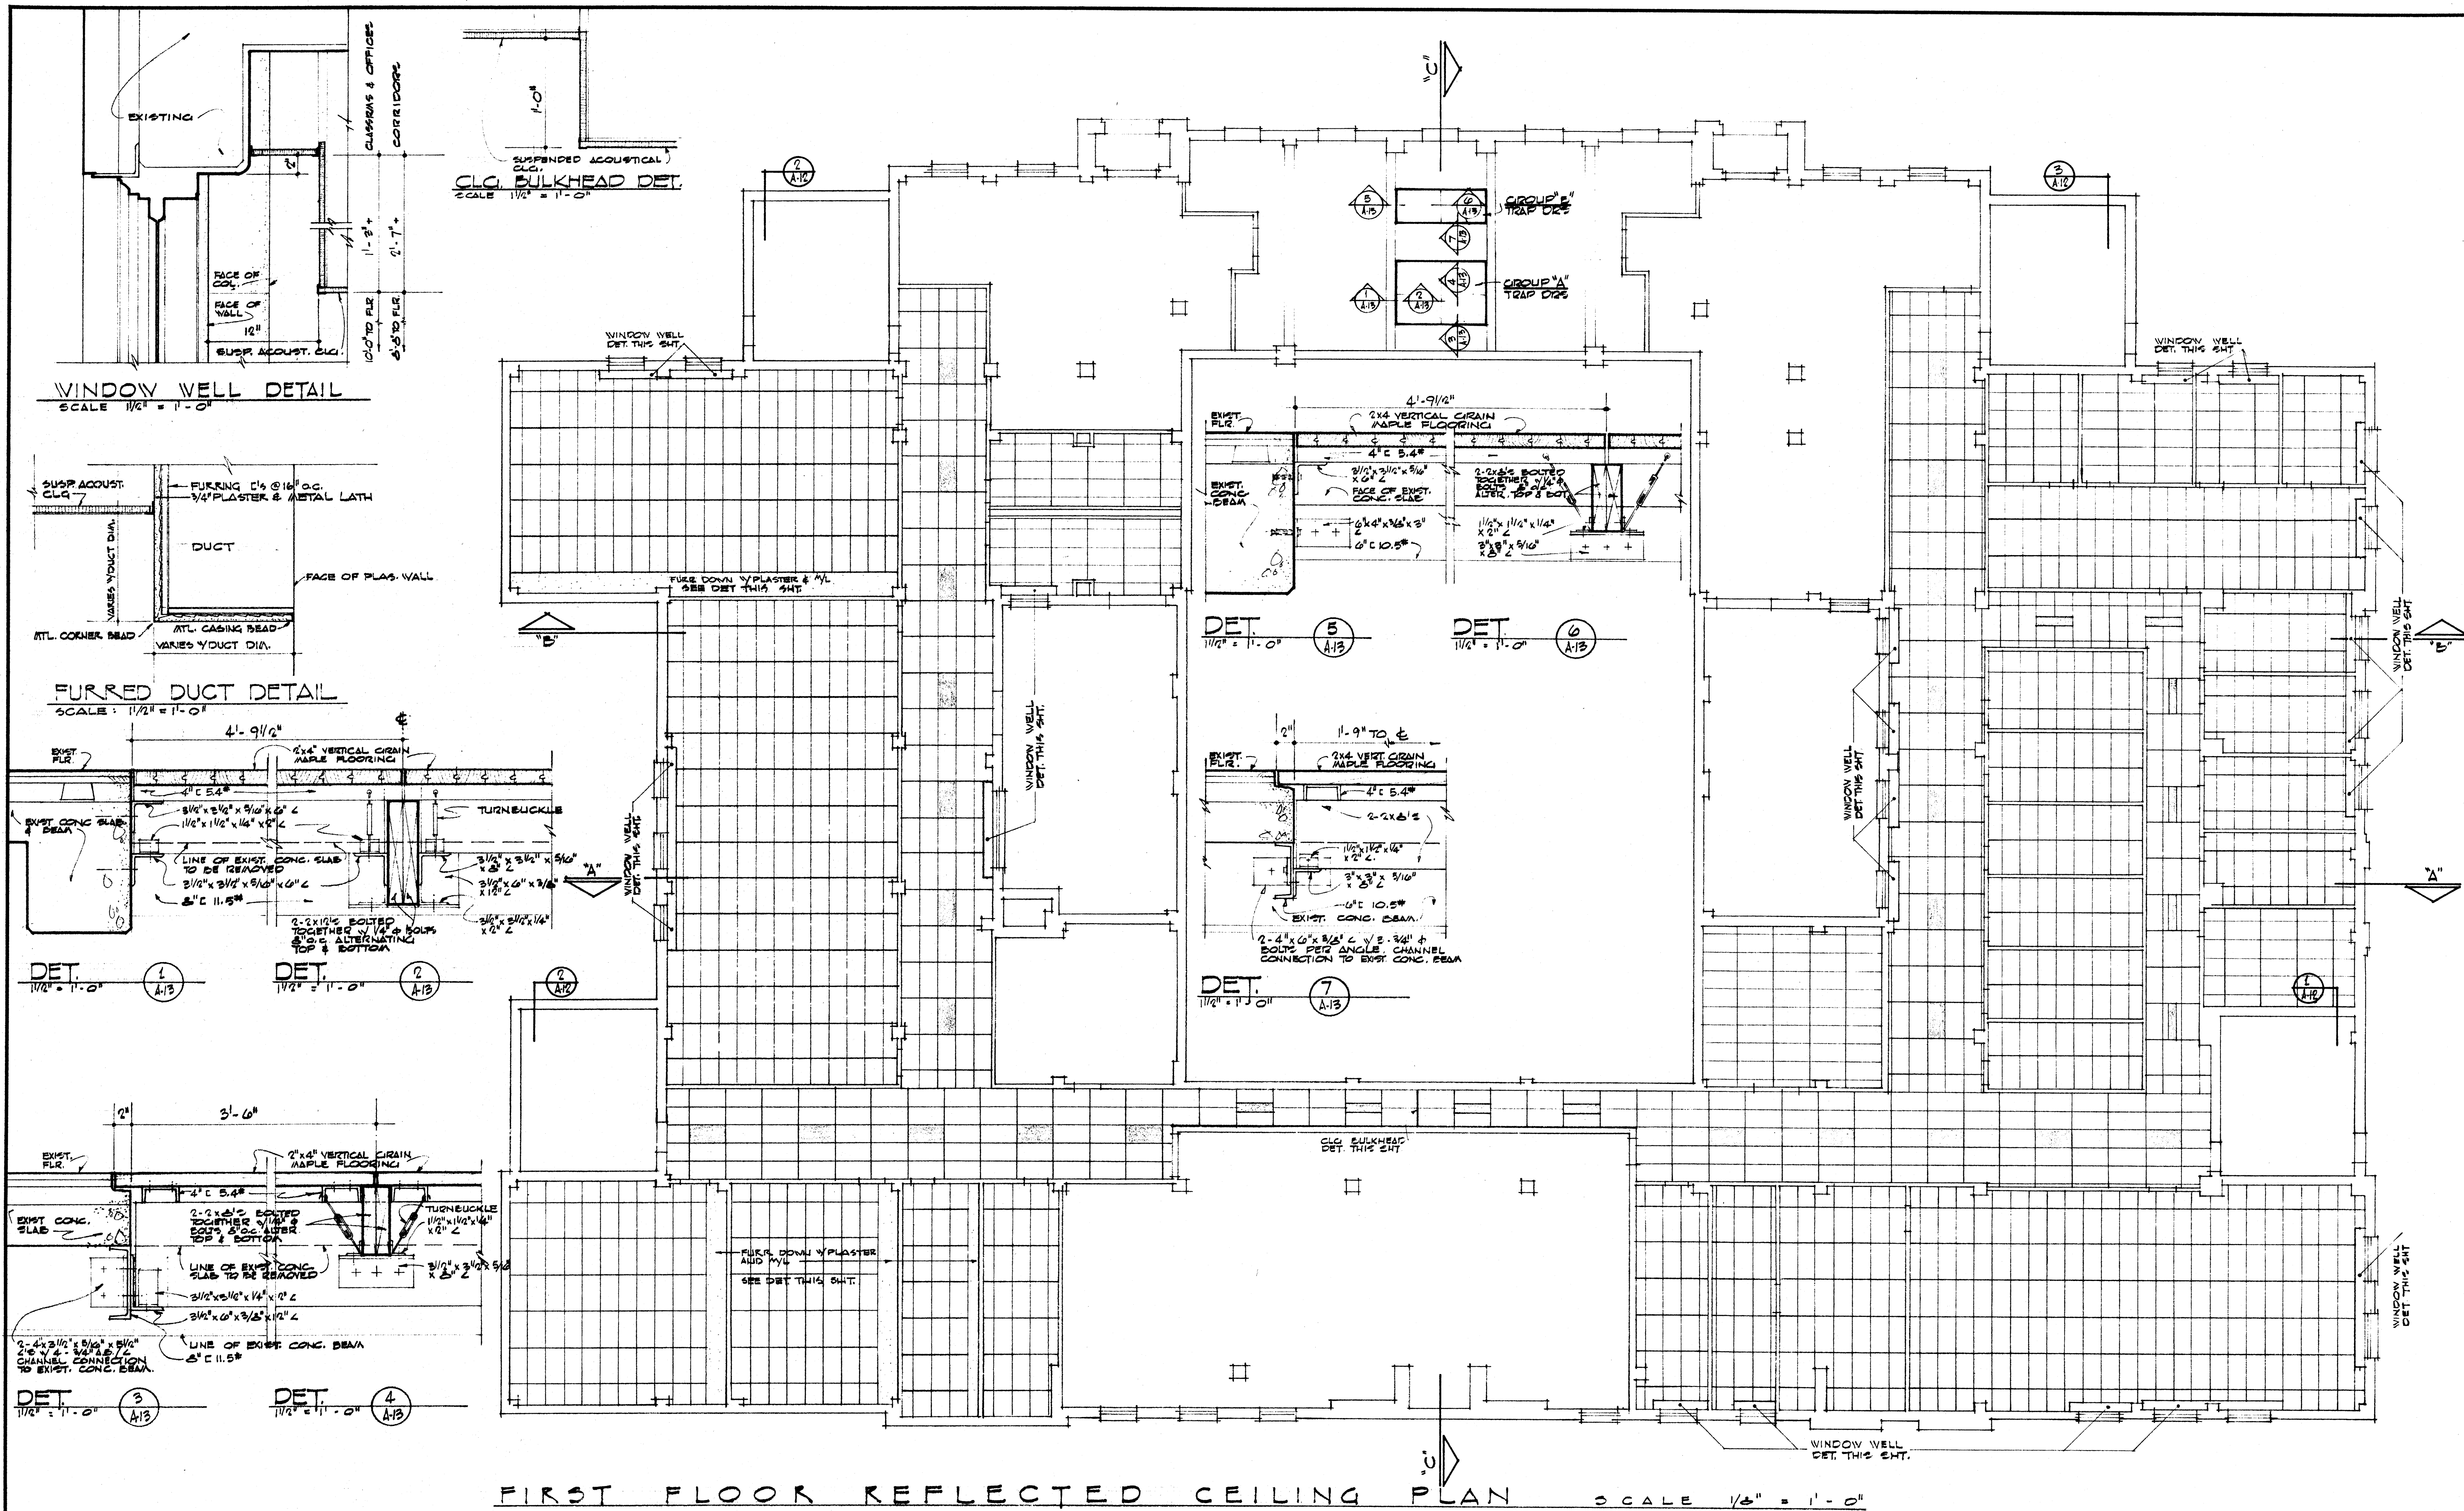


FIRST FLOOR REFLECTED CEILING PLAN SCALE 1/8" = 1'-0"

	DATE 2-21-66	RENOVATIONS TO WILSON HALL ARKANSAS STATE COLLEGE JONESBORO, ARKANSAS	SHEET NUMBER A-13	
	DRAWN BY JDA		STUCK, FRIER, LANE & SCOTT, INC., ARCHITECTS 601 SOUTHWEST DRIVE • JONESBORO, ARKANSAS	COMMISSION NUMBER 43300
	CHECKED BY			
	REVISIONS			

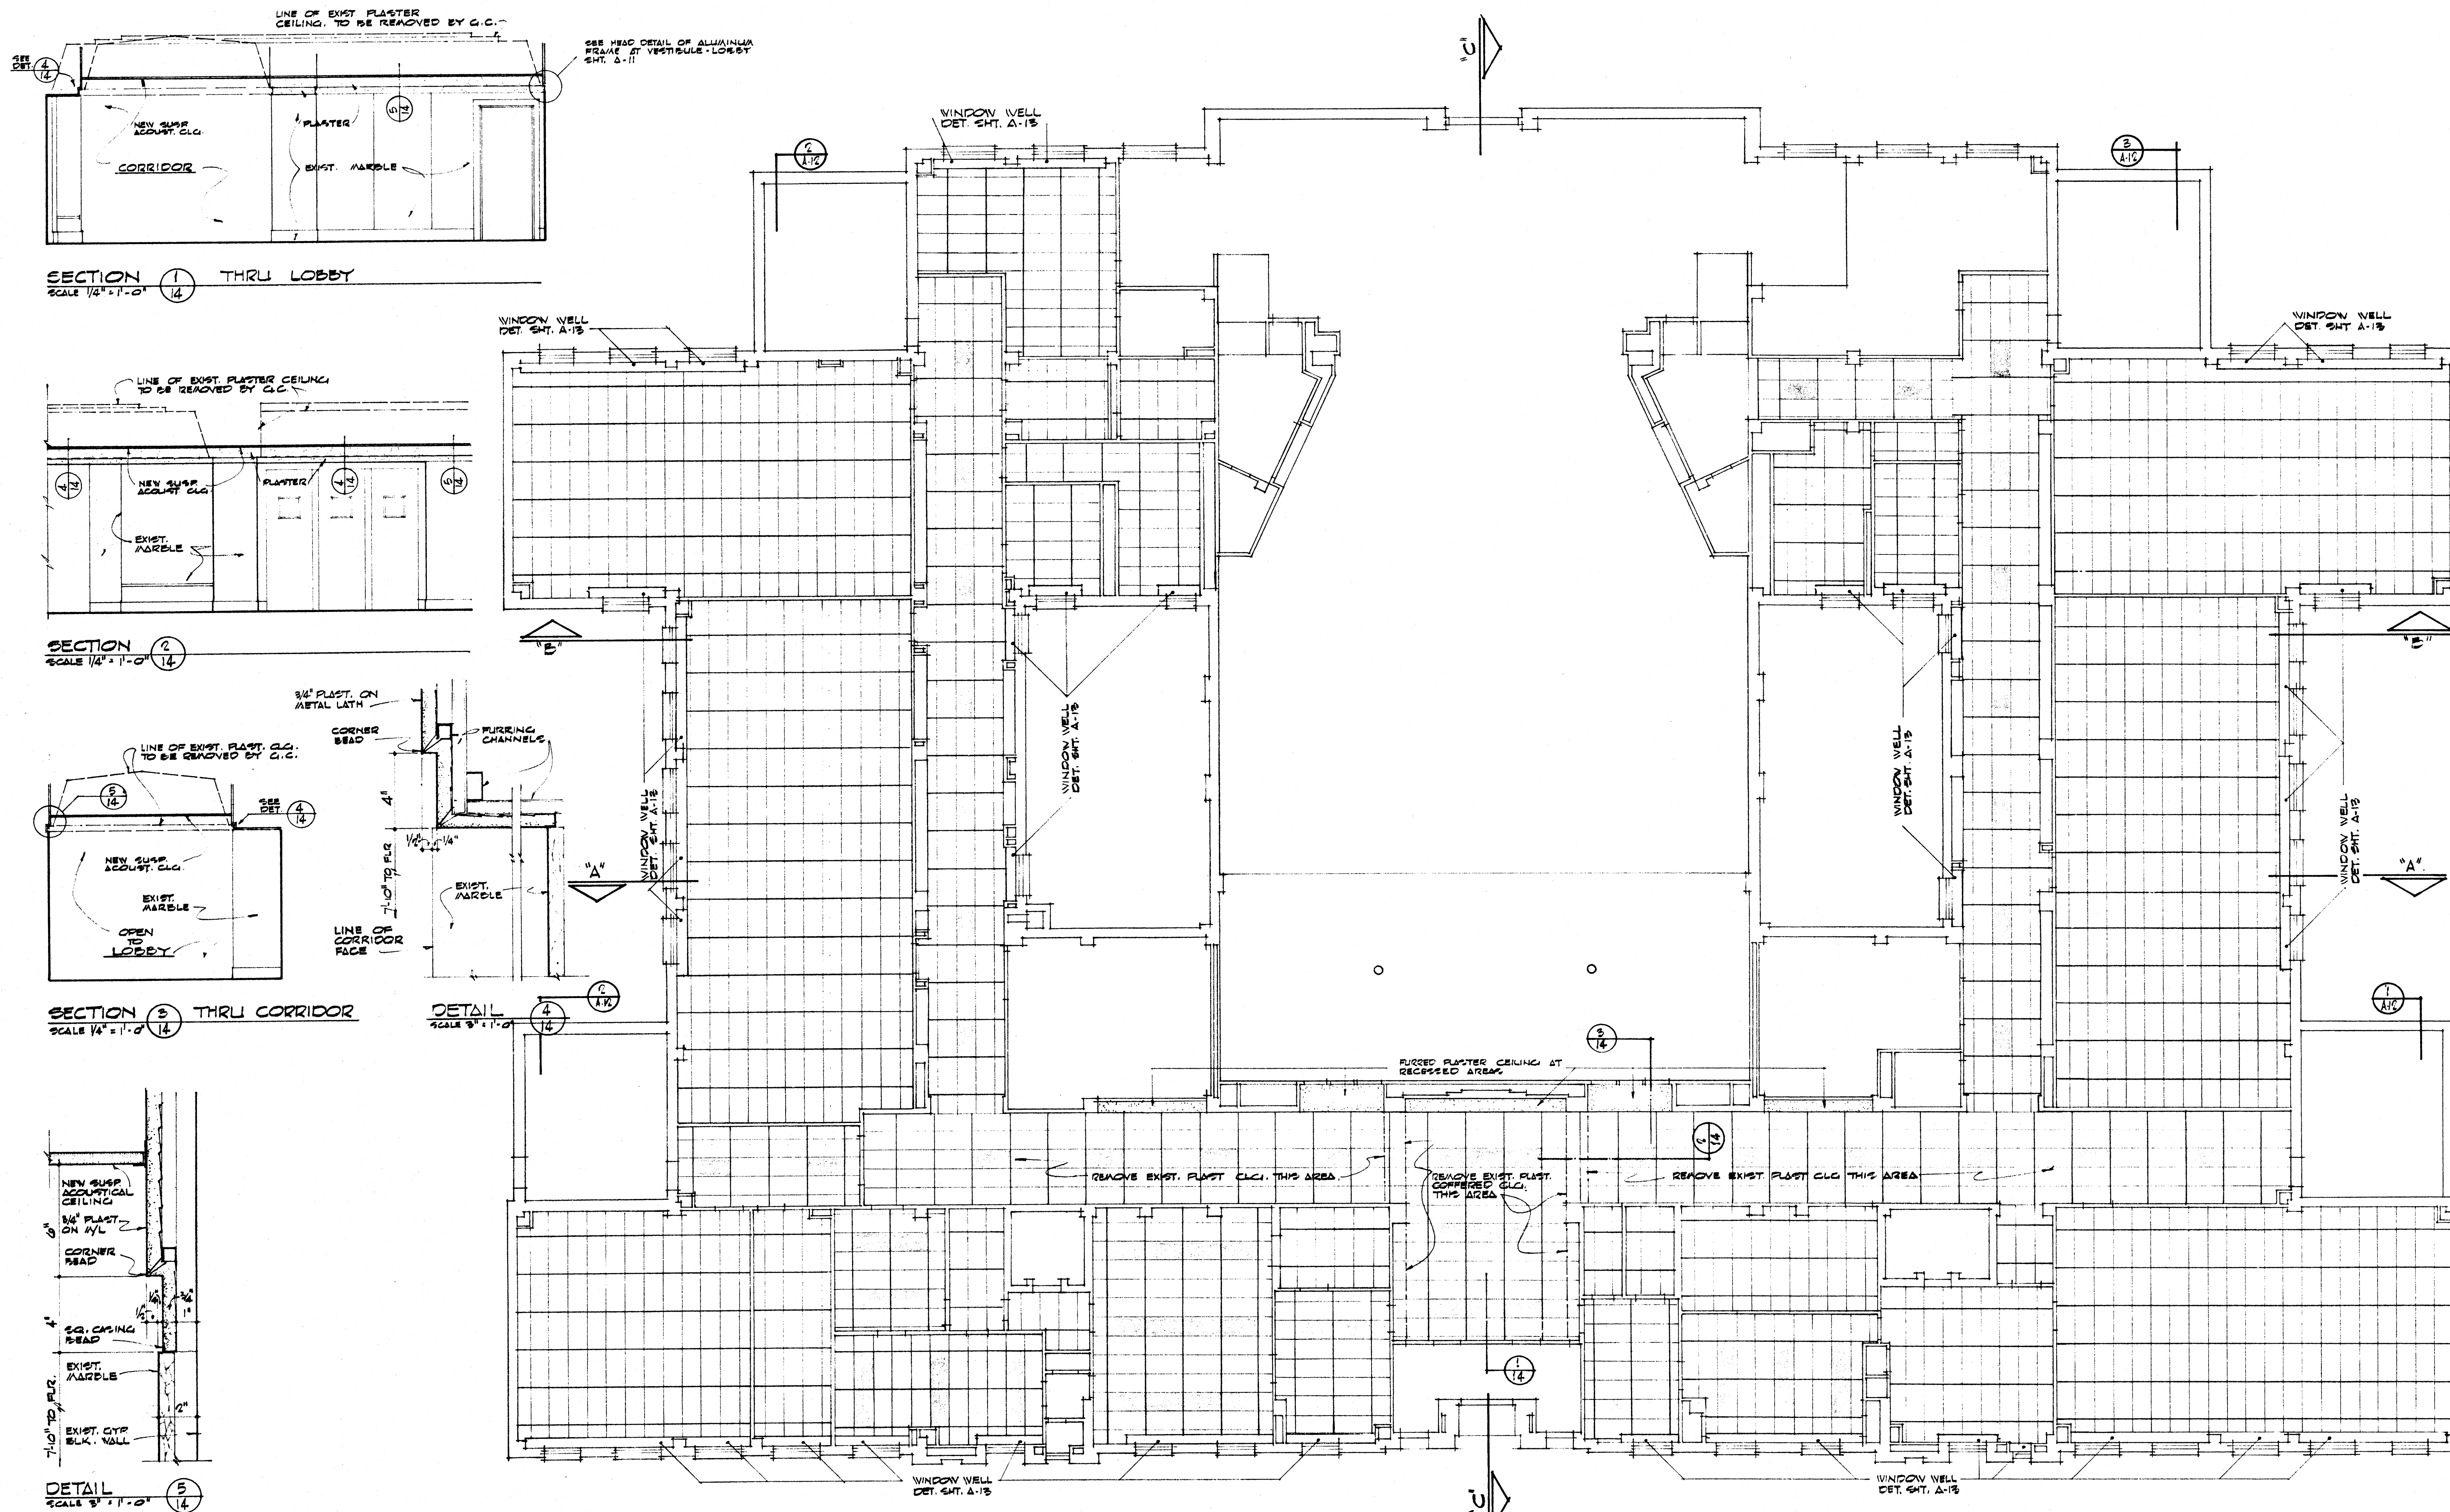


SECOND FLOOR REFLECTED CEILING PLAN SCALE 1/8" = 1'-0"


	DATE 2-21-66	RENOVATIONS TO WILSON HALL ARKANSAS STATE COLLEGE JONESBORO, ARKANSAS	SHEET NUMBER A-14	
	DRAWN BY JDA		STUCK, FRIER, LANE & SCOTT, INC., ARCHITECTS 601 SOUTHWEST DRIVE • JONESBORO, ARKANSAS	COMMISSION NUMBER 43366
	CHECKED BY			
	REVISIONS			

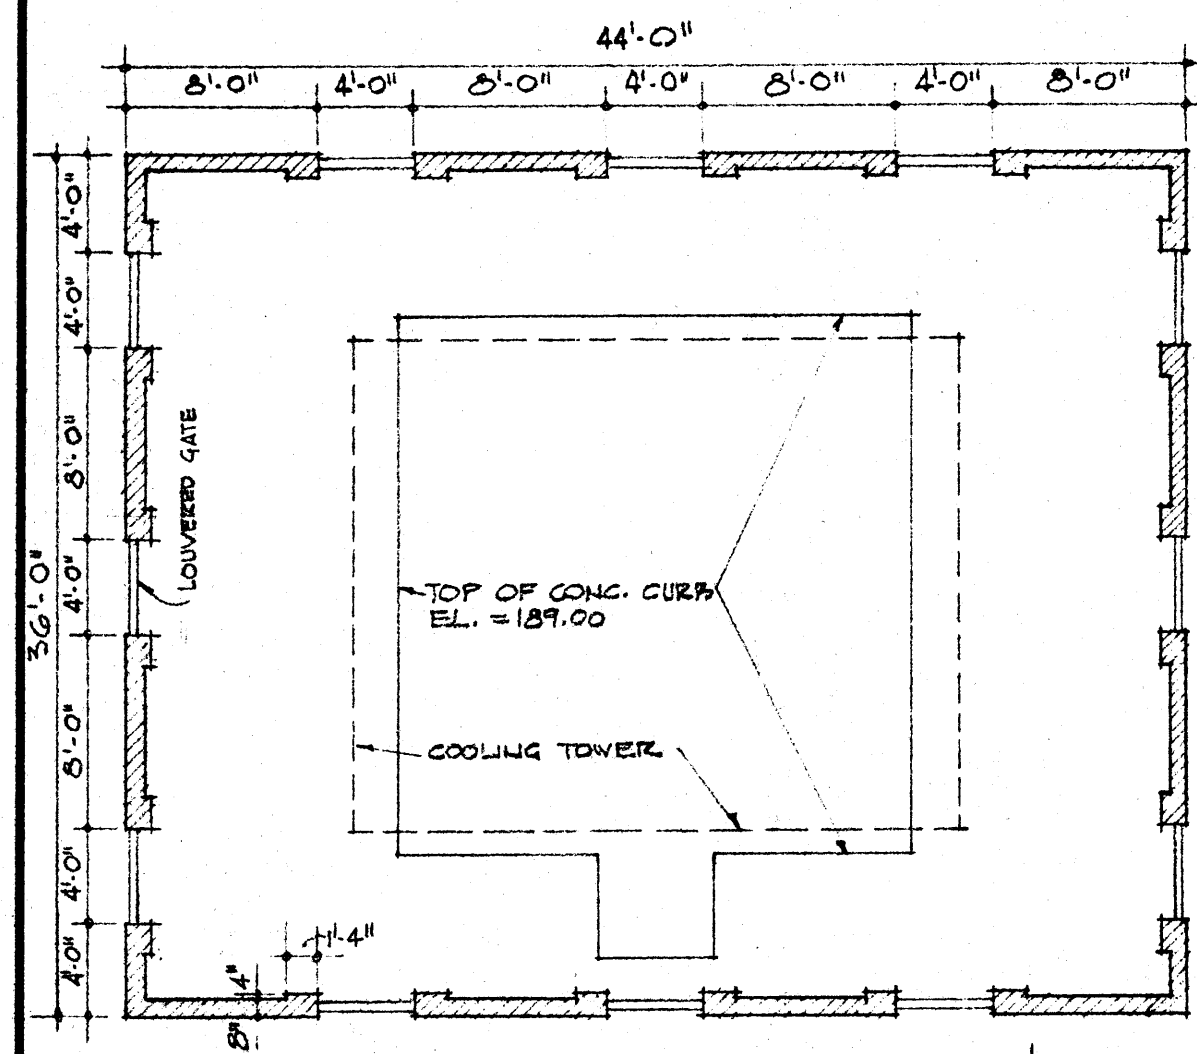


PLAN SCALE: 1/8" = 1'-0"

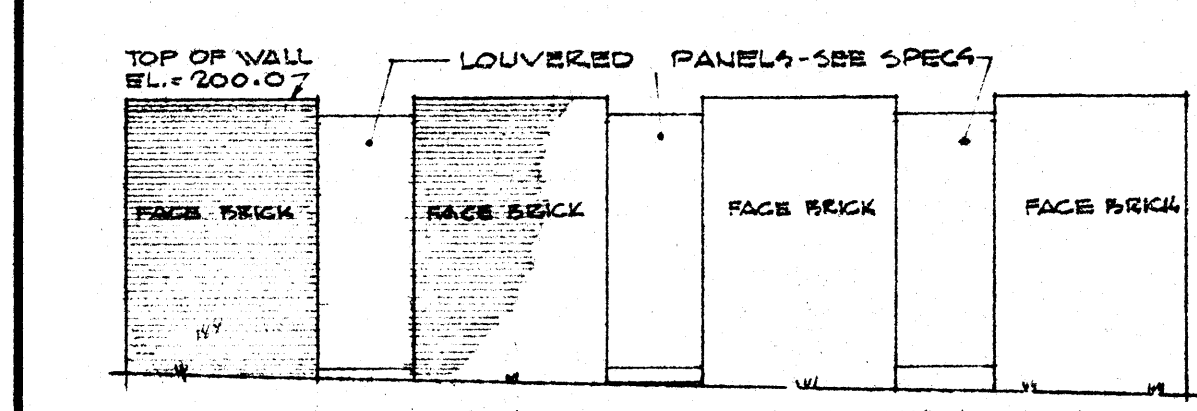

NORTH ELEVATION (SOUTH SIMILAR) 1/8" = 1'-0"

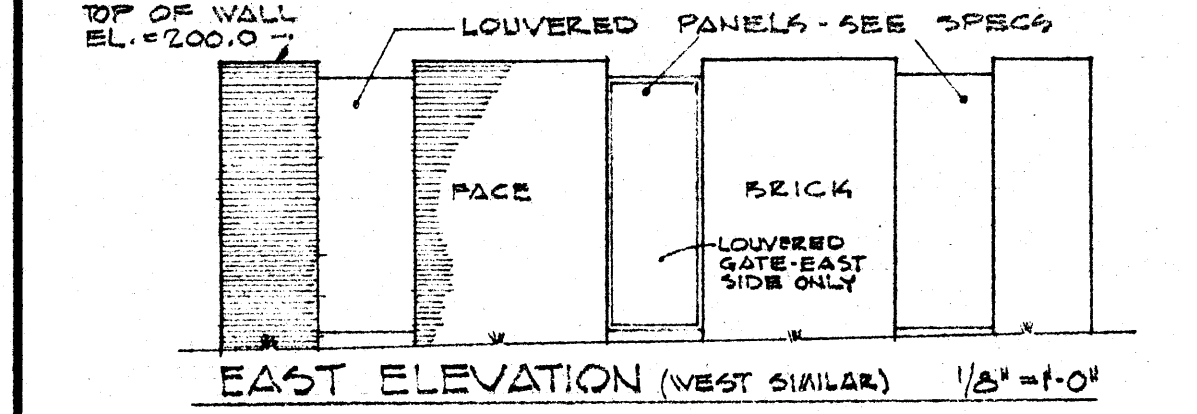


EAST ELEVATION (WEST SIMILAR) 1/8" = 1'-0"

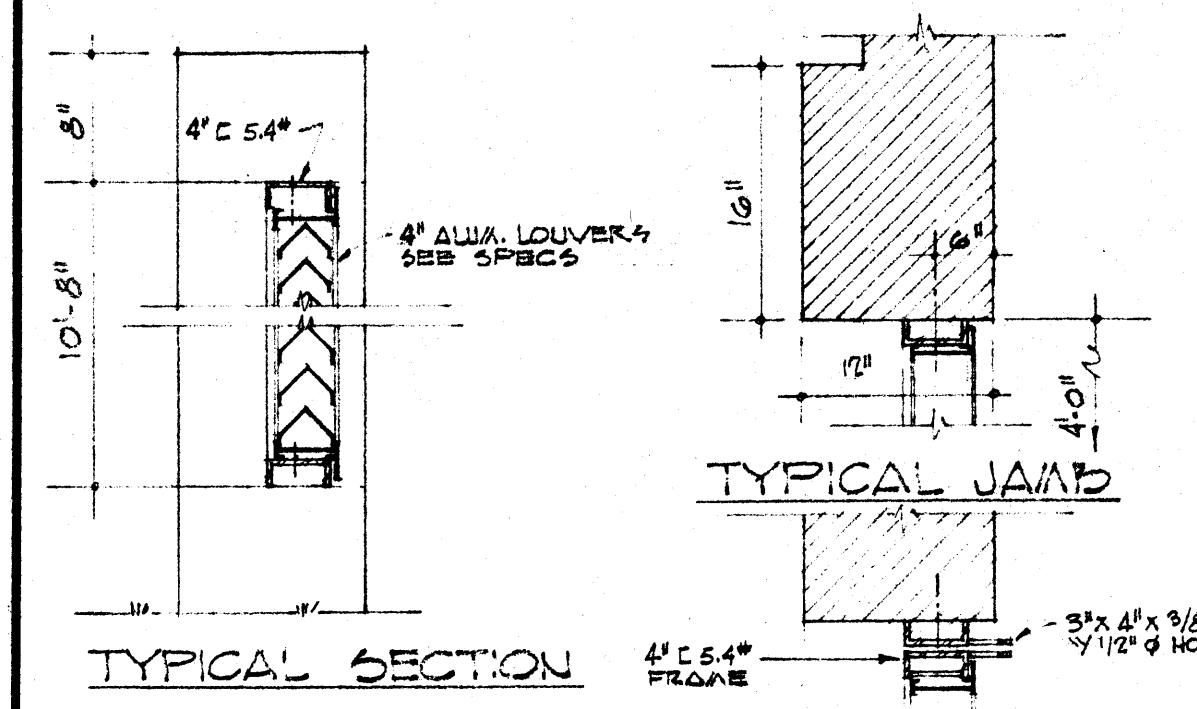


TYPICAL SECTION GATE DETAIL
SCREEN DETAILS 1" = 1'-0"

COOLING TOWER SCREEN

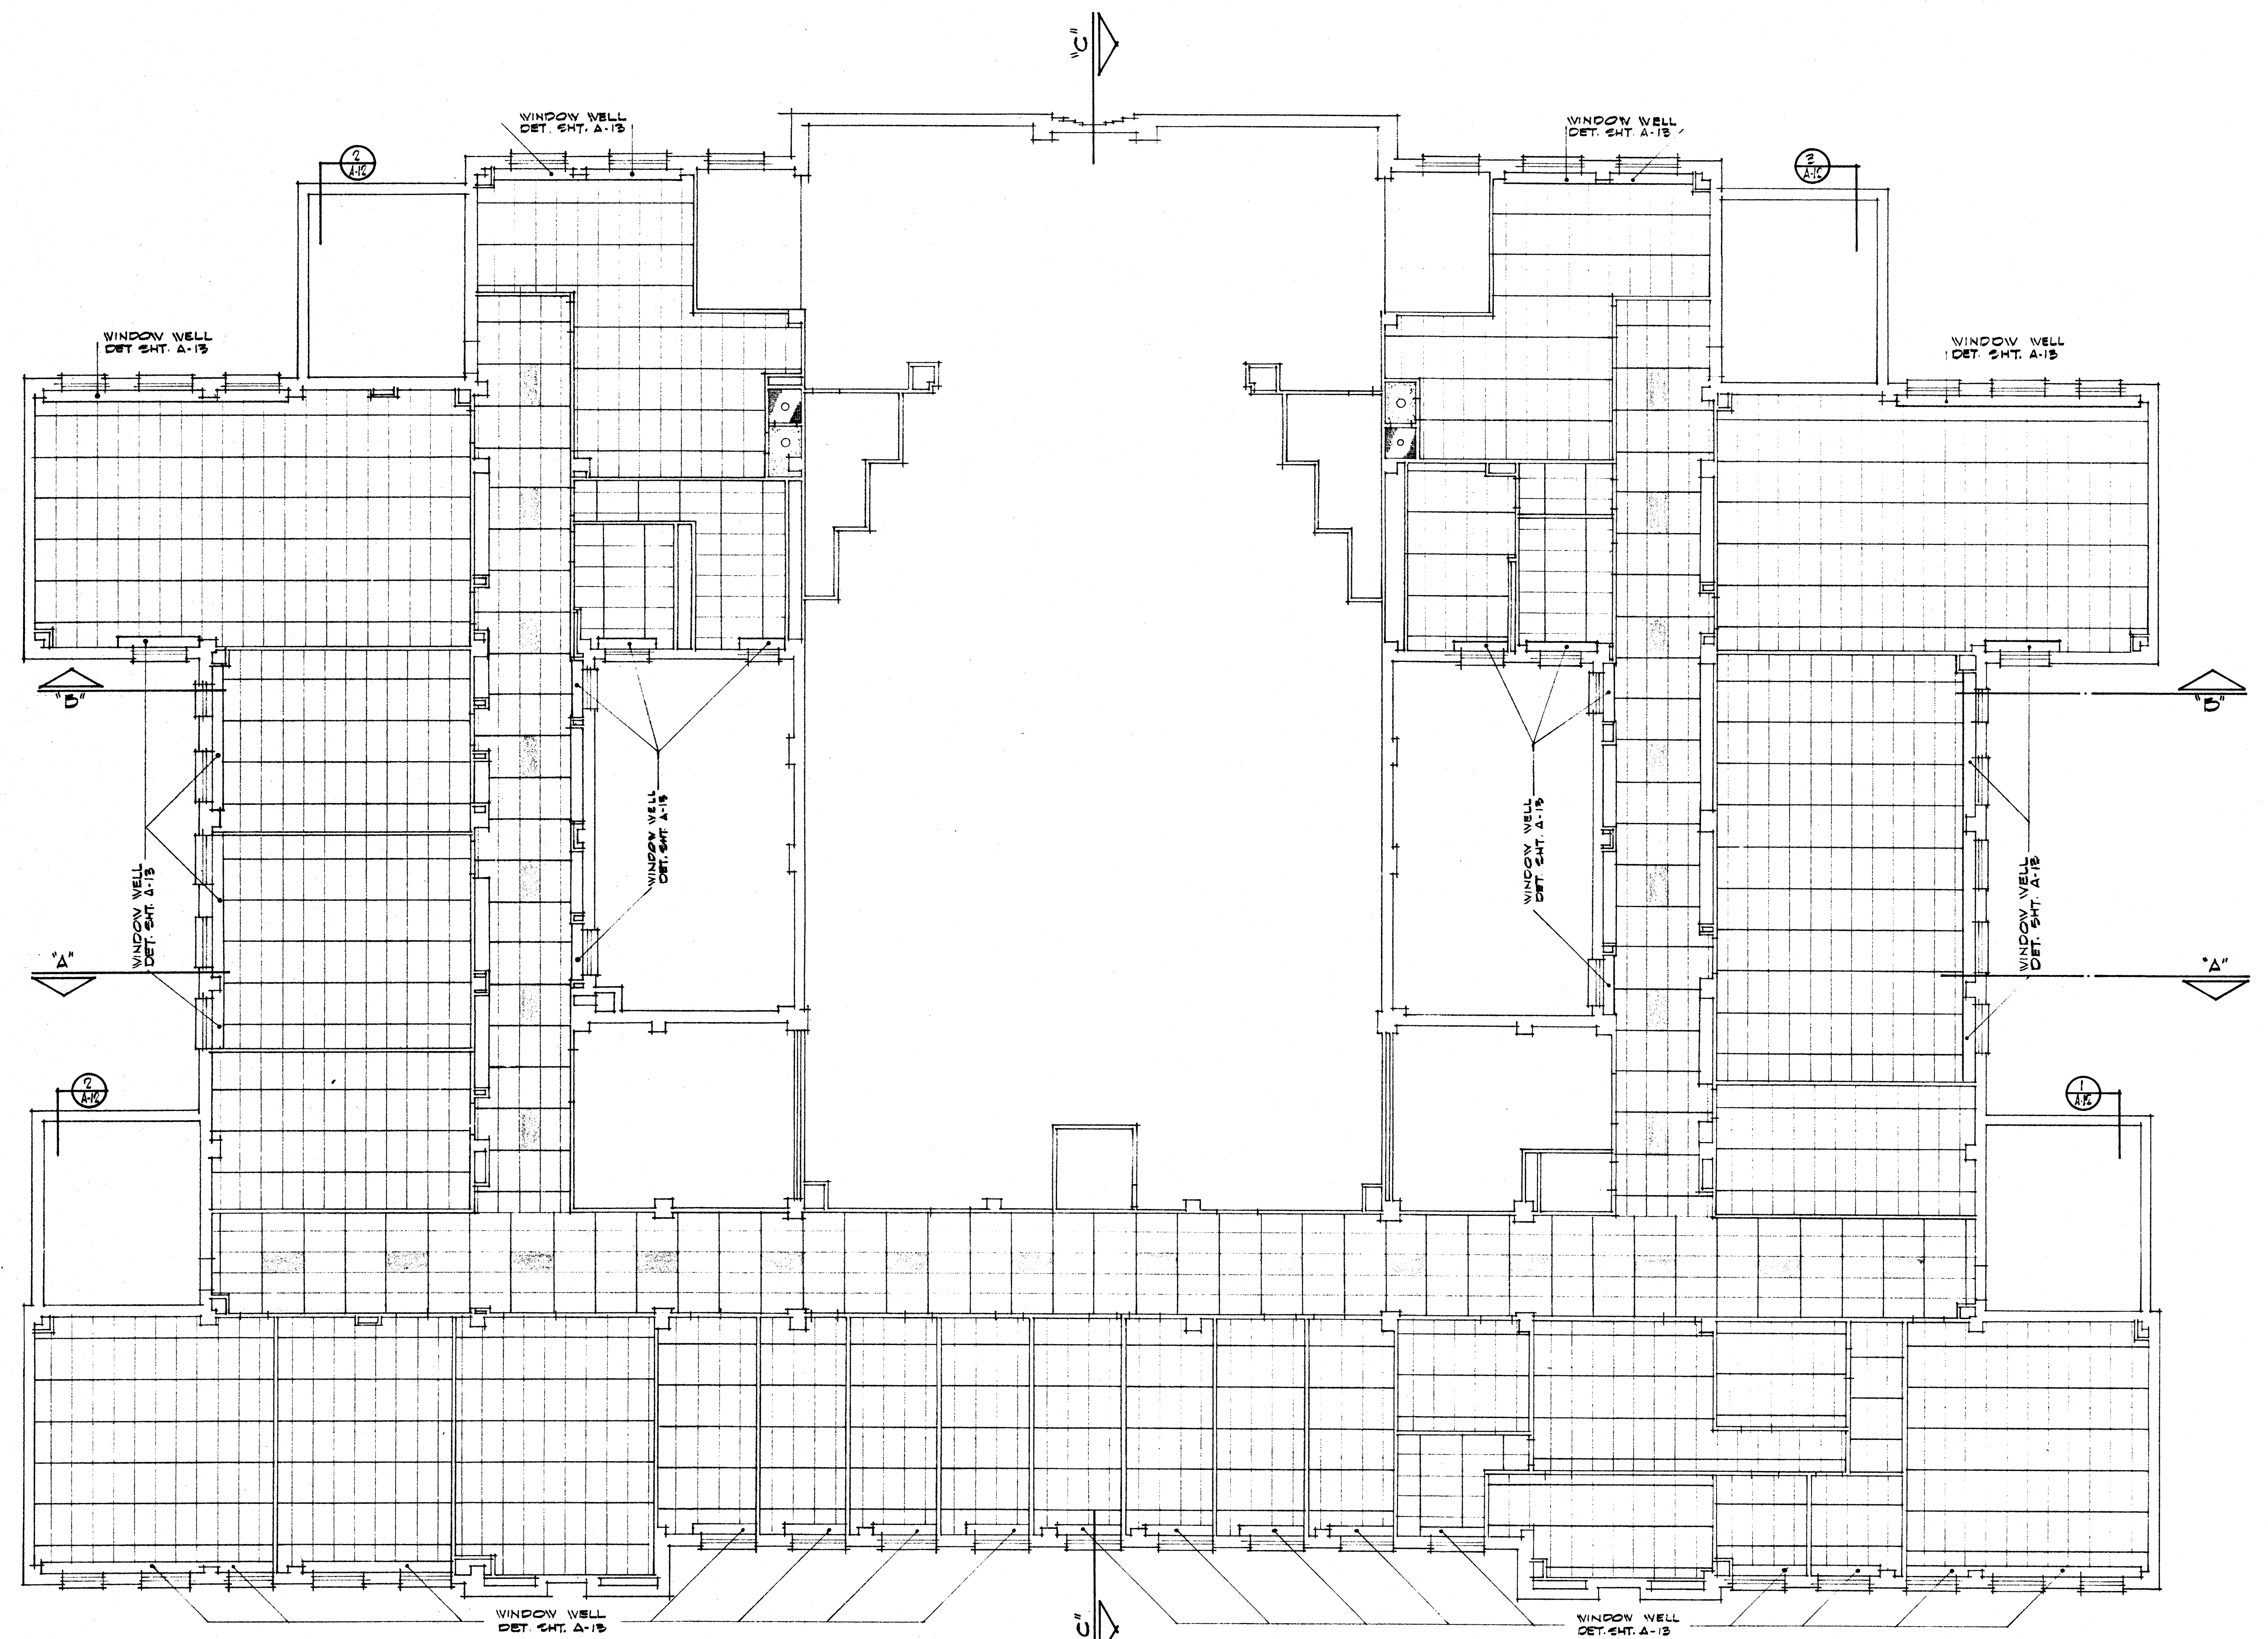

THIRD FLOOR REFLECTED CEILING PLAN SCALE 1/8" = 1'-0"


	DATE 2-21-66	RENOVATIONS TO WILSON HALL ARKANSAS STATE COLLEGE JONESBORO, ARKANSAS	SHEET NUMBER
	DRAWN BY JDM, HKS		A-15
	CHECKED BY		COMMISSION NUMBER 43866
	REVISIONS		
STUCK, FRIER, LANE & SCOTT, INC., ARCHITECTS 601 SOUTHWEST DRIVE • JONESBORO, ARKANSAS			

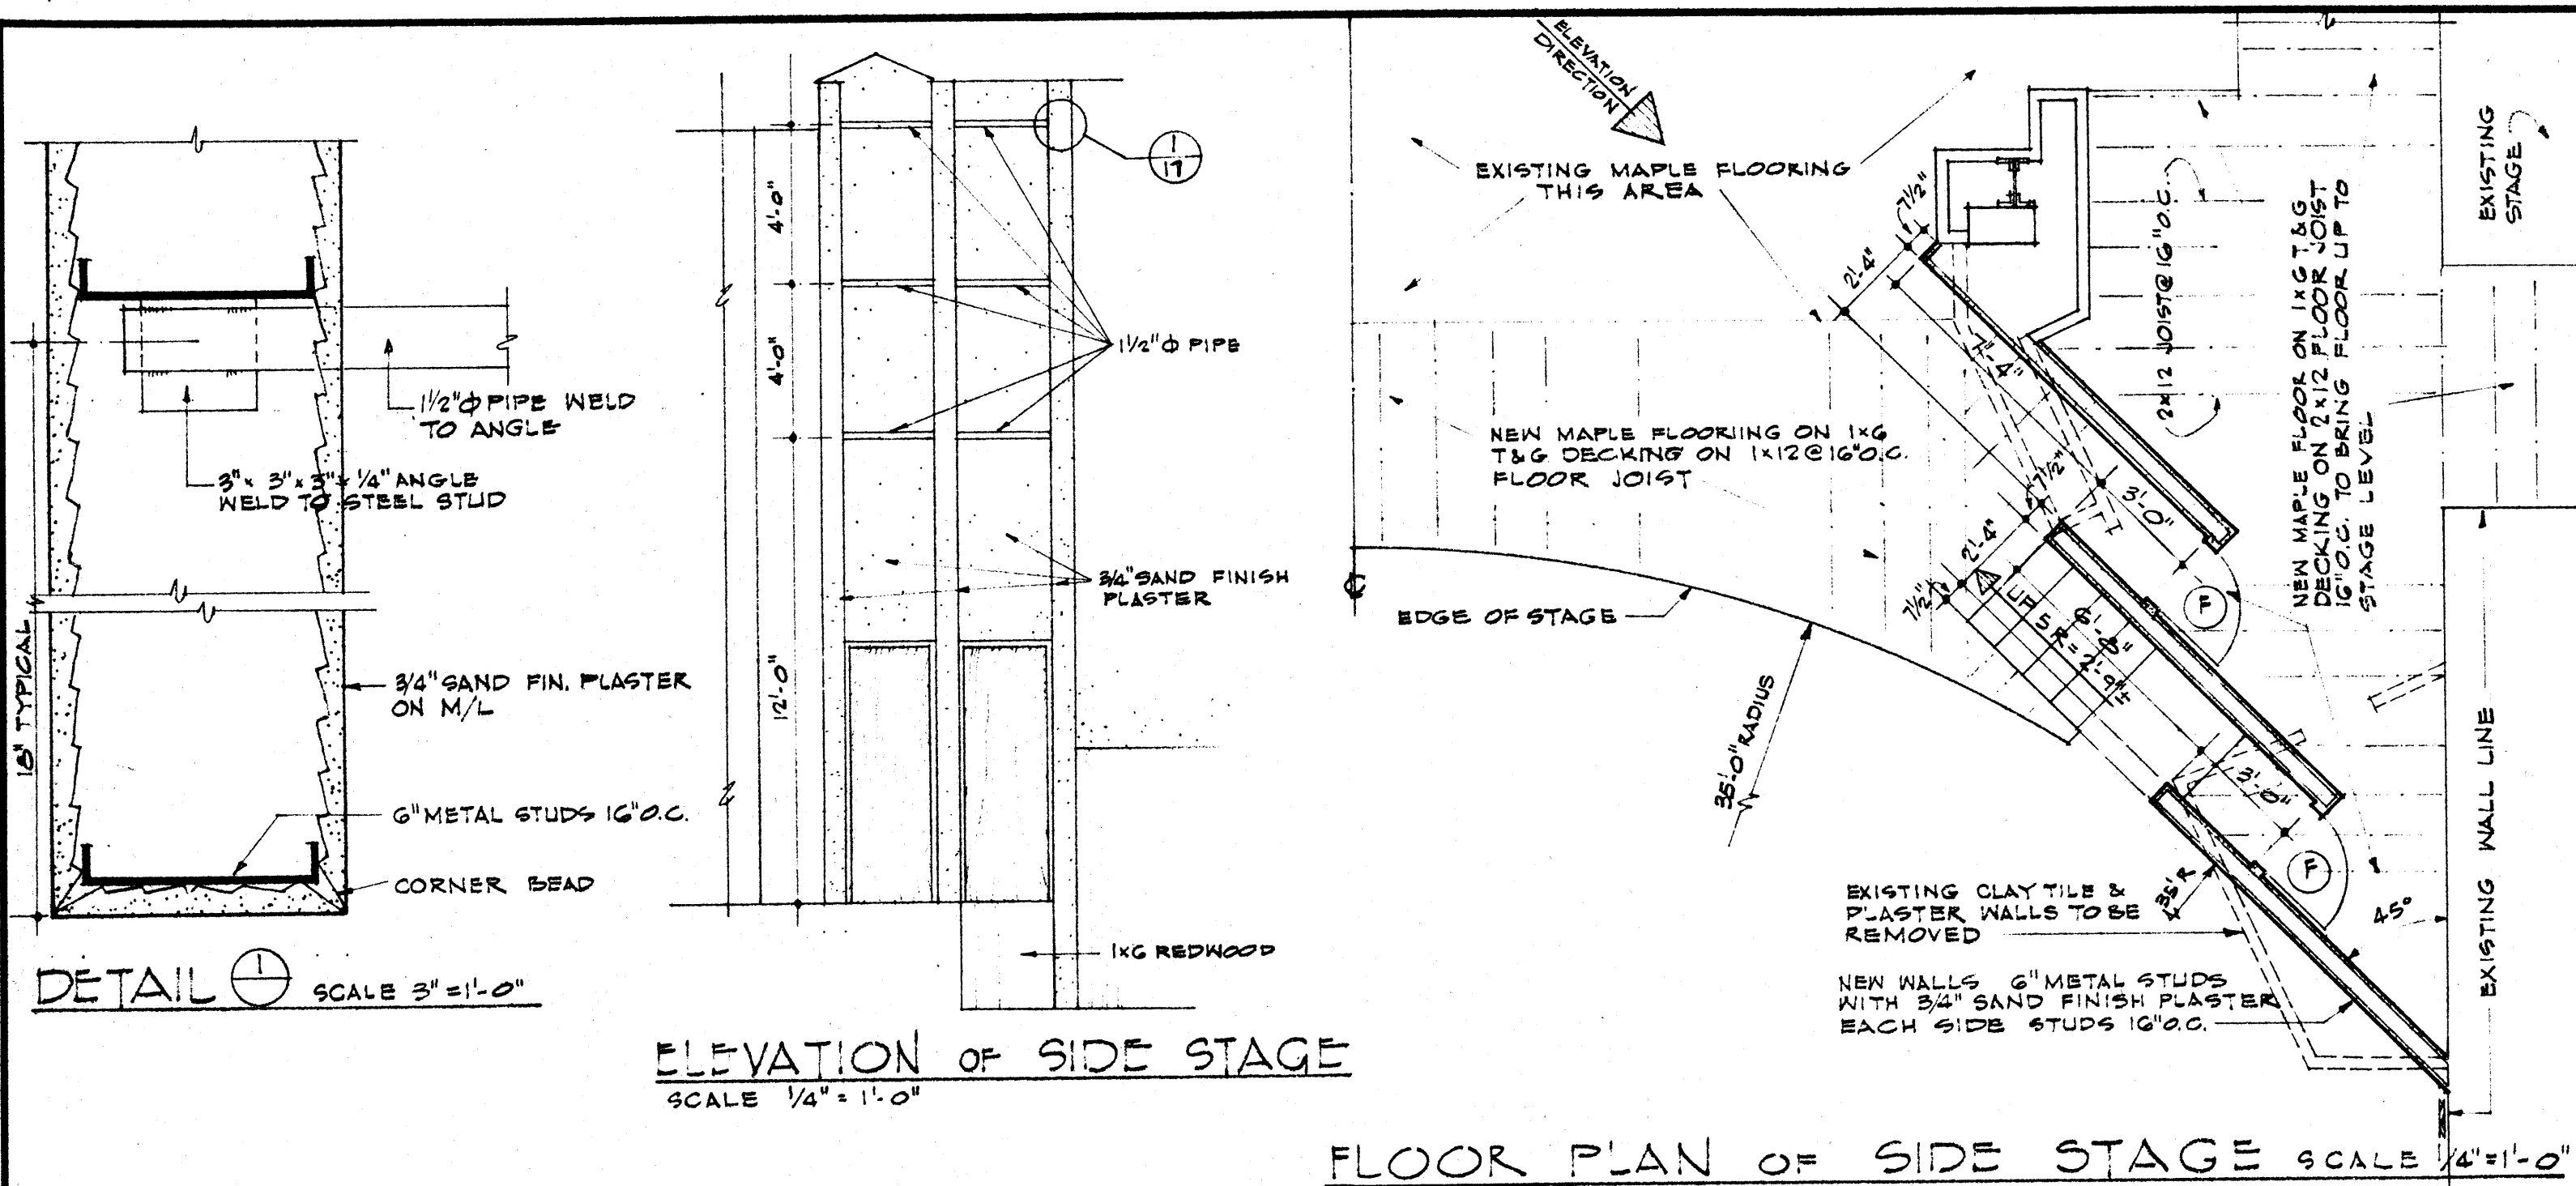

DETAIL ① SCALE 3" = 1'-0"


ELEVATION OF SIDE STAGE
SCALE 1/4" = 1'-0"

FLOOR PLAN OF SIDE STAGE SCALE 1/4" = 1'-0"

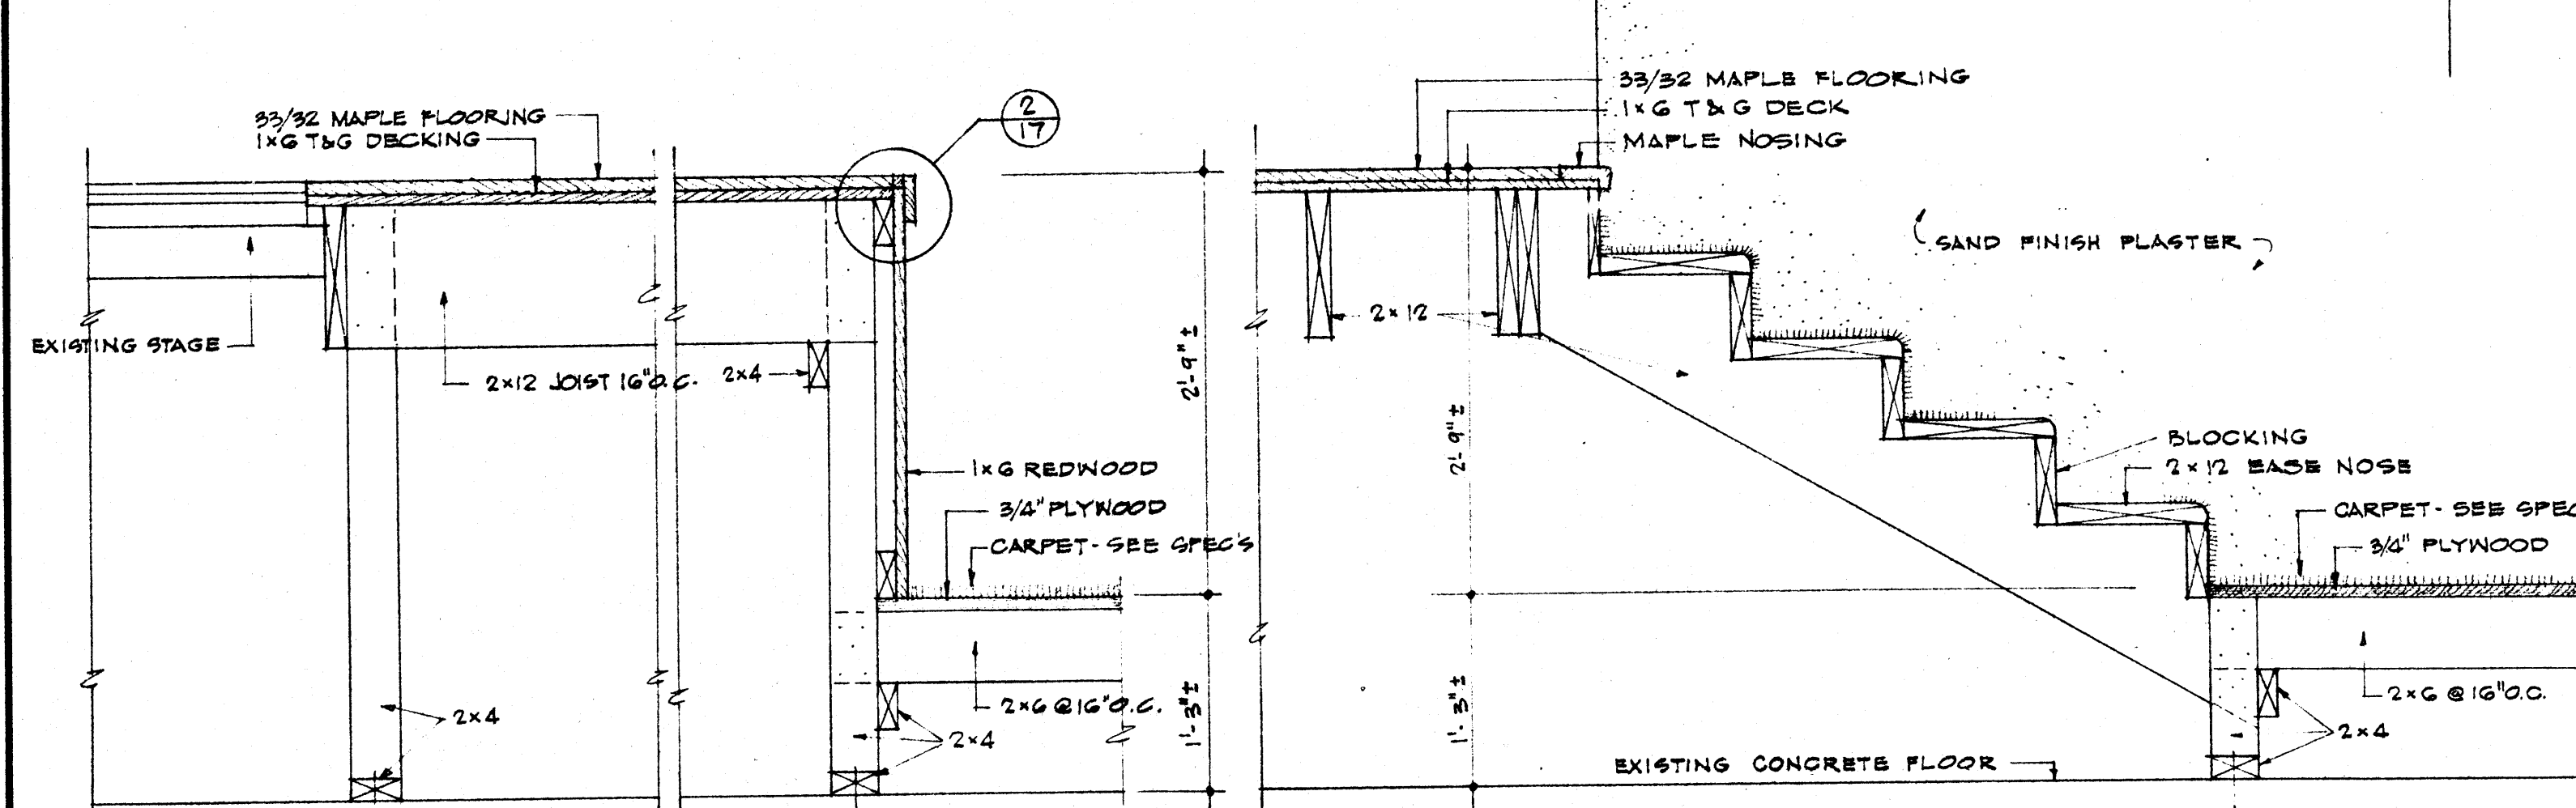


SECTION THRU FRONT OF STAGE
SCALE 1" = 1'-0"

SECTION THRU STAGE STEPS SCALE 1" = 1'-0"

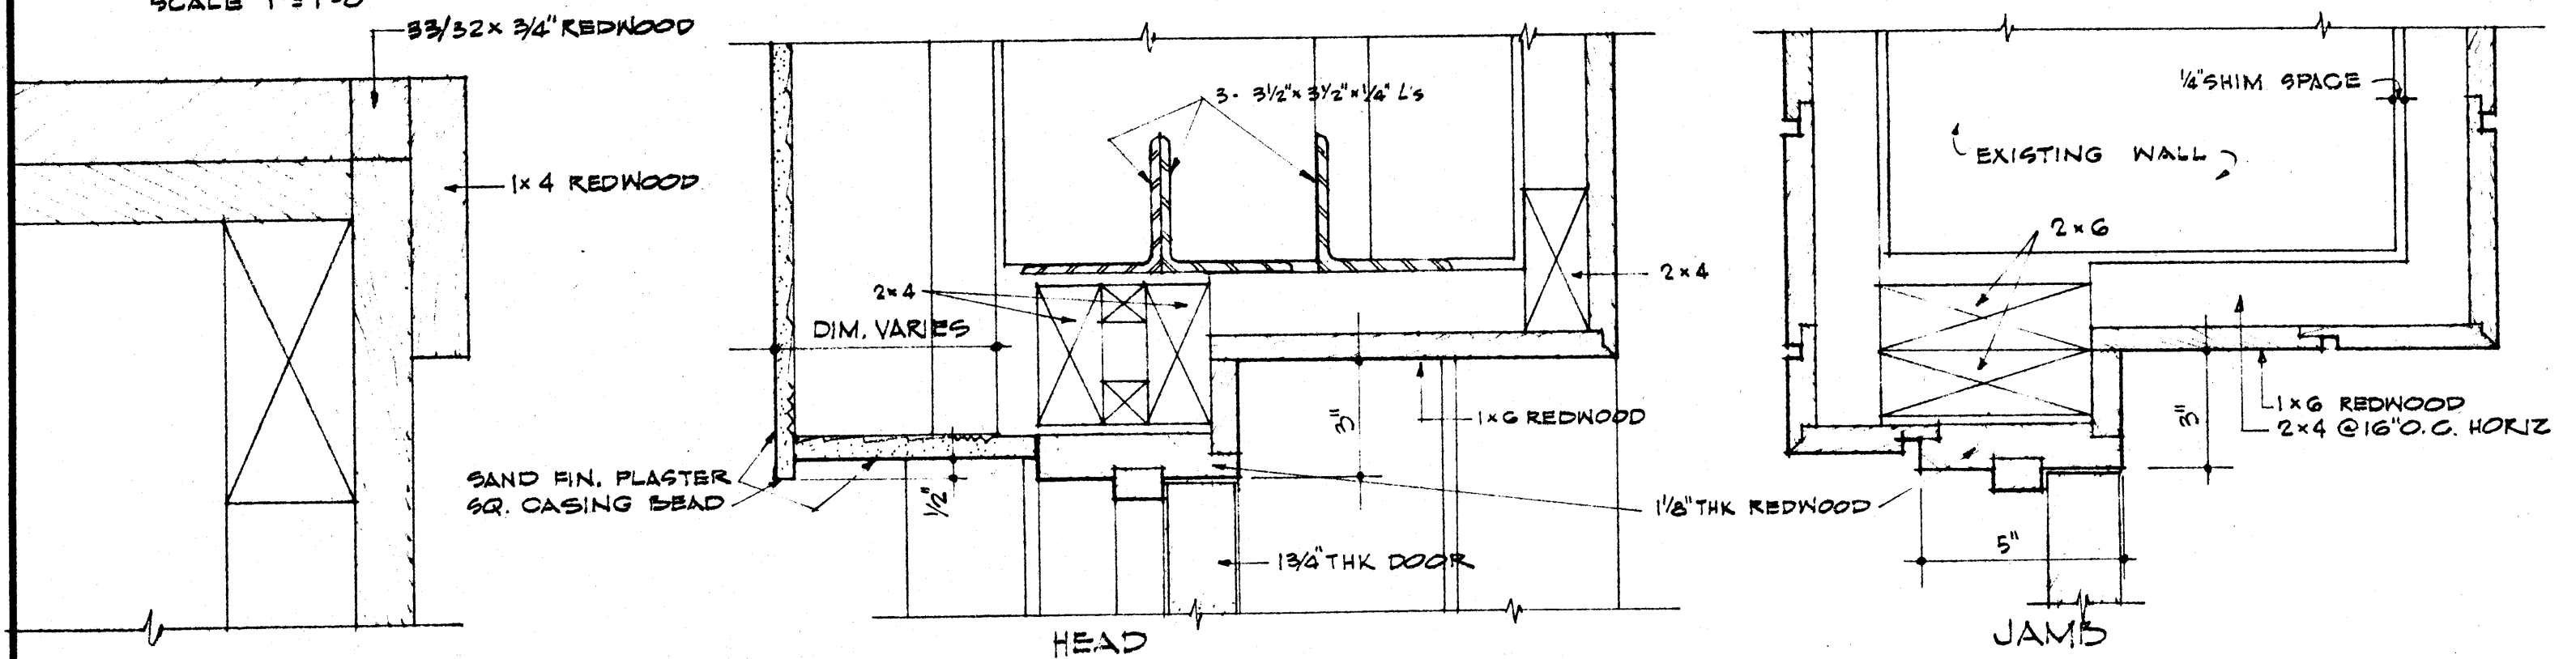


DETAIL ② HALF FULL SIZE

FOYER TO AUDITORIUM DOOR FRAME DETAILS SCALE 3" = 1'-0"

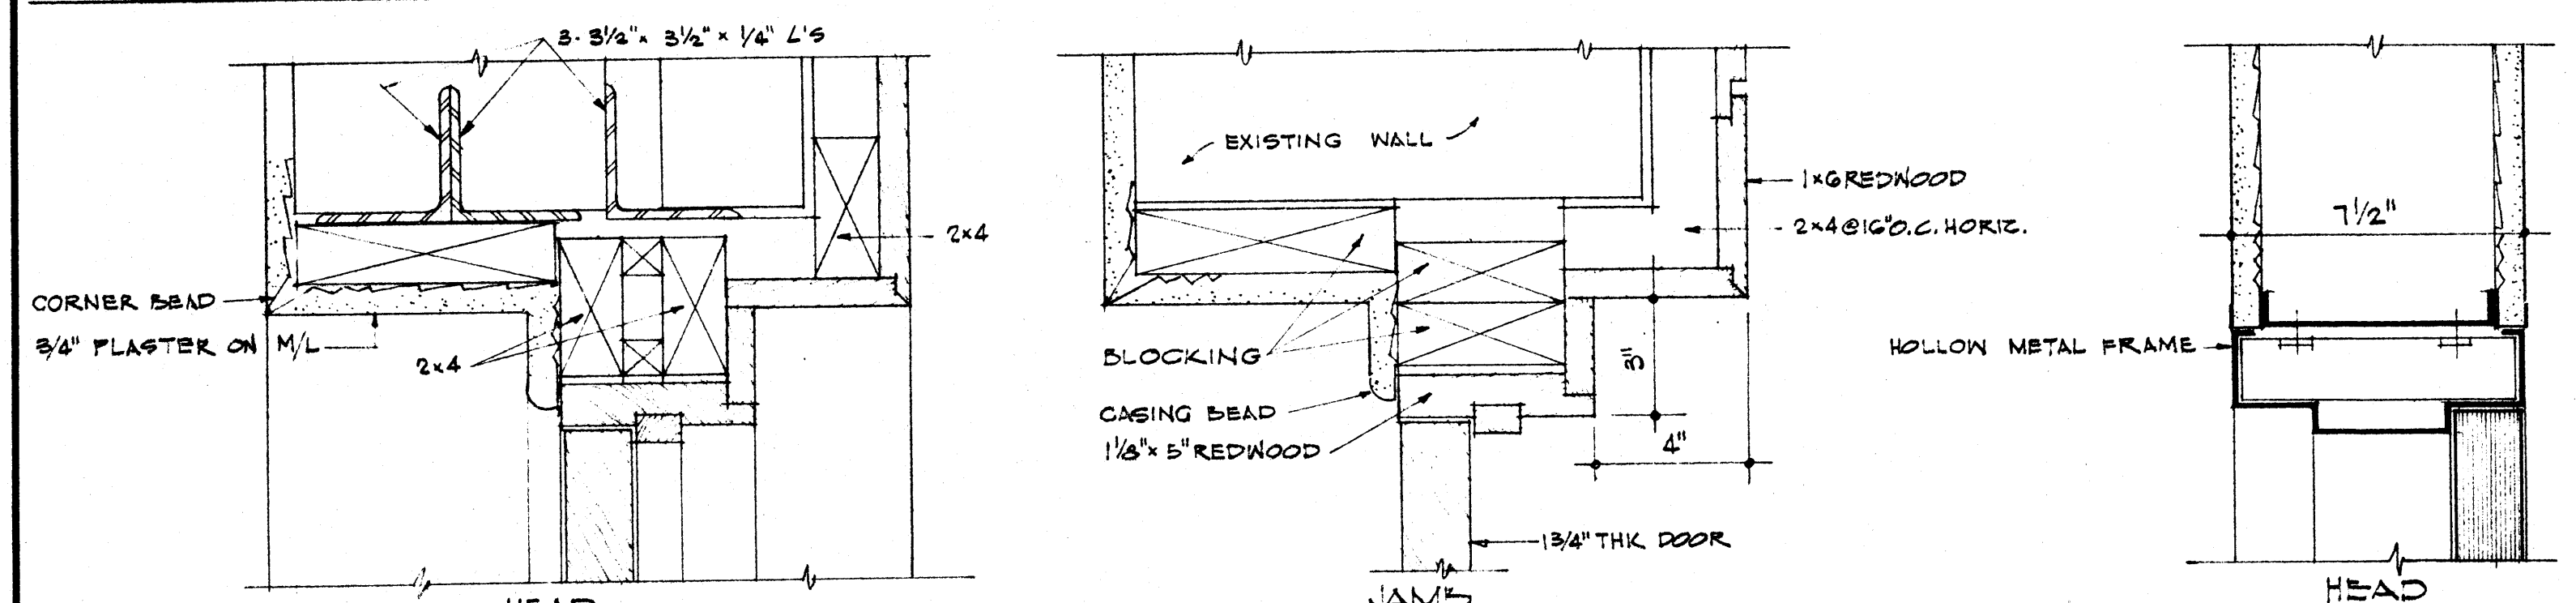


FOYER TO CORRIDOR DOOR FRAME DETAILS SCALE 3" = 1'-0"


SIDE STAGE DOOR FRAME DETAILS SCALE 3" = 1'-0"

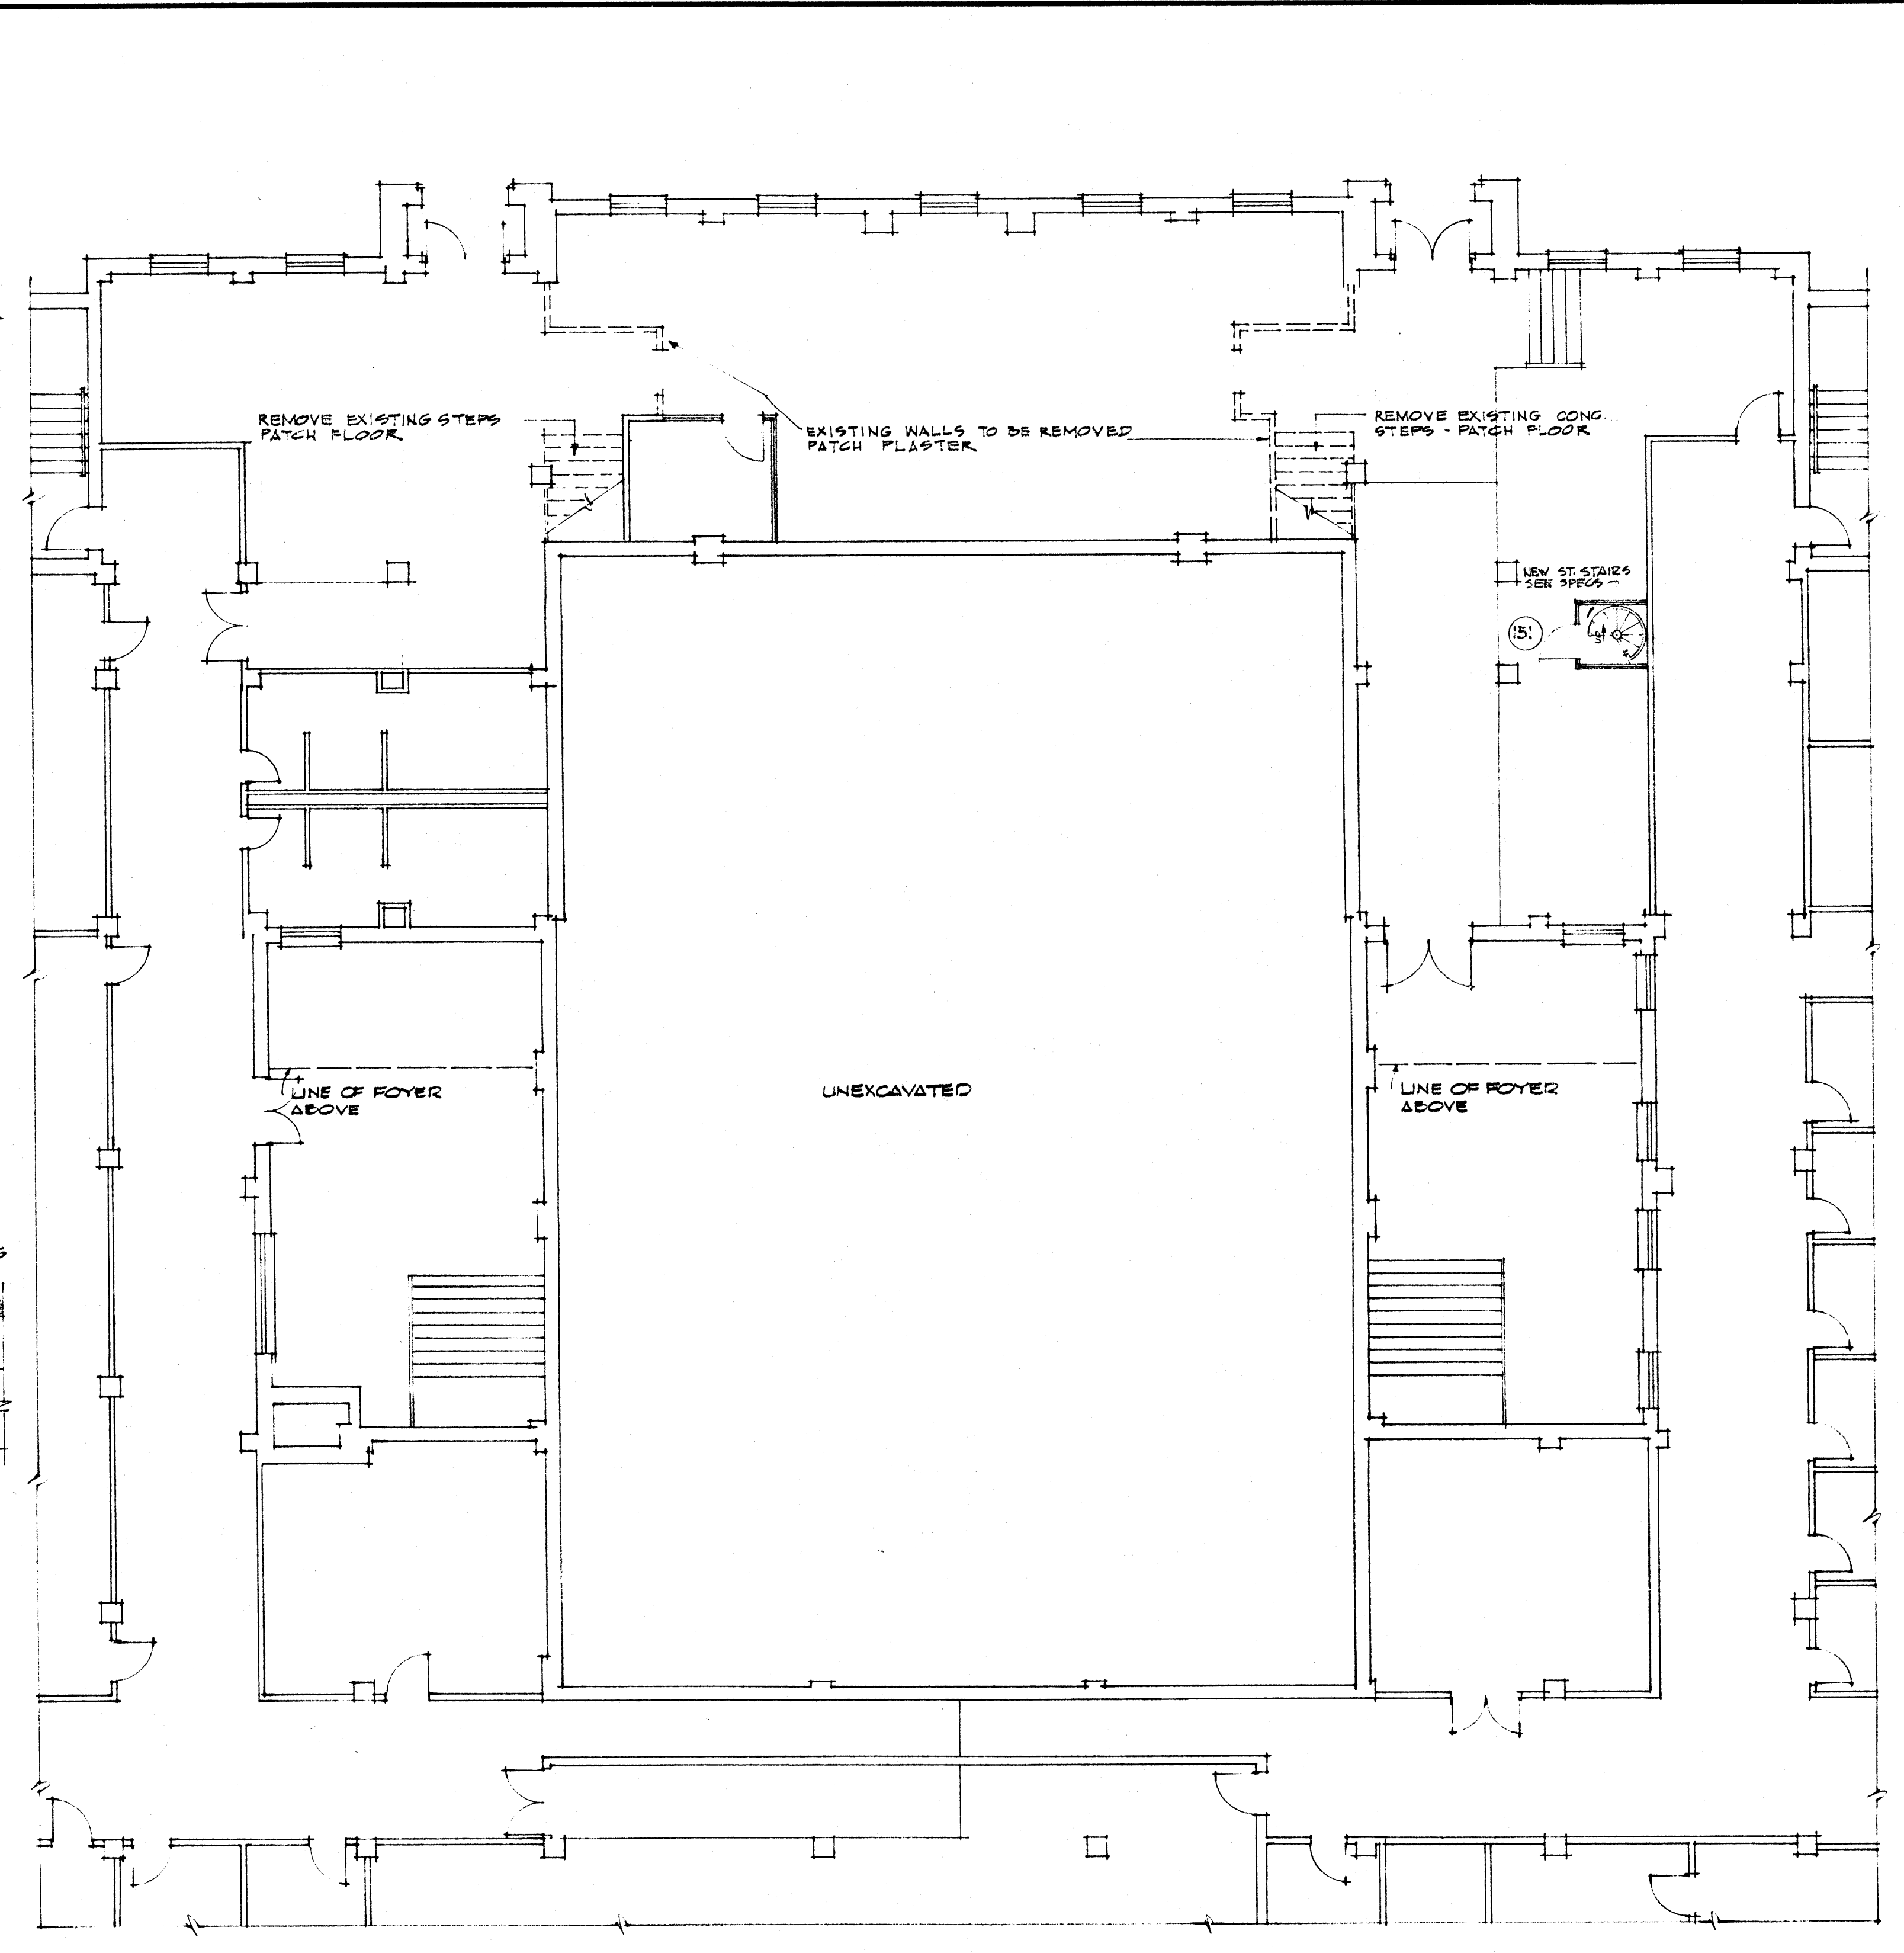

PARTIAL PLAN OF FIRST FLOOR SCALE 1/8" = 1'-0"

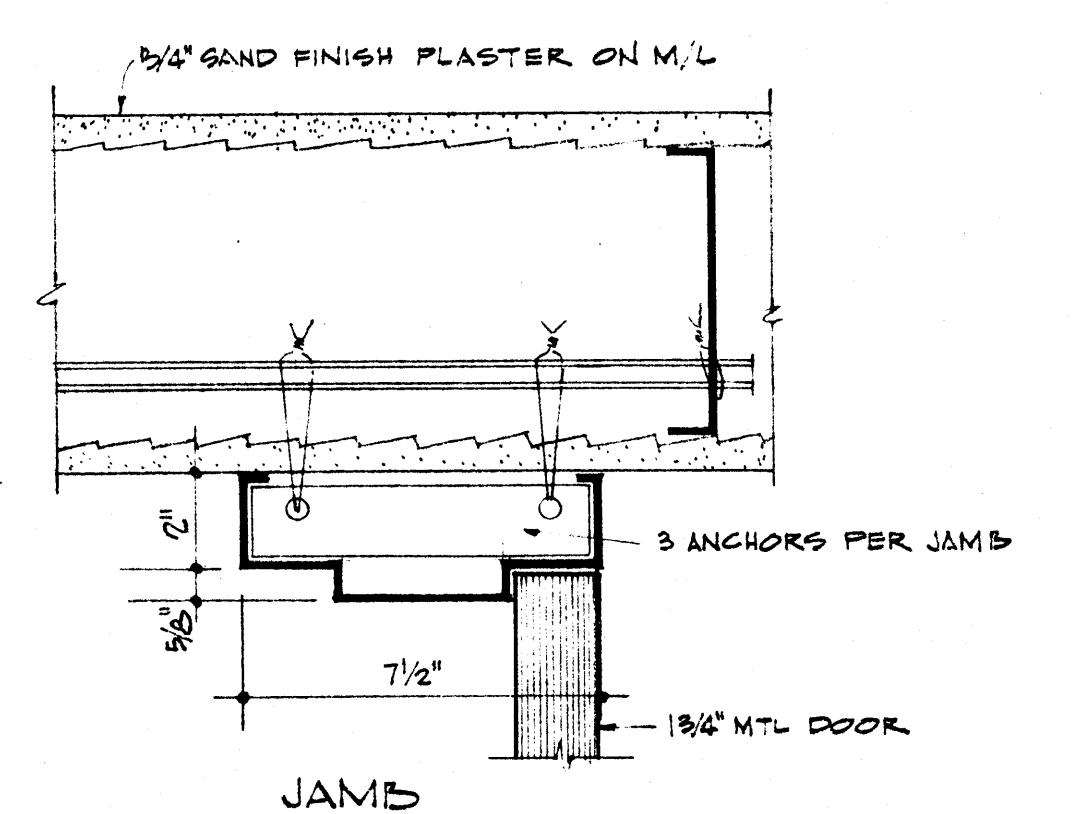

JAMB SCALE 3" = 1'-0"

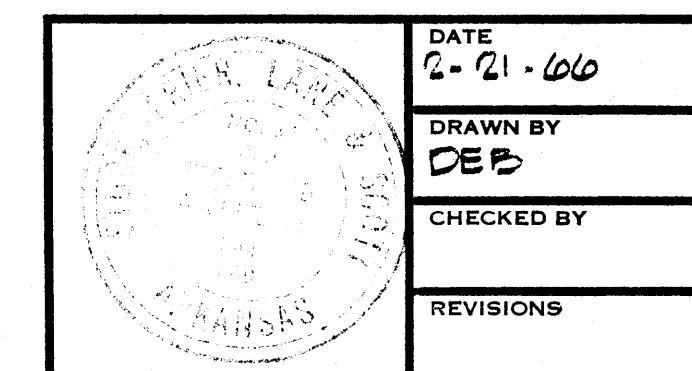


DATE 2-21-66
DRAWN BY DEB
CHECKED BY
REVISIONS


RENOVATION TO
VILSON HALL
ARKANSAS STATE COLLEGE
JONESBORO, ARKANSAS

STUCK, FRIER, LANE & SCOTT, INC., ARCHITECTS
601 SOUTHWEST DRIVE • JONESBORO, ARKANSAS

SHEET NUMBER
A-17
COMMISSION NUMBER
43866

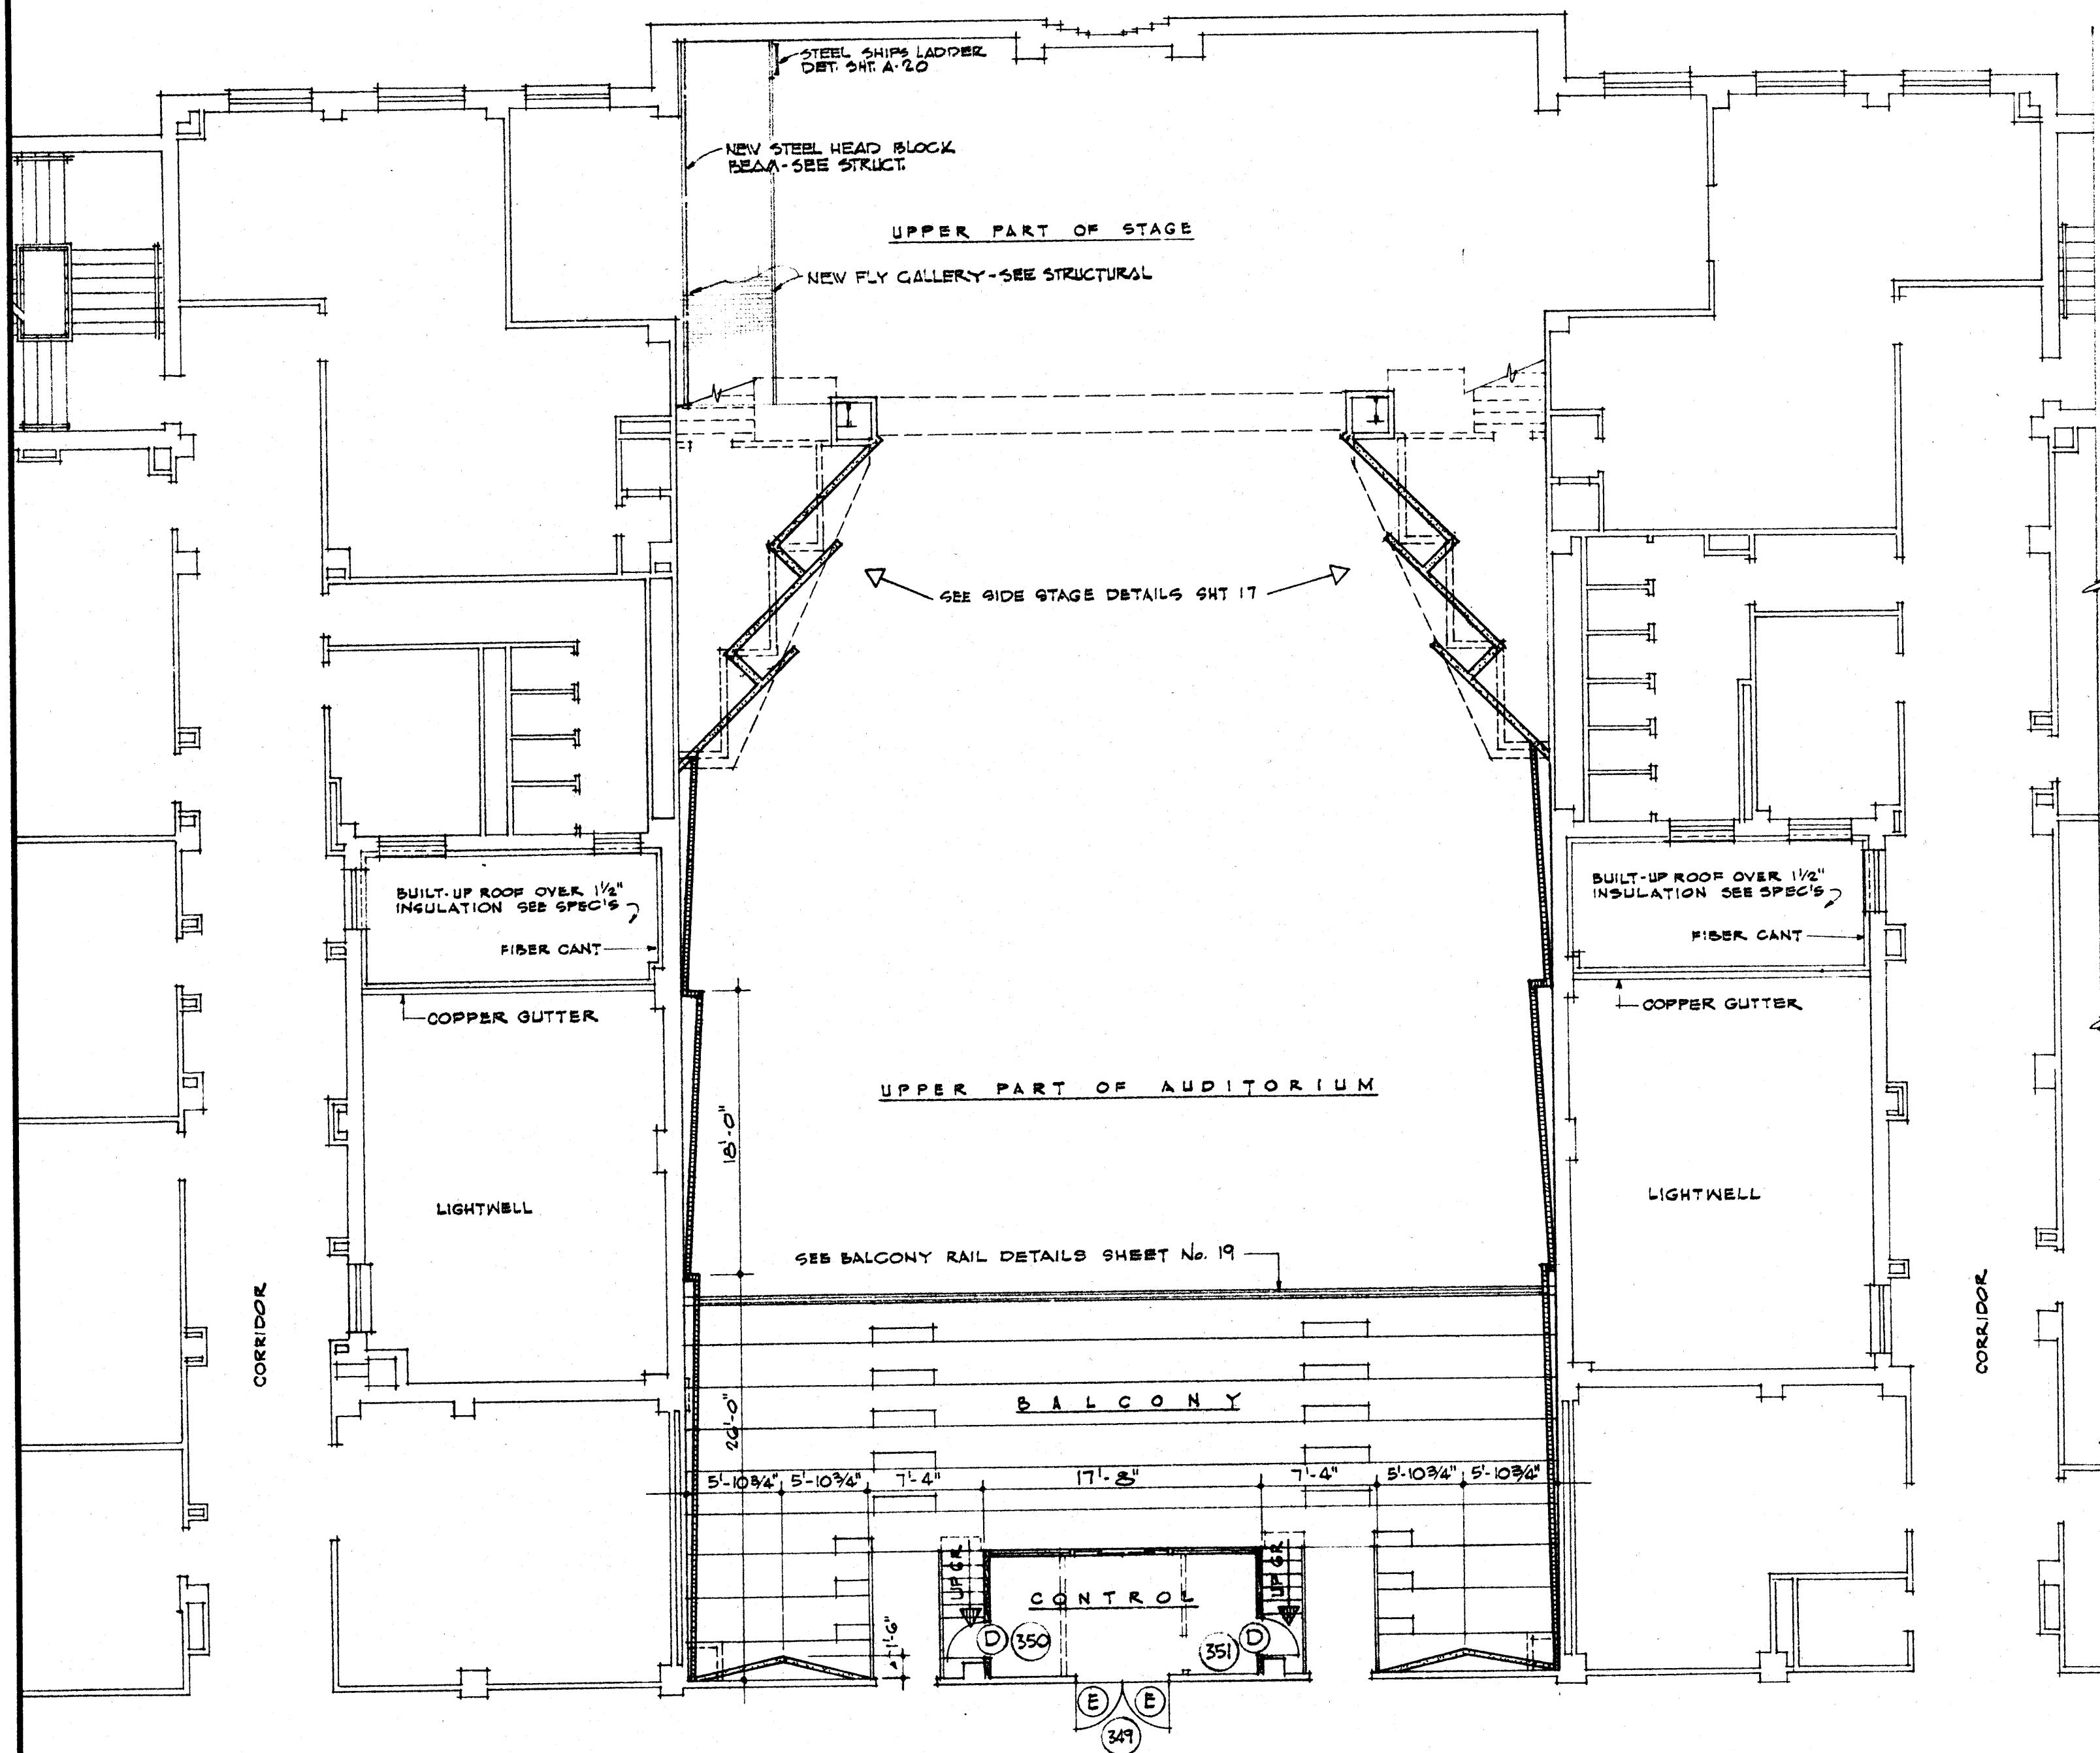


PARTIAL PLAN SHOWING AUDITORIUM THIRD FLOOR
SCALE 1/8" = 1'-0"

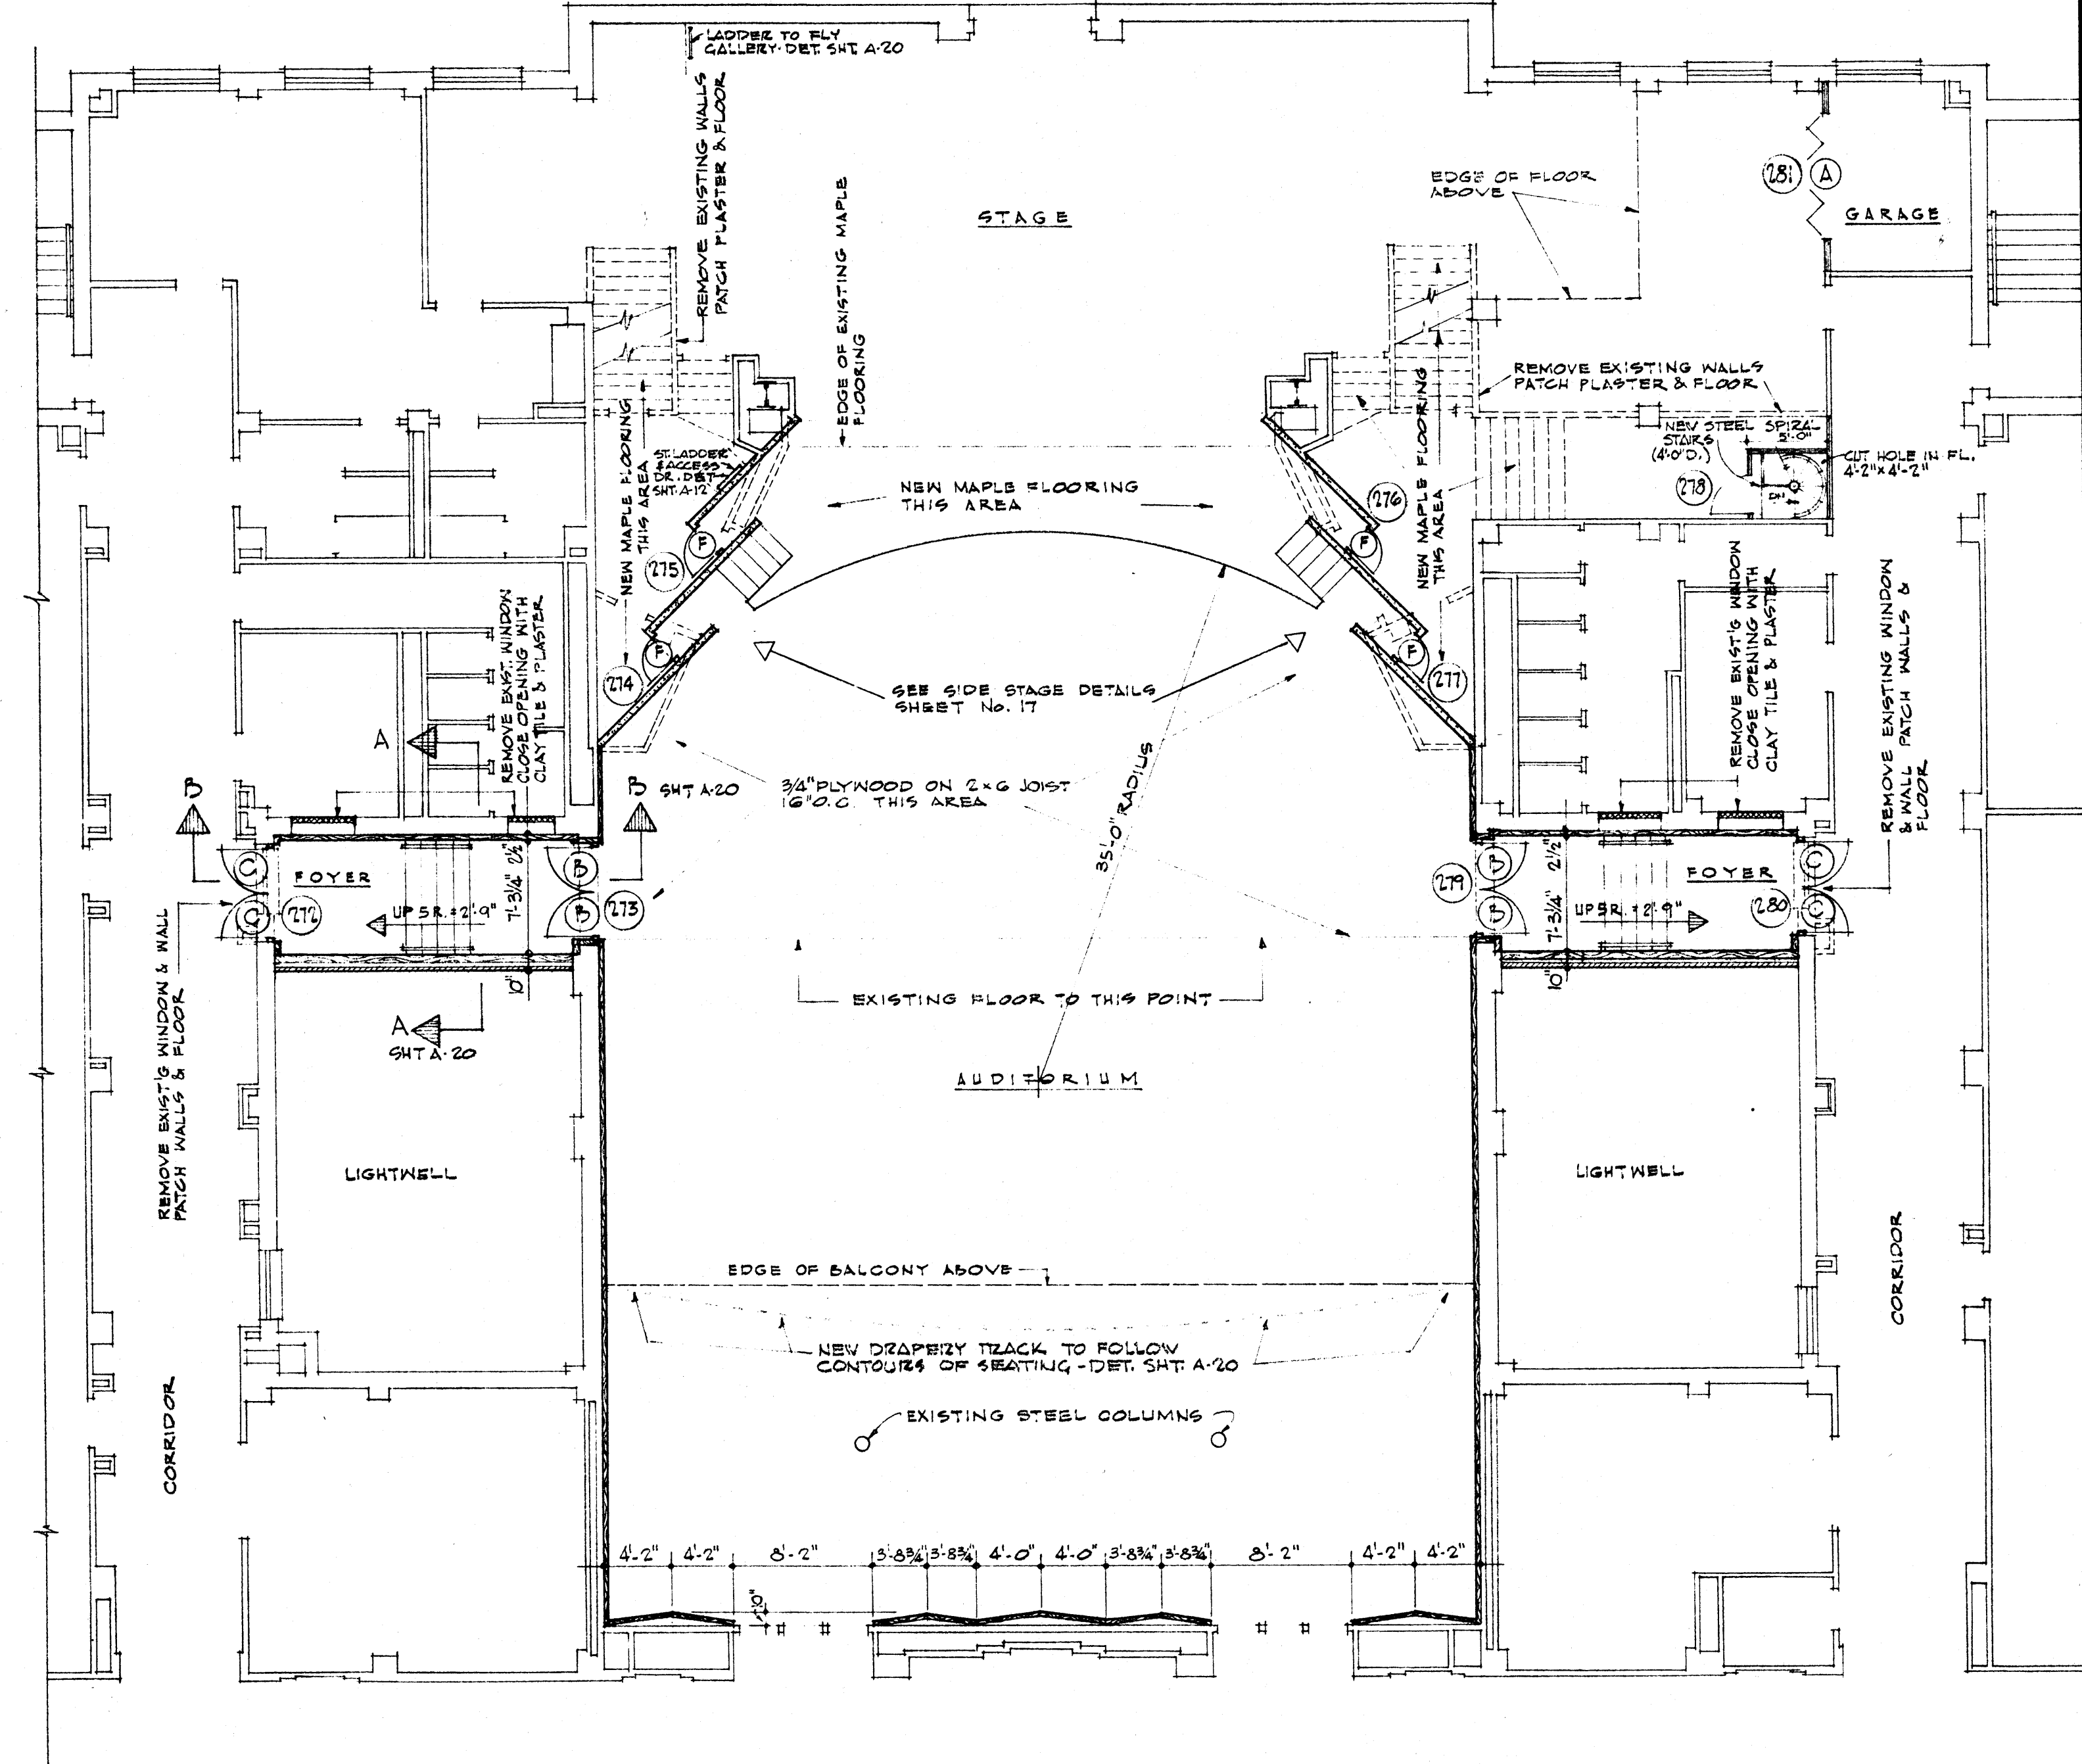


PARTIAL PLAN SHOWING AUDITORIUM SECOND FLOOR
SCALE 1/8" = 1'-0"

INTERIOR FINISH SCHEDULE

AREA	FLOOR	BASE	WAINSCOT	WALLS	CEILING	CLG HGT	REMARKS
SCENE SHOP	EXPOSED CONCRETE	MATCH EXISTING	---	PATCH PLASTER WHERE WALLS HAVE BEEN REMOVED	EXPOSED CONCRETE	---	
GARAGE	EXISTING WOOD SANDED & REFINISHED - SEE SPEC'S	MATCH EXISTING	---	SAND FINISH PLASTER ON NEW WALL - EXISTING & NEW WALL PAINT	EXISTING - PAINTED	---	
STAGE	EXISTING & NEW WOOD SANDED & REFINISHED SEE SPEC'S	MATCH EXISTING	---	SAND FINISH PLASTER ON NEW WALLS - EXISTING & NEW WALLS PAINTED	---	---	
AUDITORIUM	CARPET - SEE SPEC'S	---	---	REDWOOD - SEE SPEC'S SAND FINISH PLASTER-PAINTED	SAND FINISH PLASTER-PAINTED	SEE SECTIONS SHEET No. A-19	
BALCONY	CARPET - SEE SPEC'S	---	---	SAND FINISH PLASTER-PAINTED	SAND FINISH PLASTER-PAINTED	SEE SECTIONS SHEET No. A-19	
FOYERS	CARPET - SEE SPEC'S	---	---	REDWOOD - SEE SPEC'S	3/8" SUS. ACOUSTICAL	---	
CONTROL	1/8" VINYL ASBESTOS	4" VINYL TOP SET	---	SAND FINISH PLASTER-PAINTED	CONCRETE - PAINTED	---	

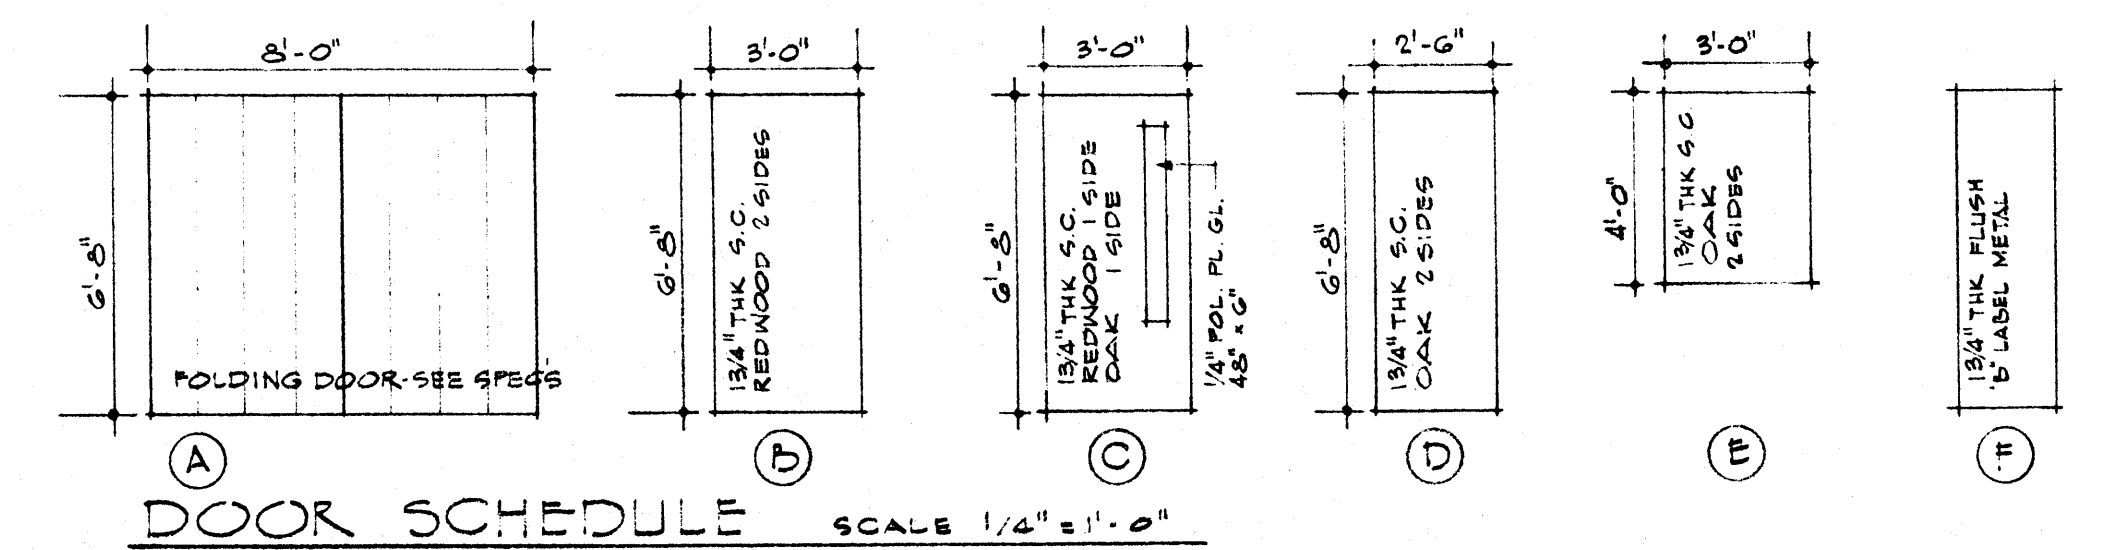

DOOR SCHEDULE SCALE 1/4" = 1'-0"

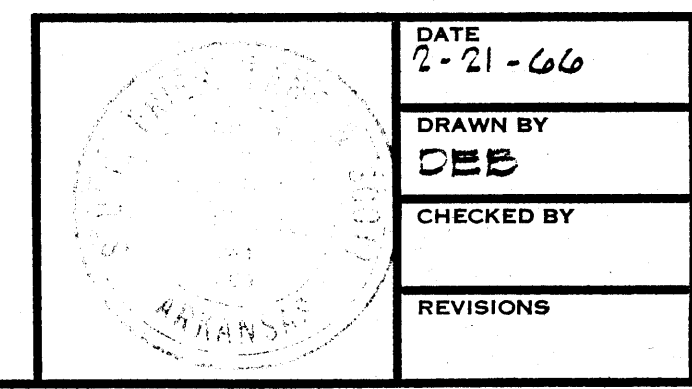


DATE 2-21-66
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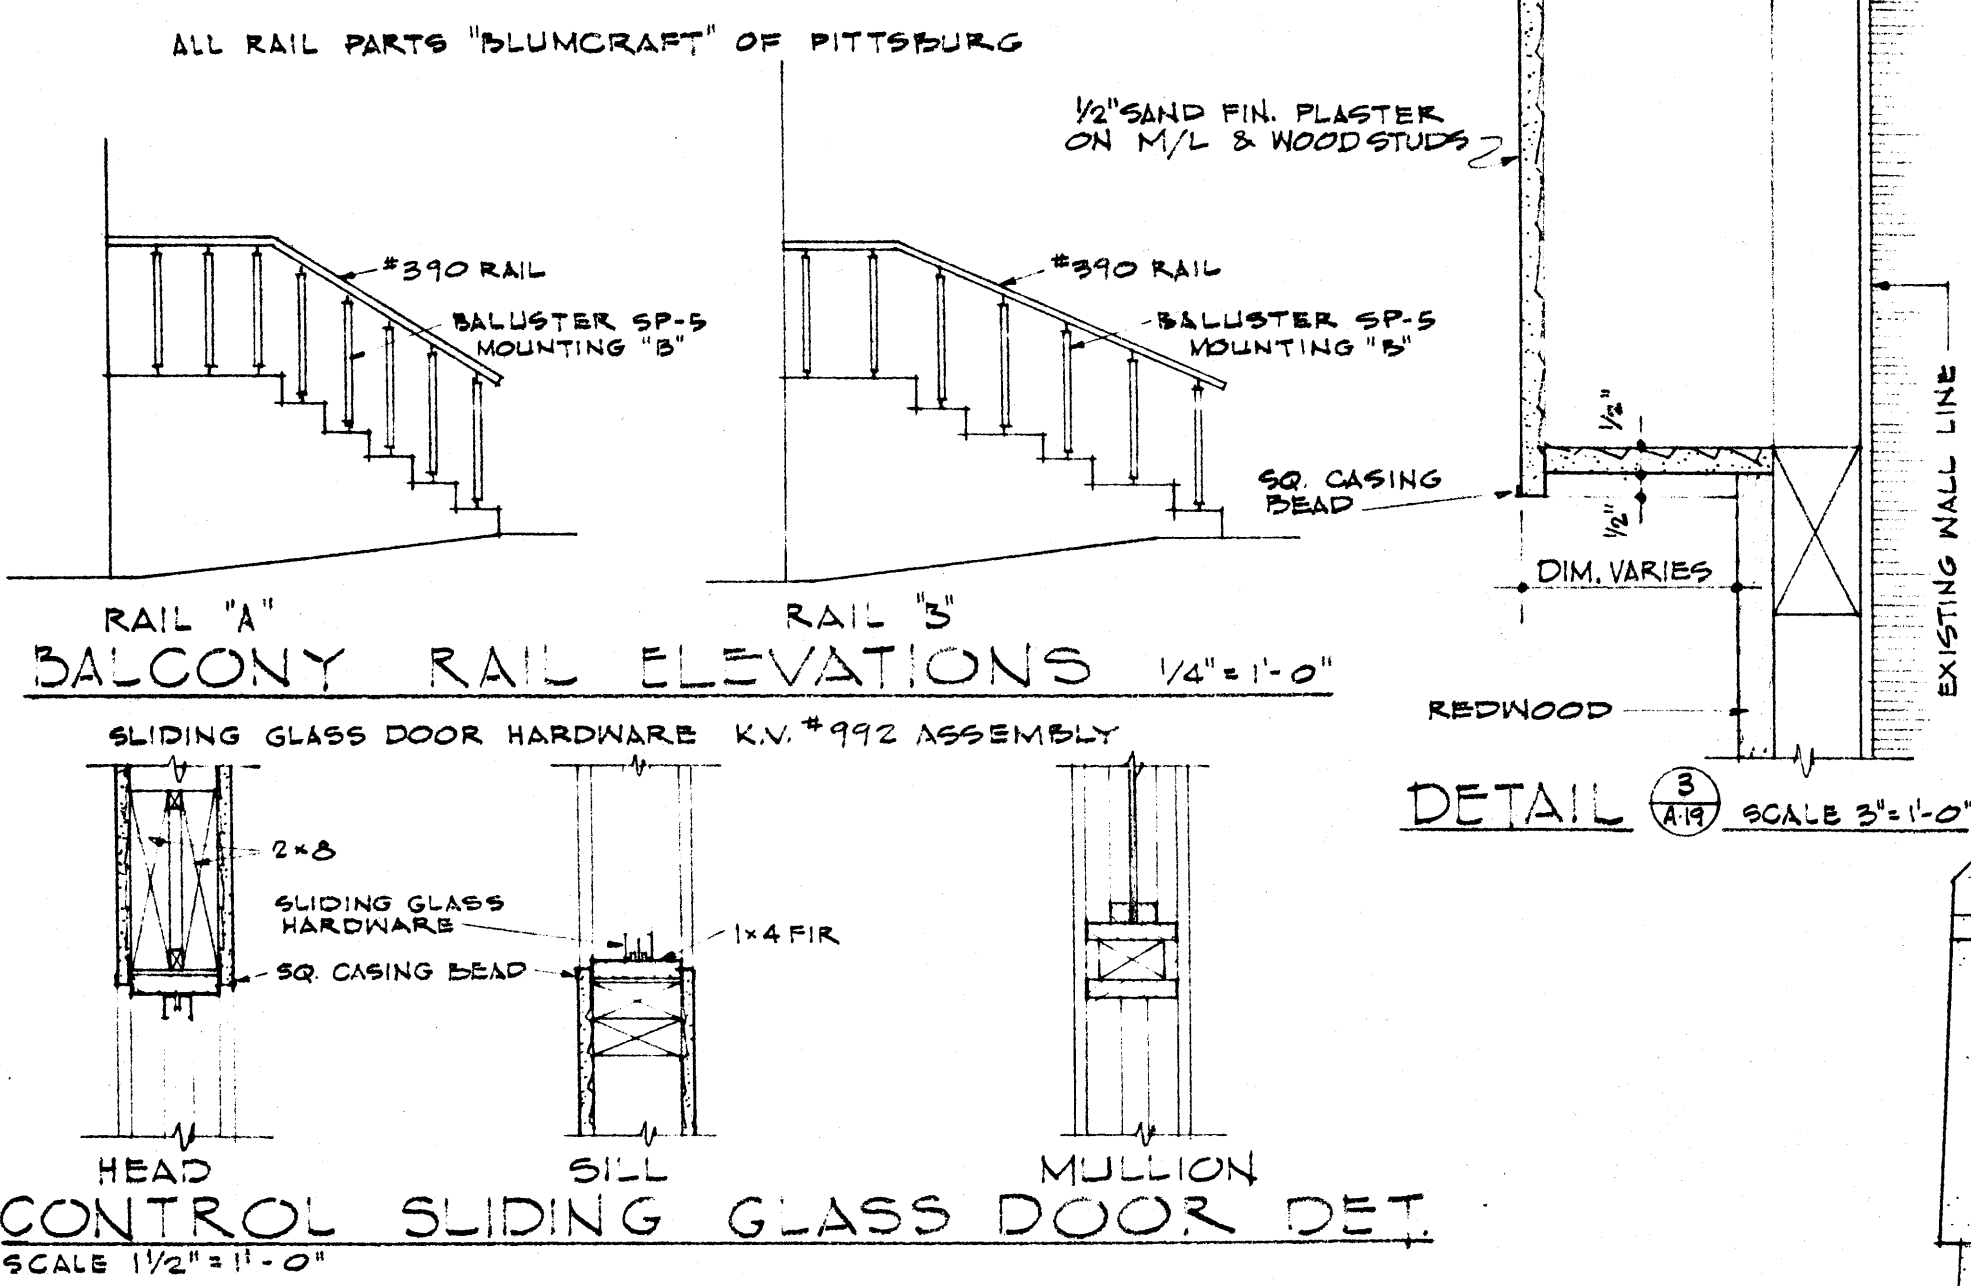
RENOVATIONS TO
WILSON HALL
 ARKANSAS STATE COLLEGE
 JONESBORO, ARKANSAS

STUCK, FRIER, LANE & SCOTT, INC., ARCHITECTS
 601 SOUTHWEST DRIVE • JONESBORO, ARKANSAS


SHEET NUMBER
A-18
 COMMISSION NUMBER
 43266

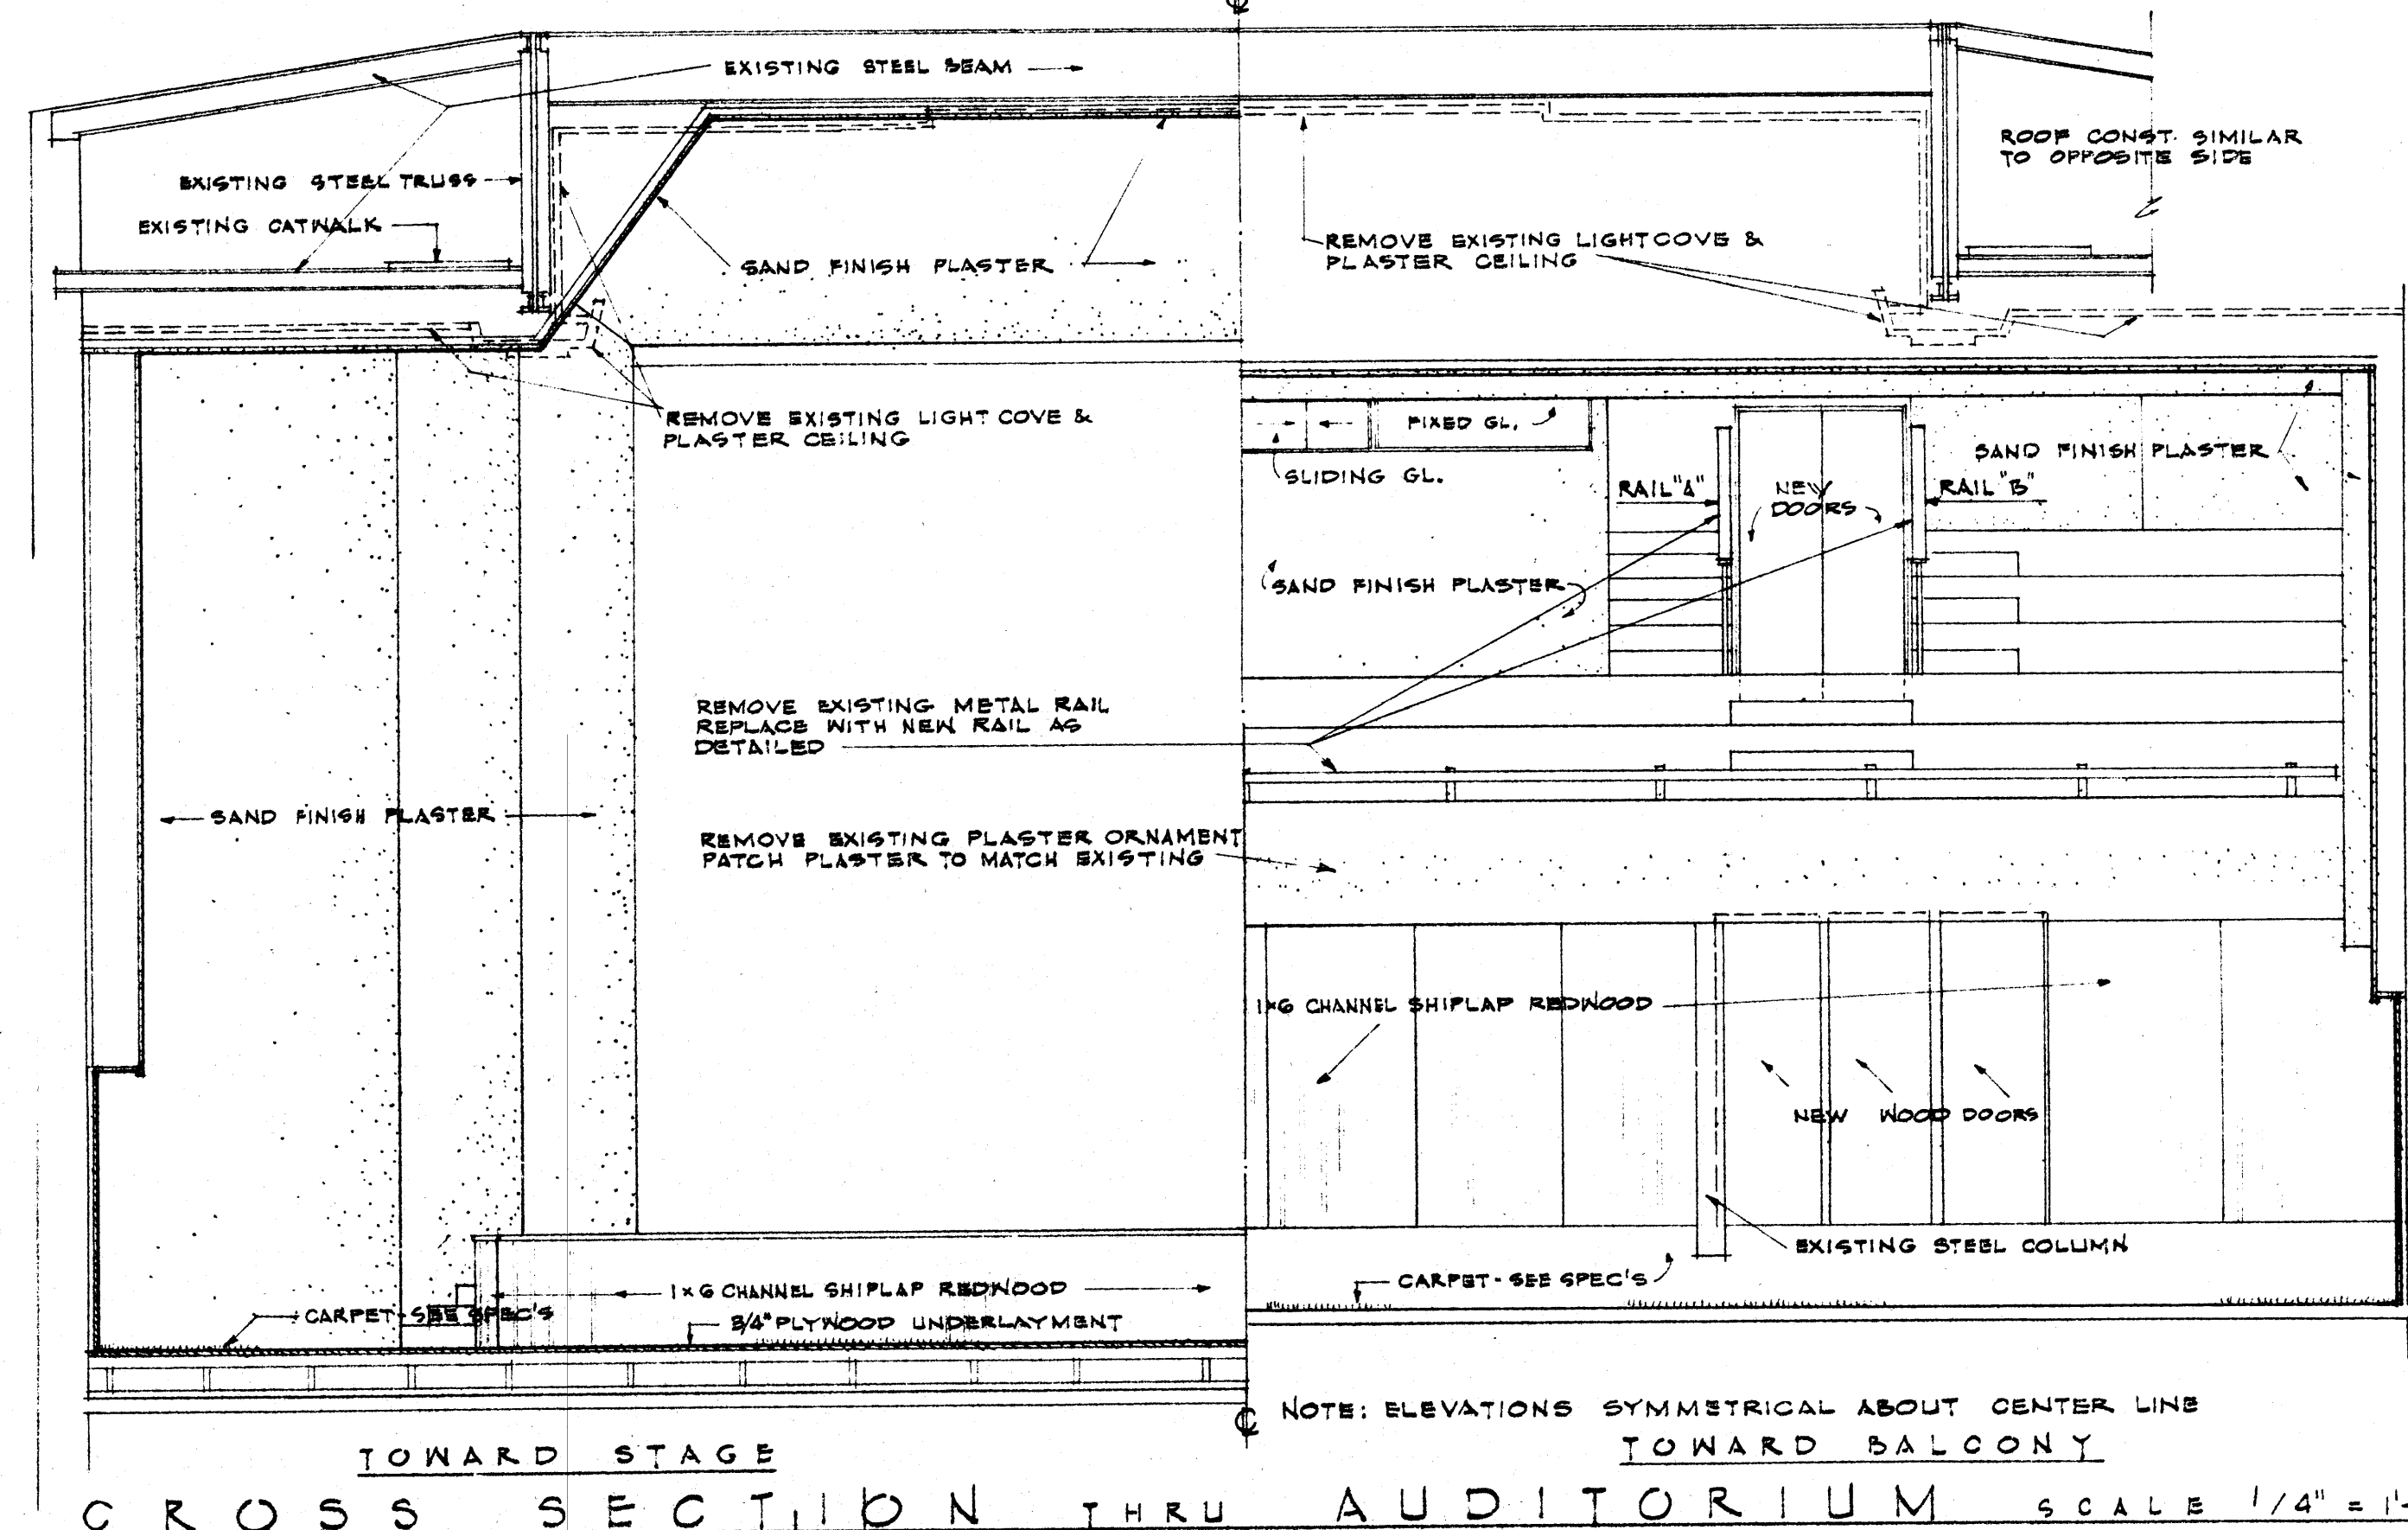


TOWARD STAGE TOWARD BALCONY
CROSS SECTION THRU AUDITORIUM SCALE 1/4" = 1'-0"




RAIL "A" RAIL "B"
BALCONY RAIL ELEVATIONS 1/4" = 1'-0"

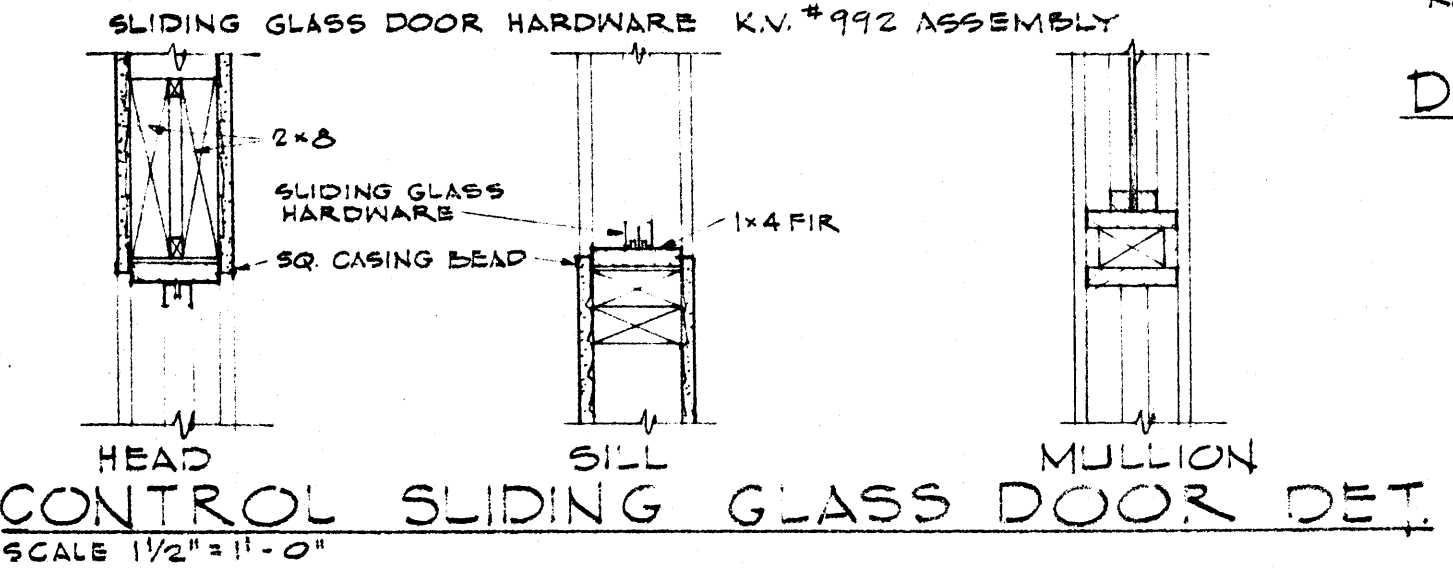


SLIDING GLASS DOOR HARDWARE K.V. #992 ASSEMBLY
CONTROL SLIDING GLASS DOOR DET. SCALE 1 1/2" = 1'-0"

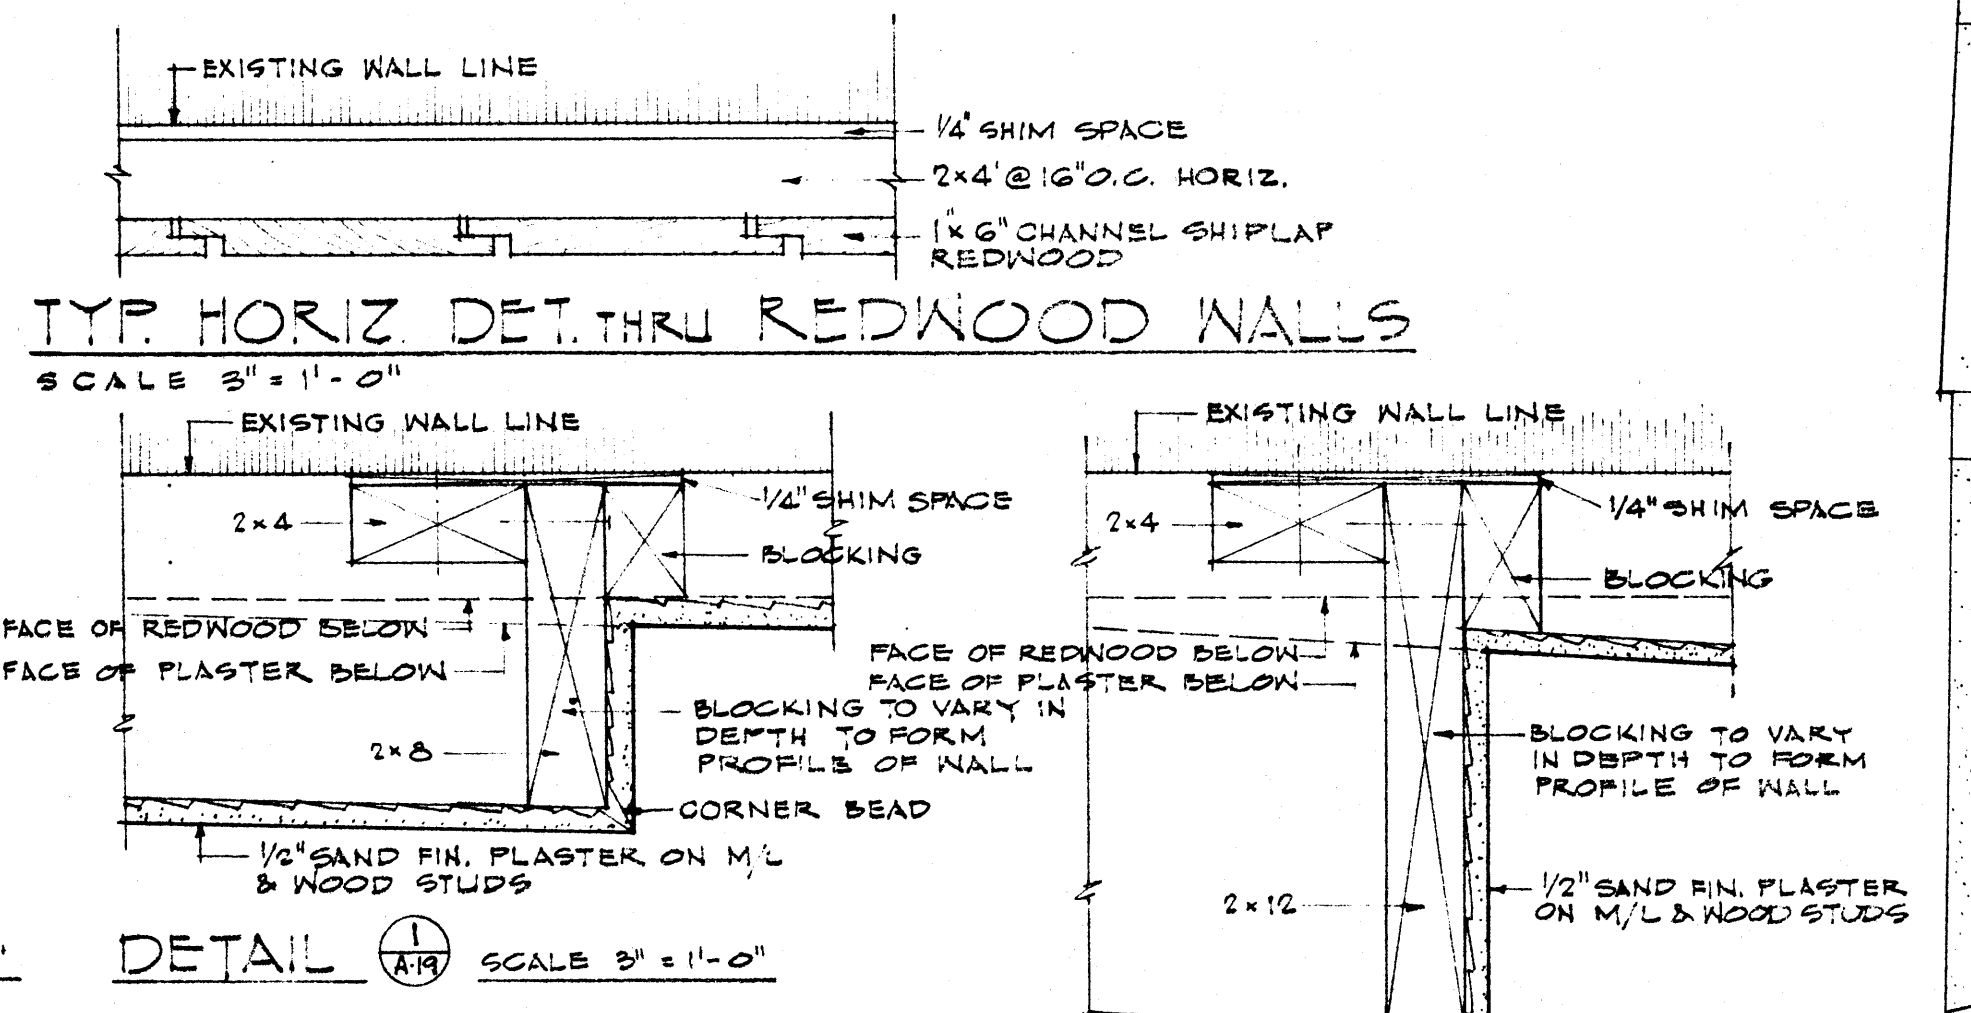


TYP. HORIZ DET. THRU REDWOOD WALLS SCALE 3" = 1'-0"

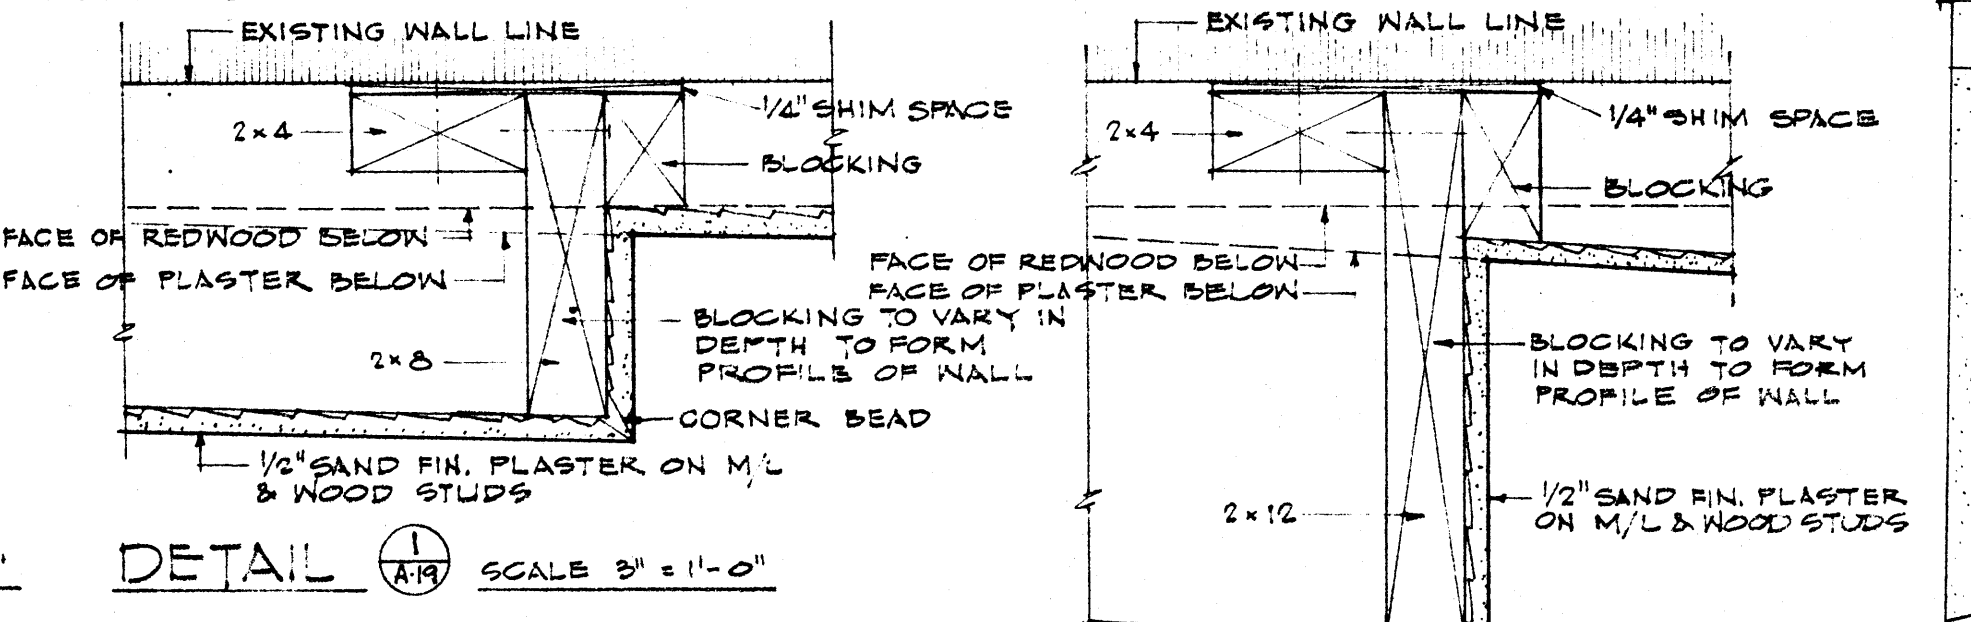


DETAIL 1 SCALE 3" = 1'-0"

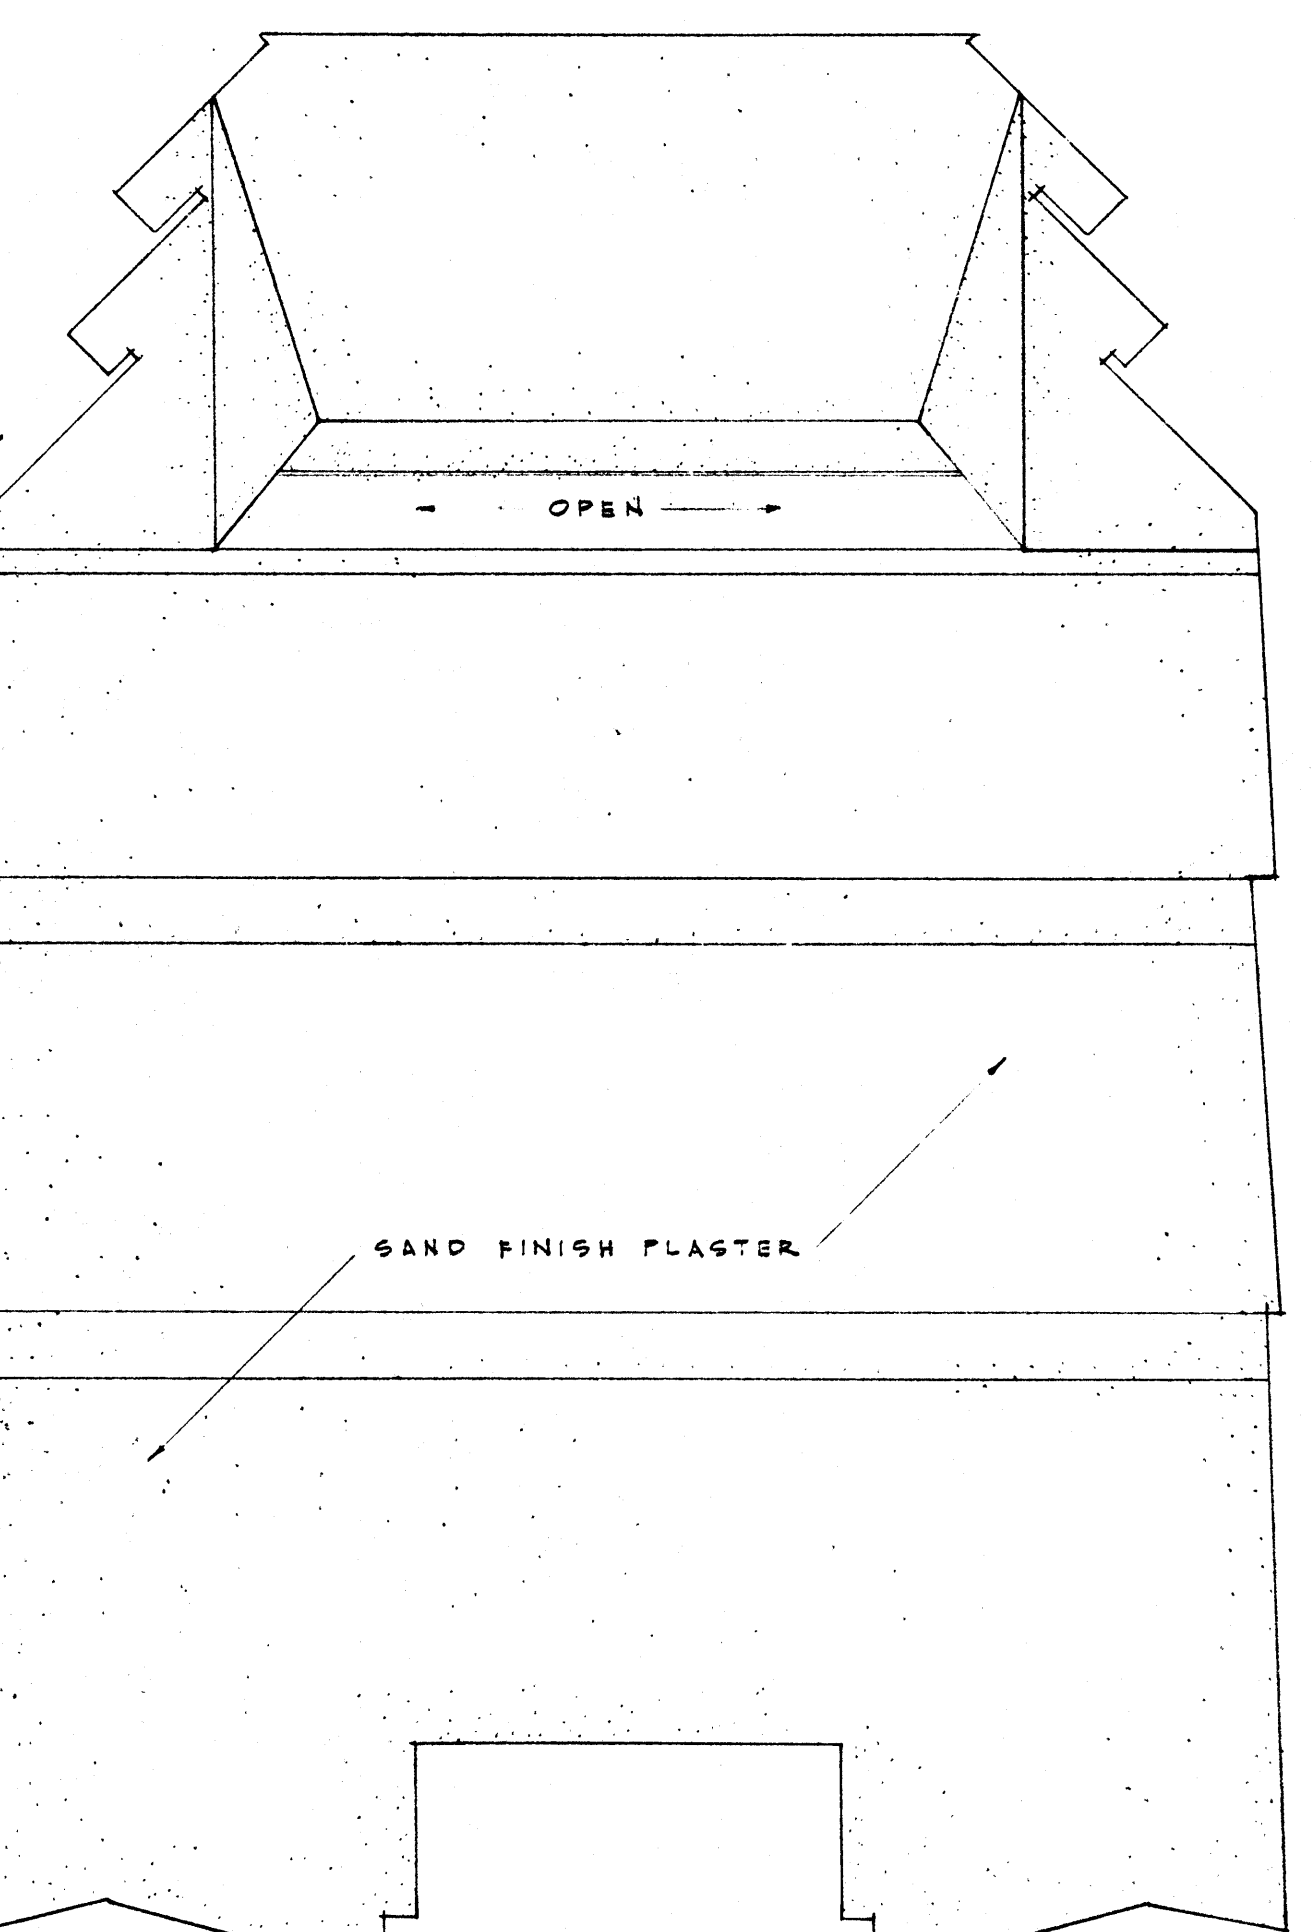


REFLECTED CEILING PLAN 1/8" = 1'-0"

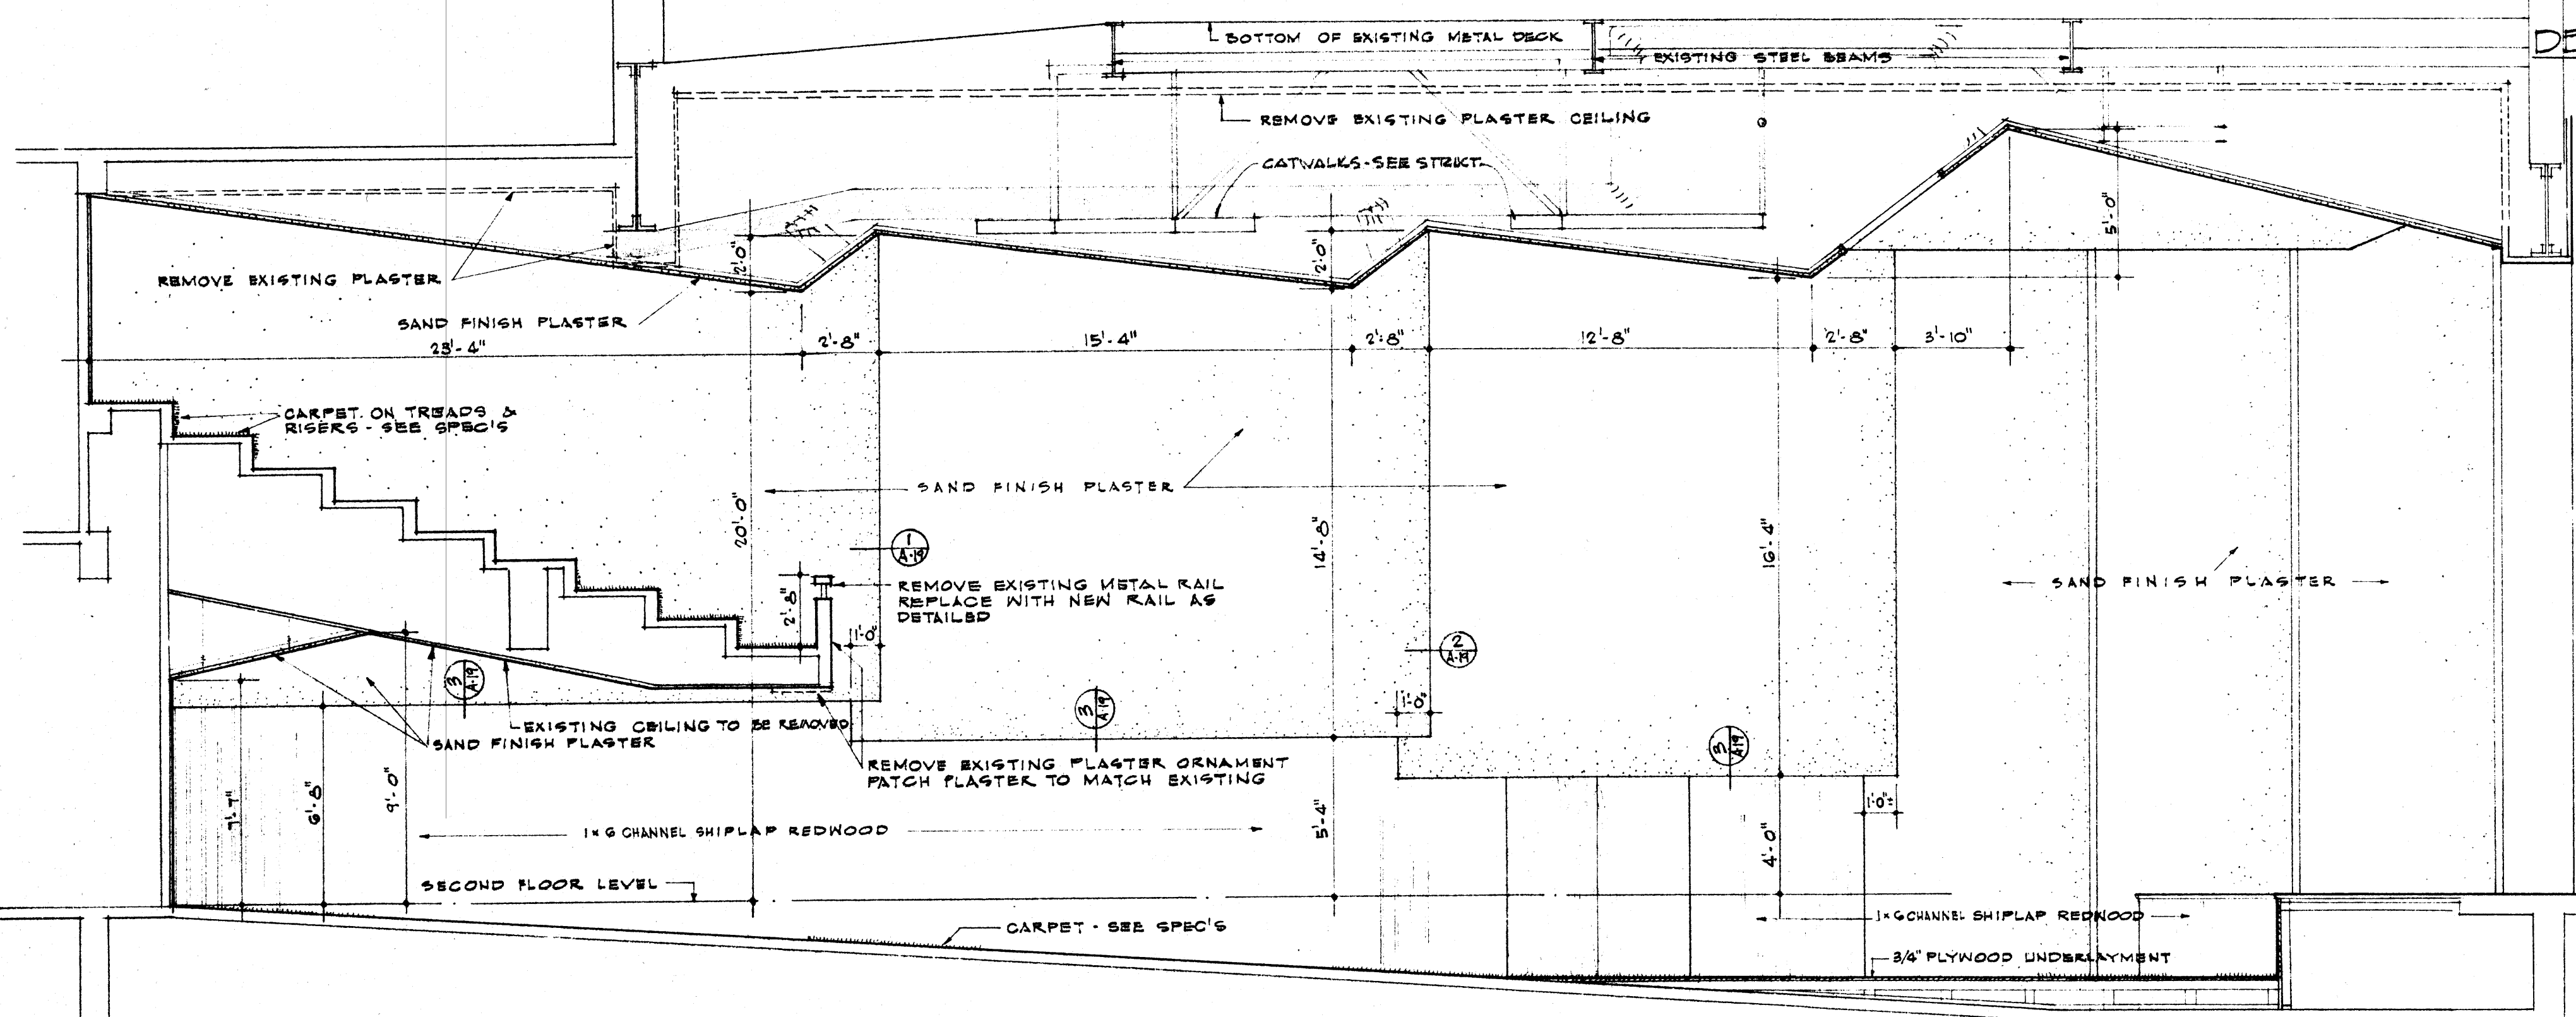


LONGITUDINAL SECTION THRU AUDITORIUM SHOWING EAST ELEVATION - WEST ELEVATION SIMILAR BUT REVERSED
 SCALE 1/4" = 1'-0"

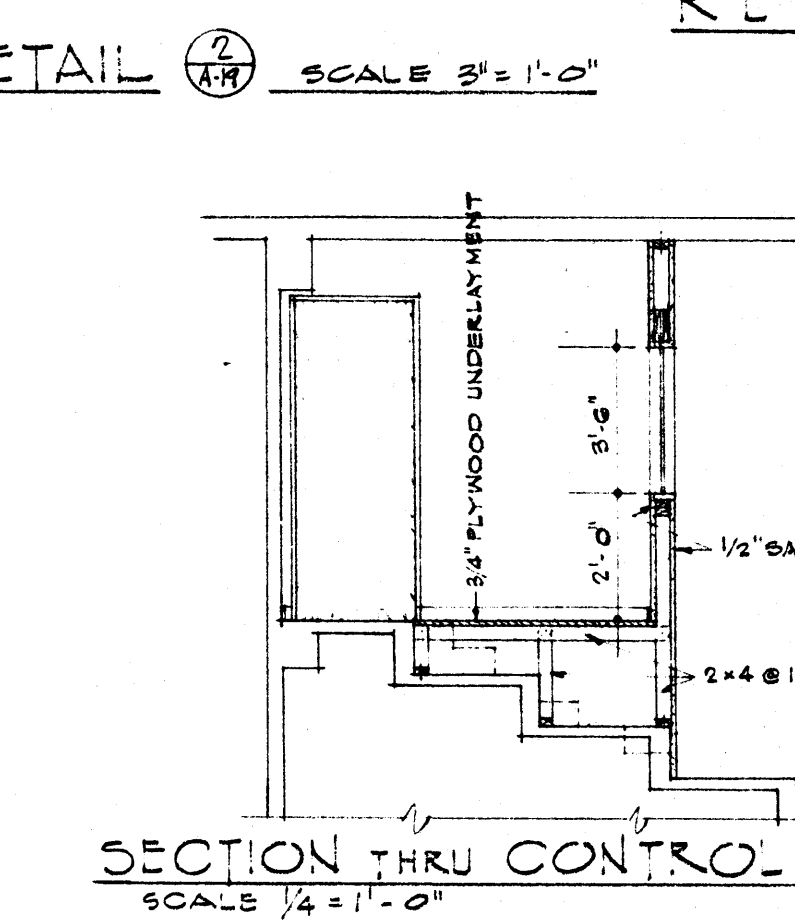


SECTION THRU CONTROL ROOM SCALE 1/4" = 1'-0"

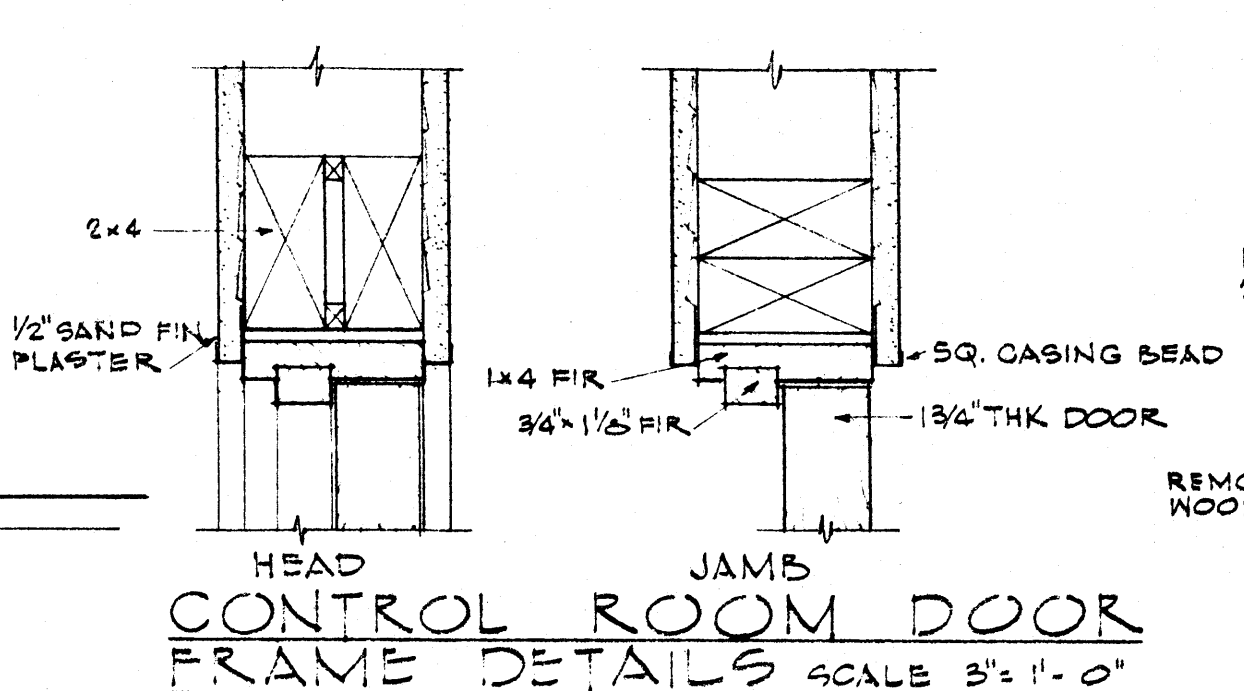


CONTROL ROOM DOOR FRAME DETAILS SCALE 3" = 1'-0"

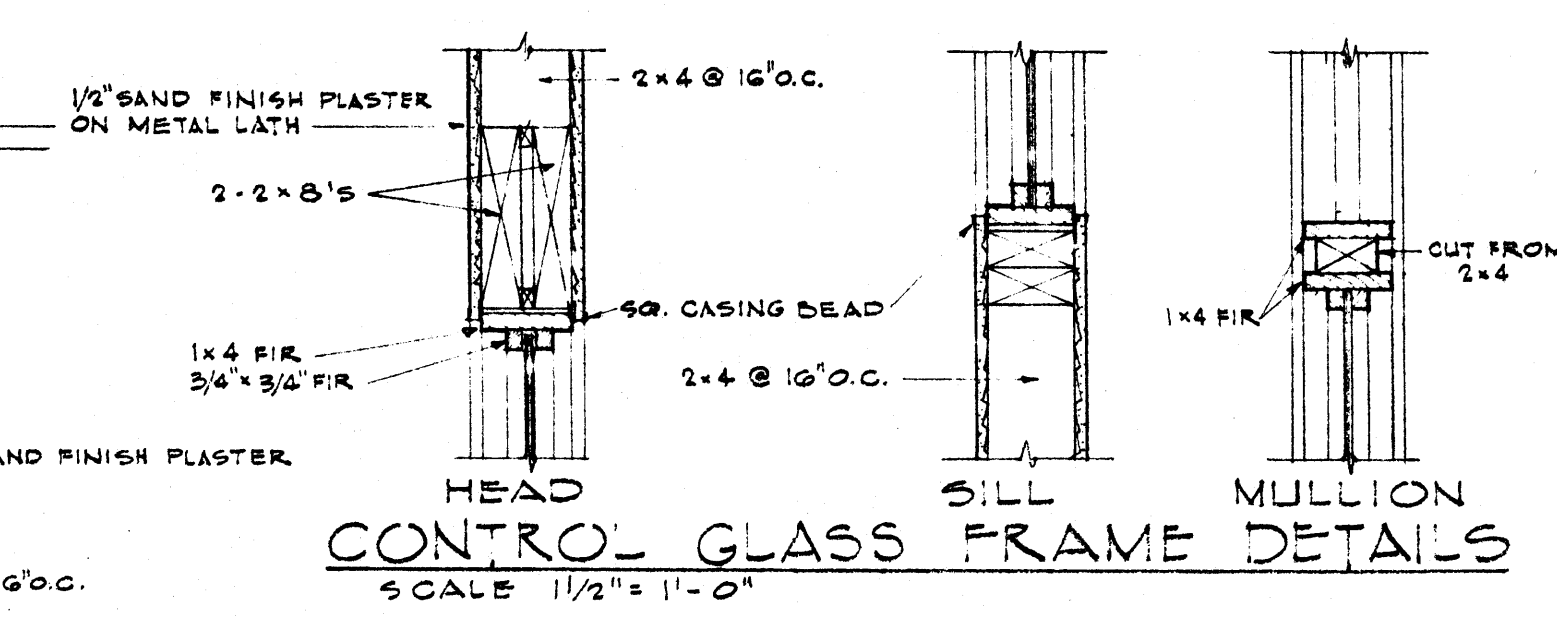

CONTROL GLASS FRAME DETAILS SCALE 1 1/2" = 1'-0"




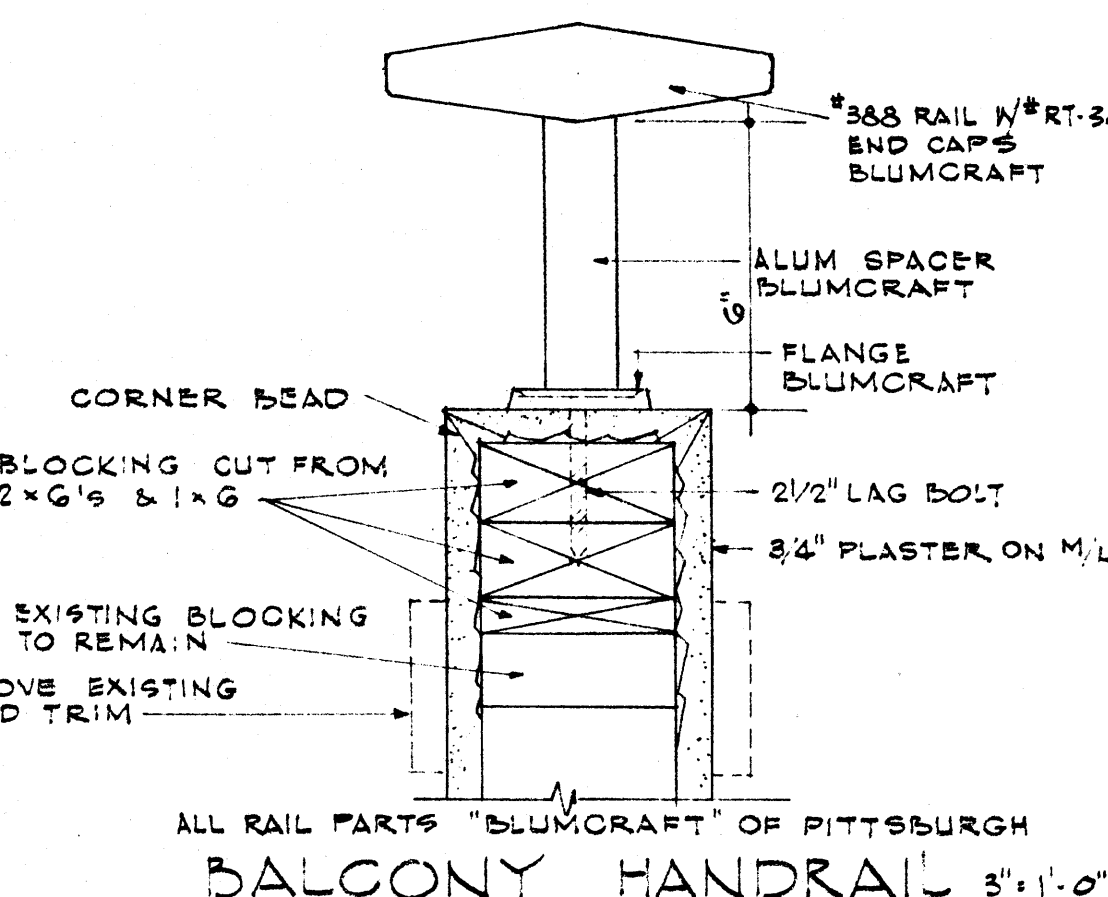


BALCONY HANDRAIL 3/8" = 1'-0"


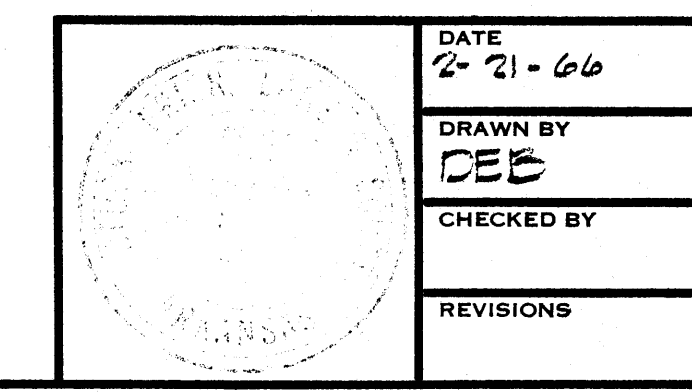


DATE 2-21-66
 DRAWN BY DEB
 CHECKED BY
 REVISIONS
 RENOVATIONS TO WILSON HALL STATE COLLEGE ARKANSAS
STUCK, FRIER, LANE & SCOTT, INC., ARCHITECTS
 601 SOUTHWEST DRIVE • JONESBORO, ARKANSAS

SHEET NUMBER **A-19**
 COMMISSION NUMBER 43260

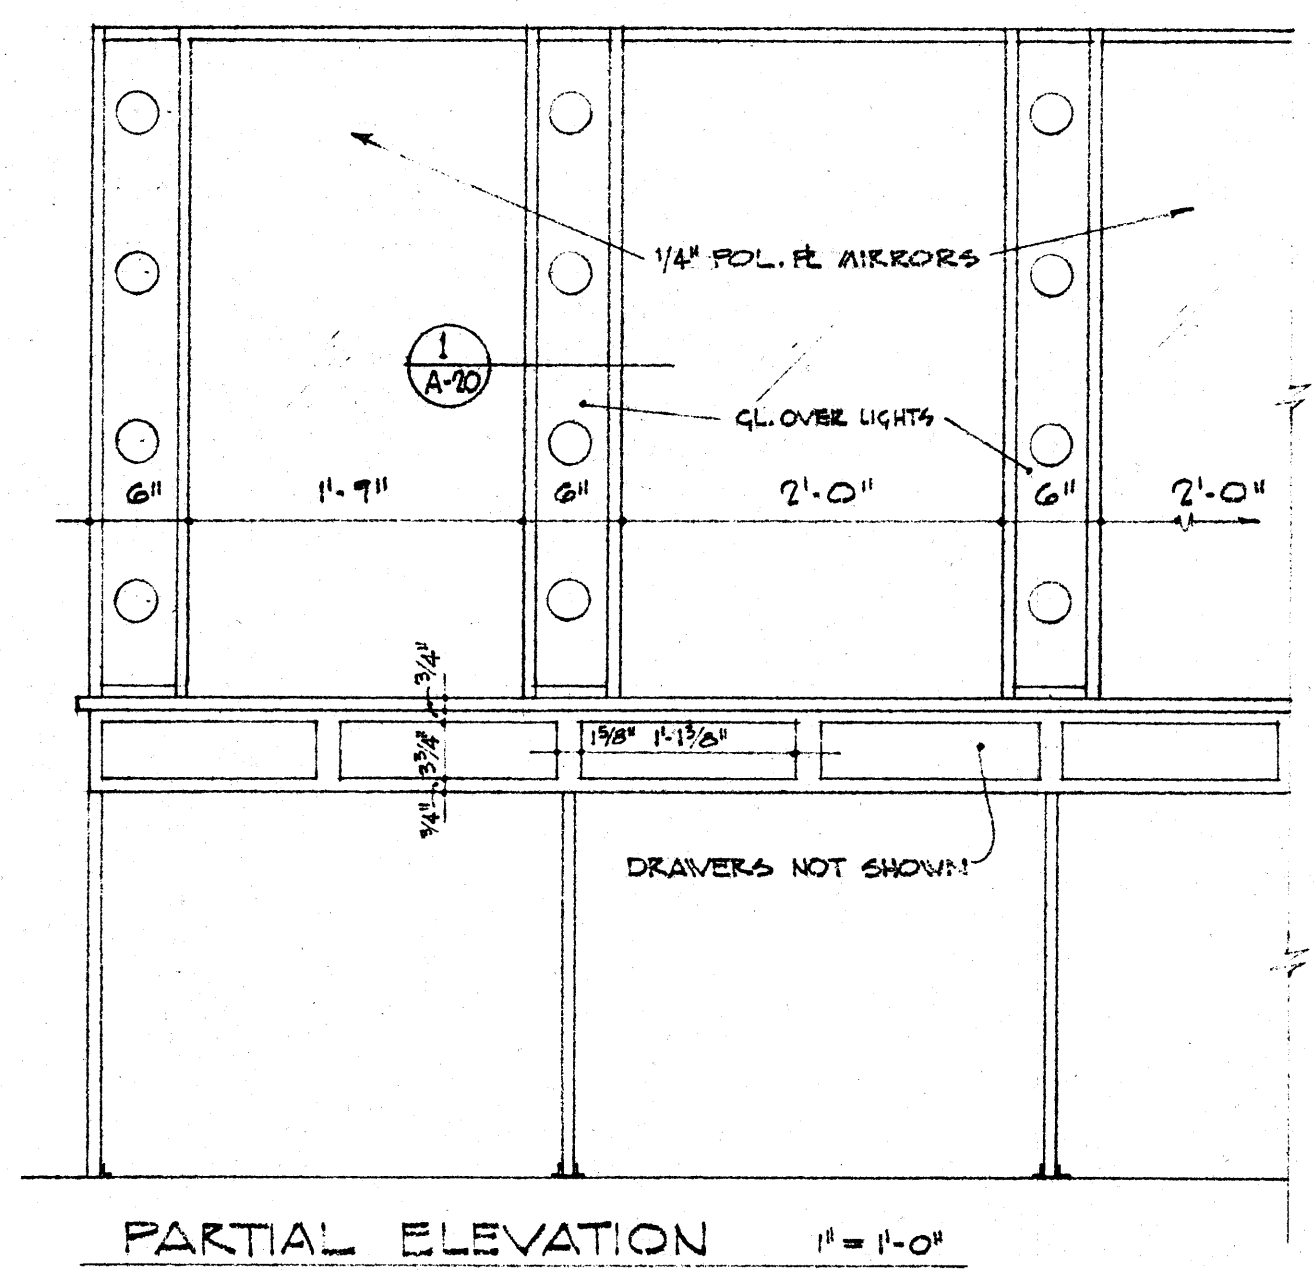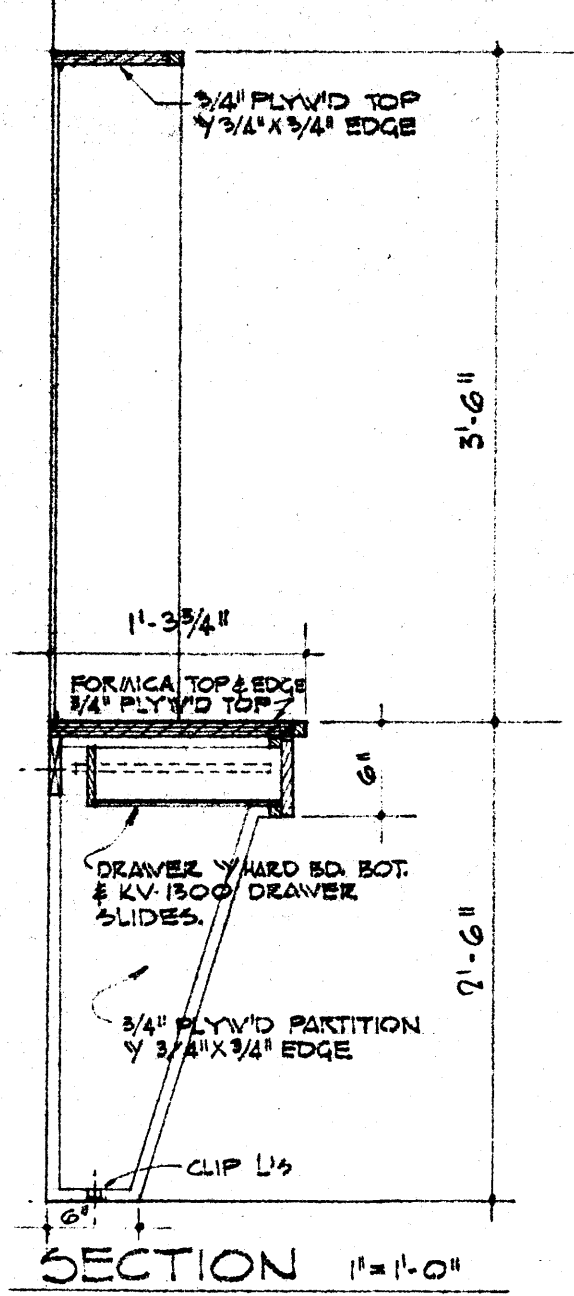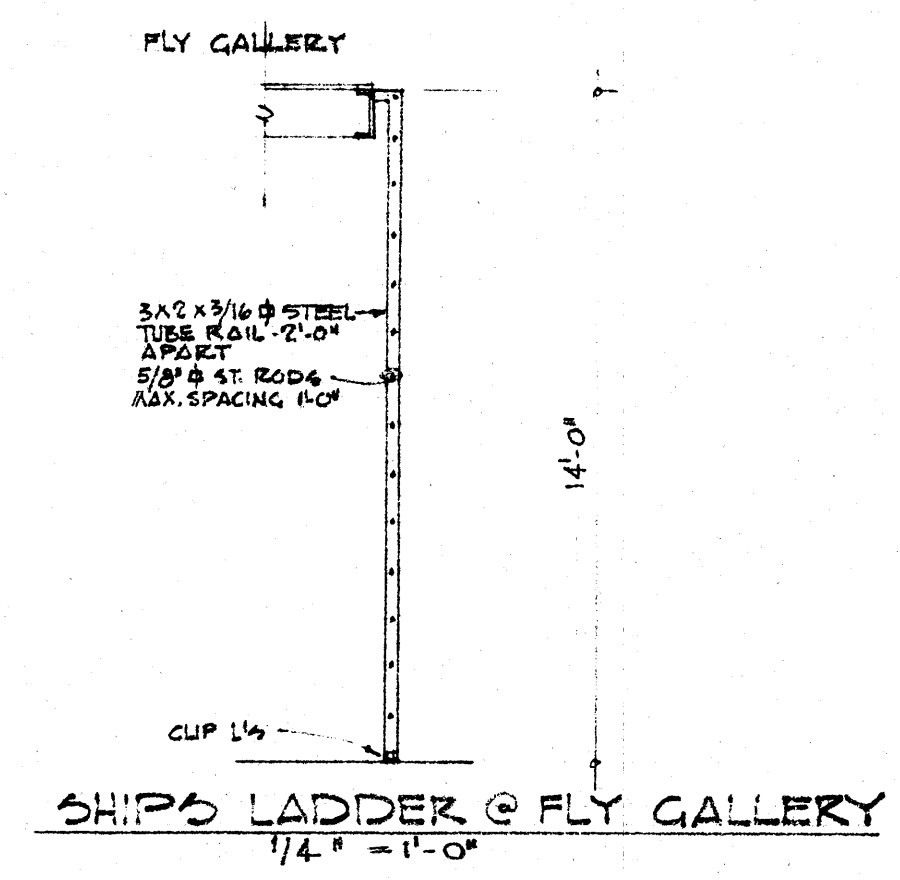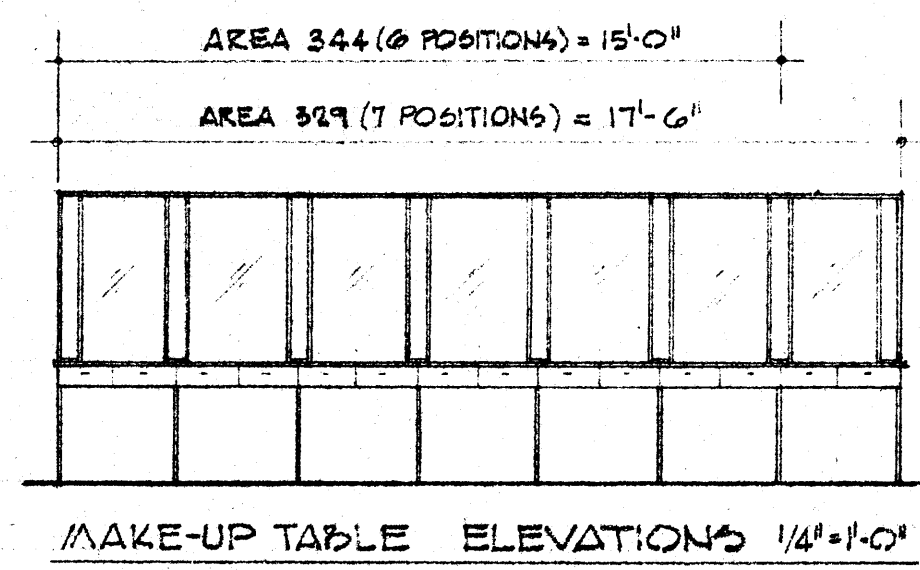


MAKE-UP TABLE DETAILS

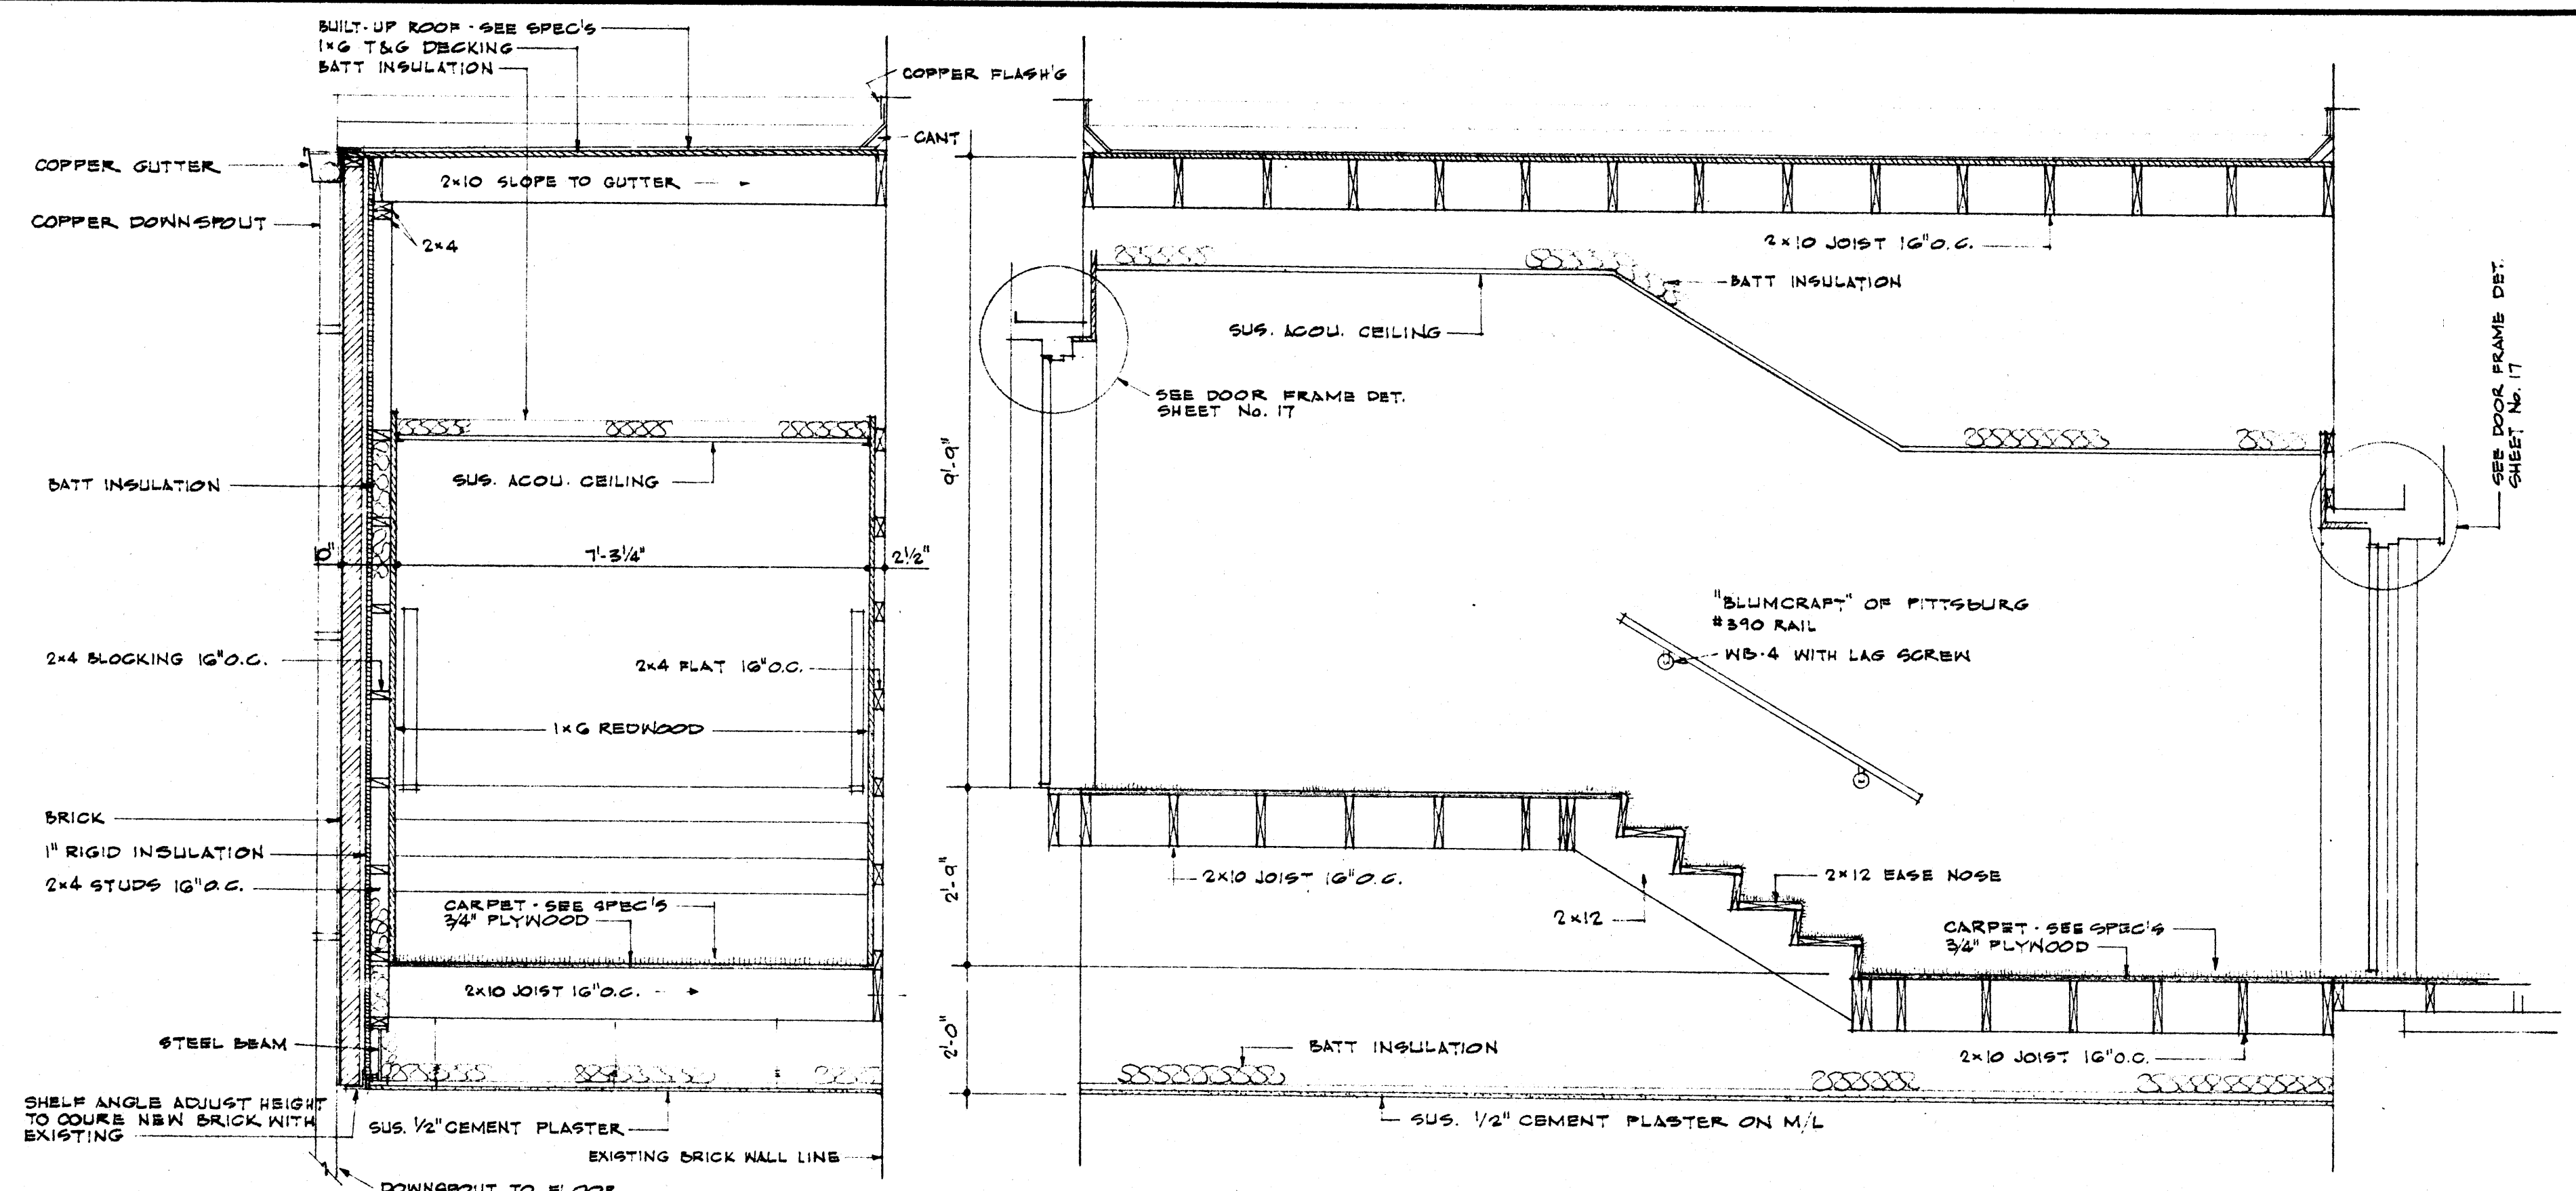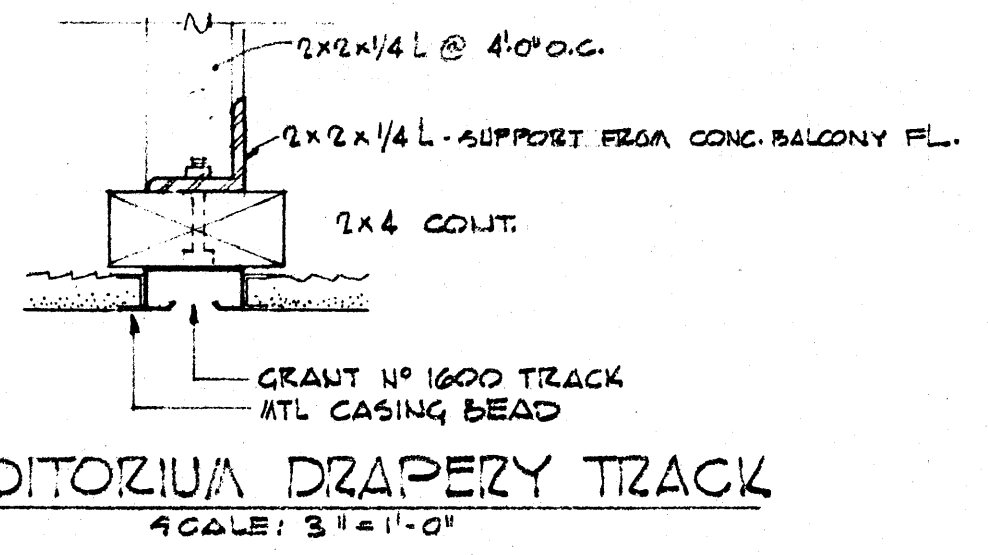


SECTION A-A SCALE 1/2" = 1'-0"


SECTION B-B SCALE 1/2" = 1'-0"

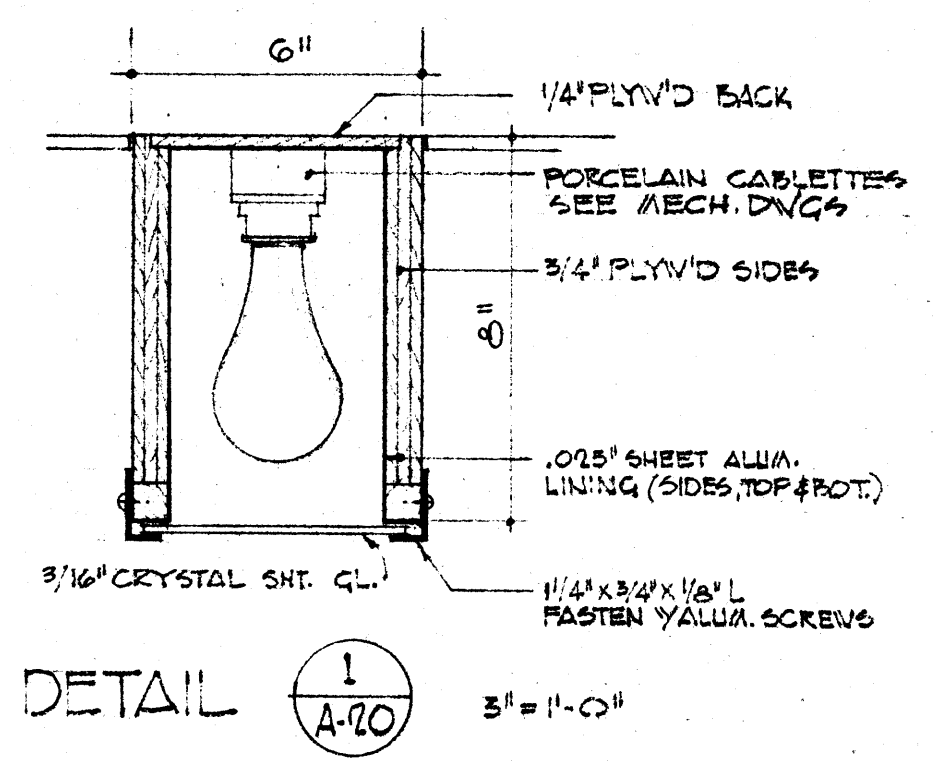

DETAIL 1 A-10 3" = 1'-0"

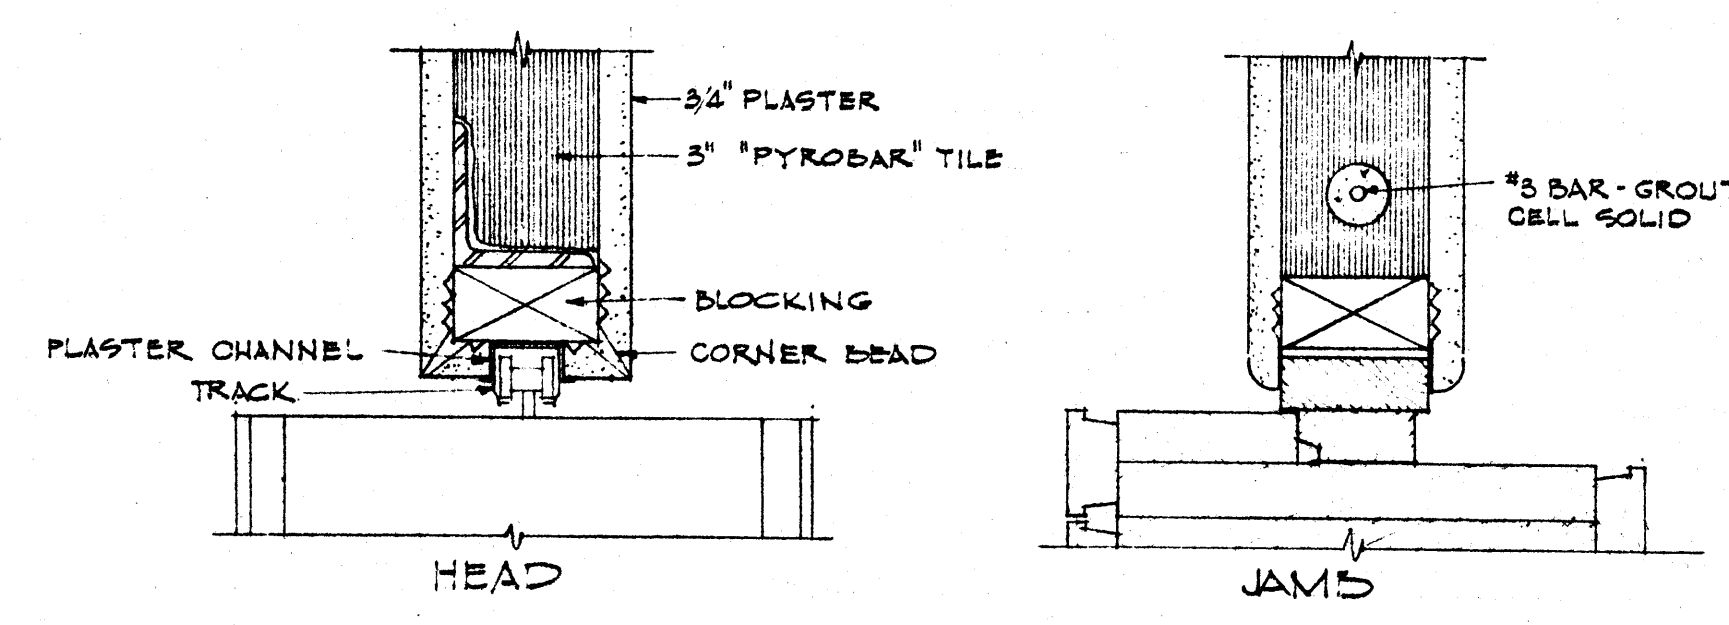


FOLDING DOOR DETAILS SCALE 3" = 1'-0"

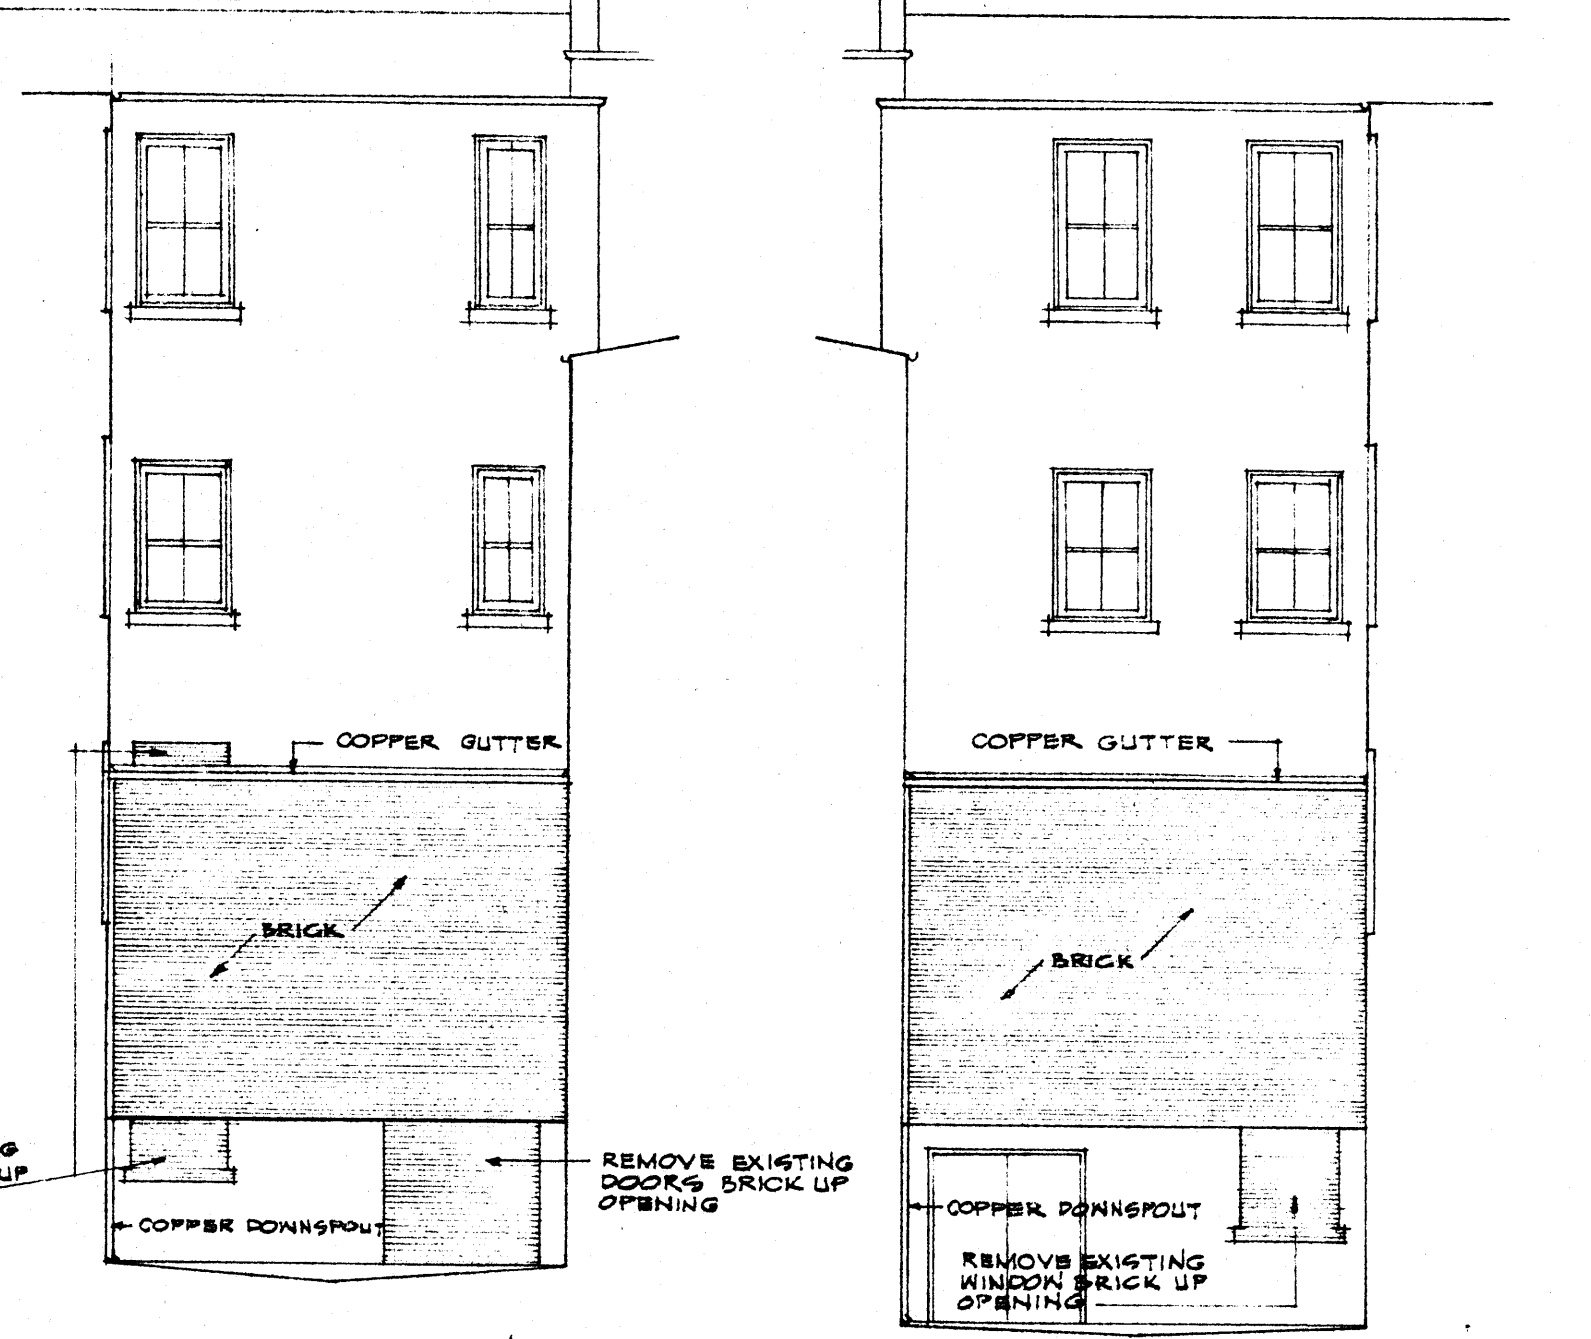


SOUTH ELEVATION EAST LIGHTWELL 1/8" = 1'-0"


SOUTH ELEVATION WEST LIGHTWELL 1/8" = 1'-0"

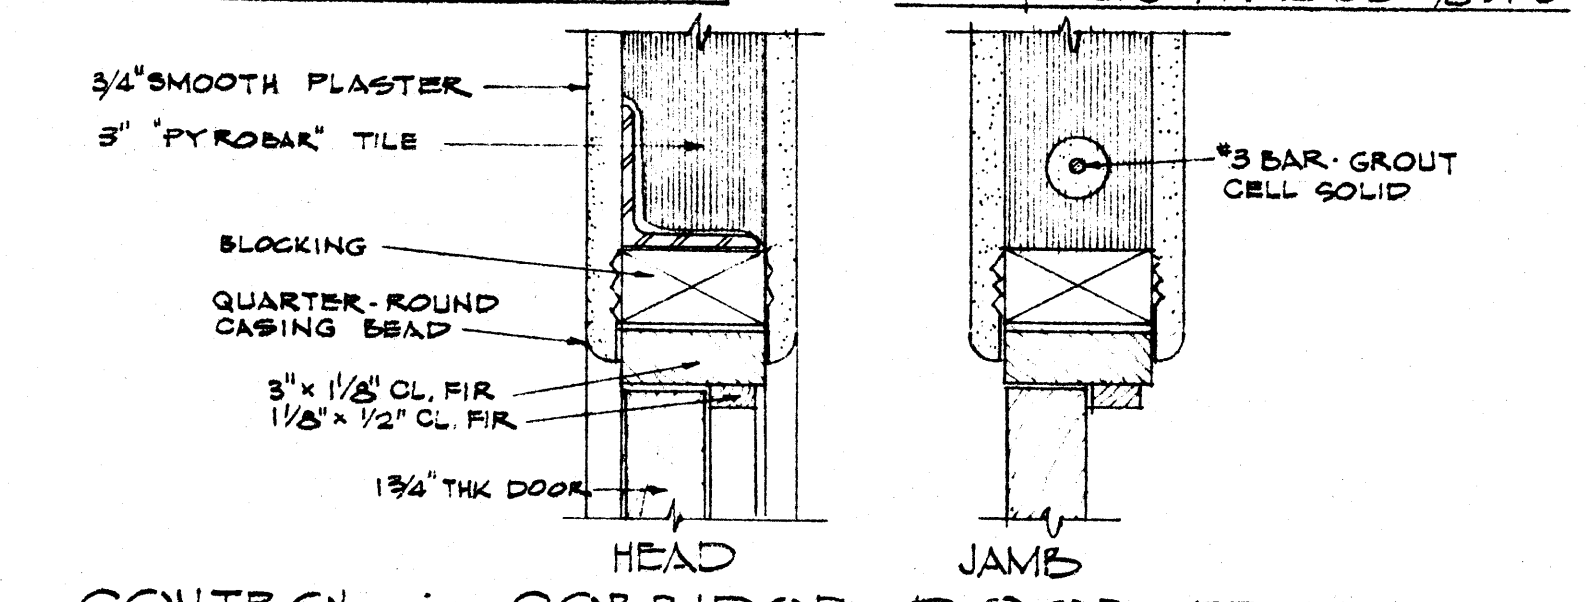


CONTROL TO CORRIDOR DOOR FRAME SCALE 3" = 1'-0"

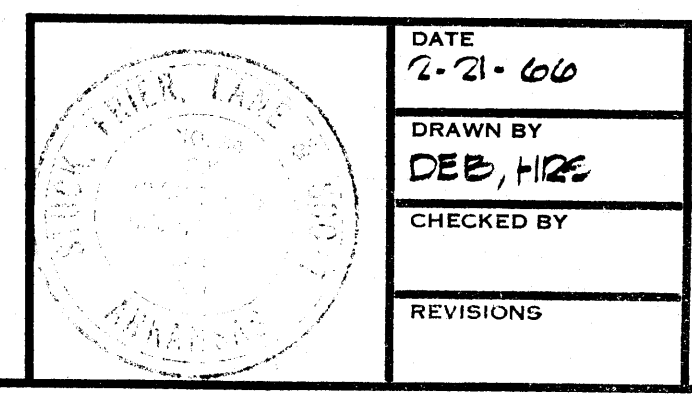


DATE 2-21-66	REVISIONS	RENOVIATIONS TO WILSON HALL ARKANSAS STATE COLLEGE JONESBORO, ARKANSAS	SHEET NUMBER A-20
DRAWN BY DEB, HZE	CHECKED BY		

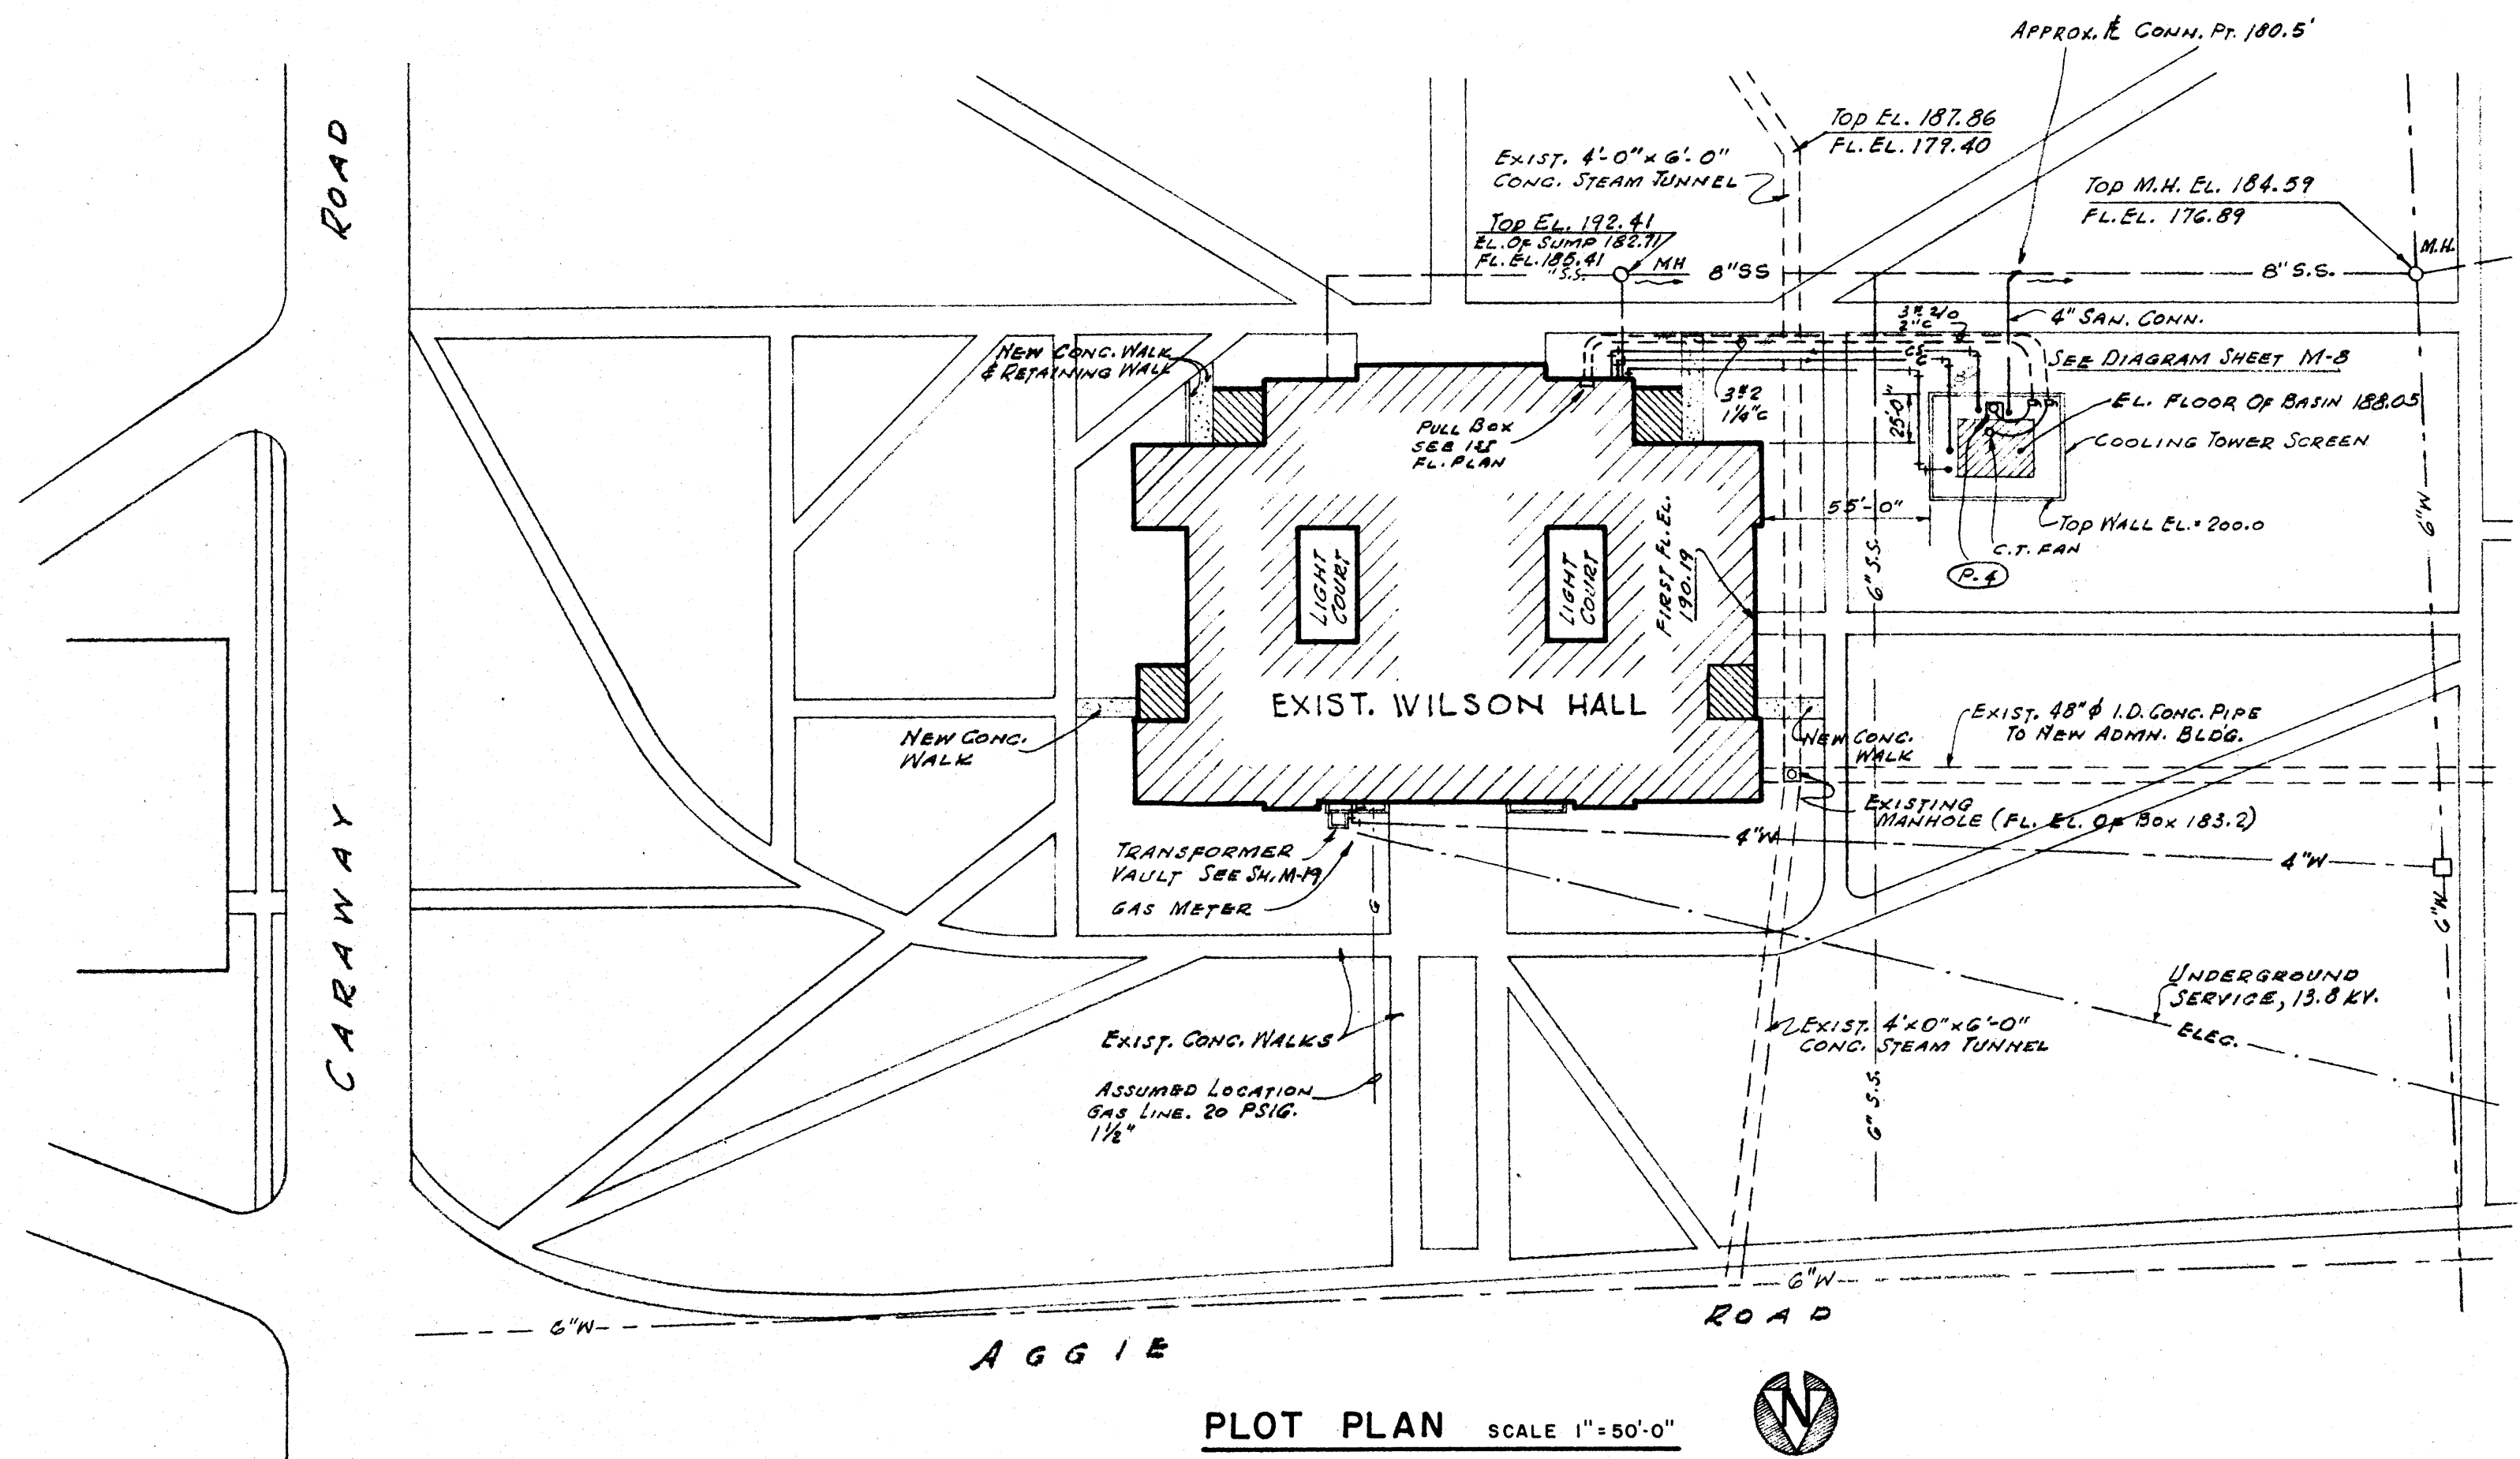

PLOT PLAN SCALE 1"=50'-0"

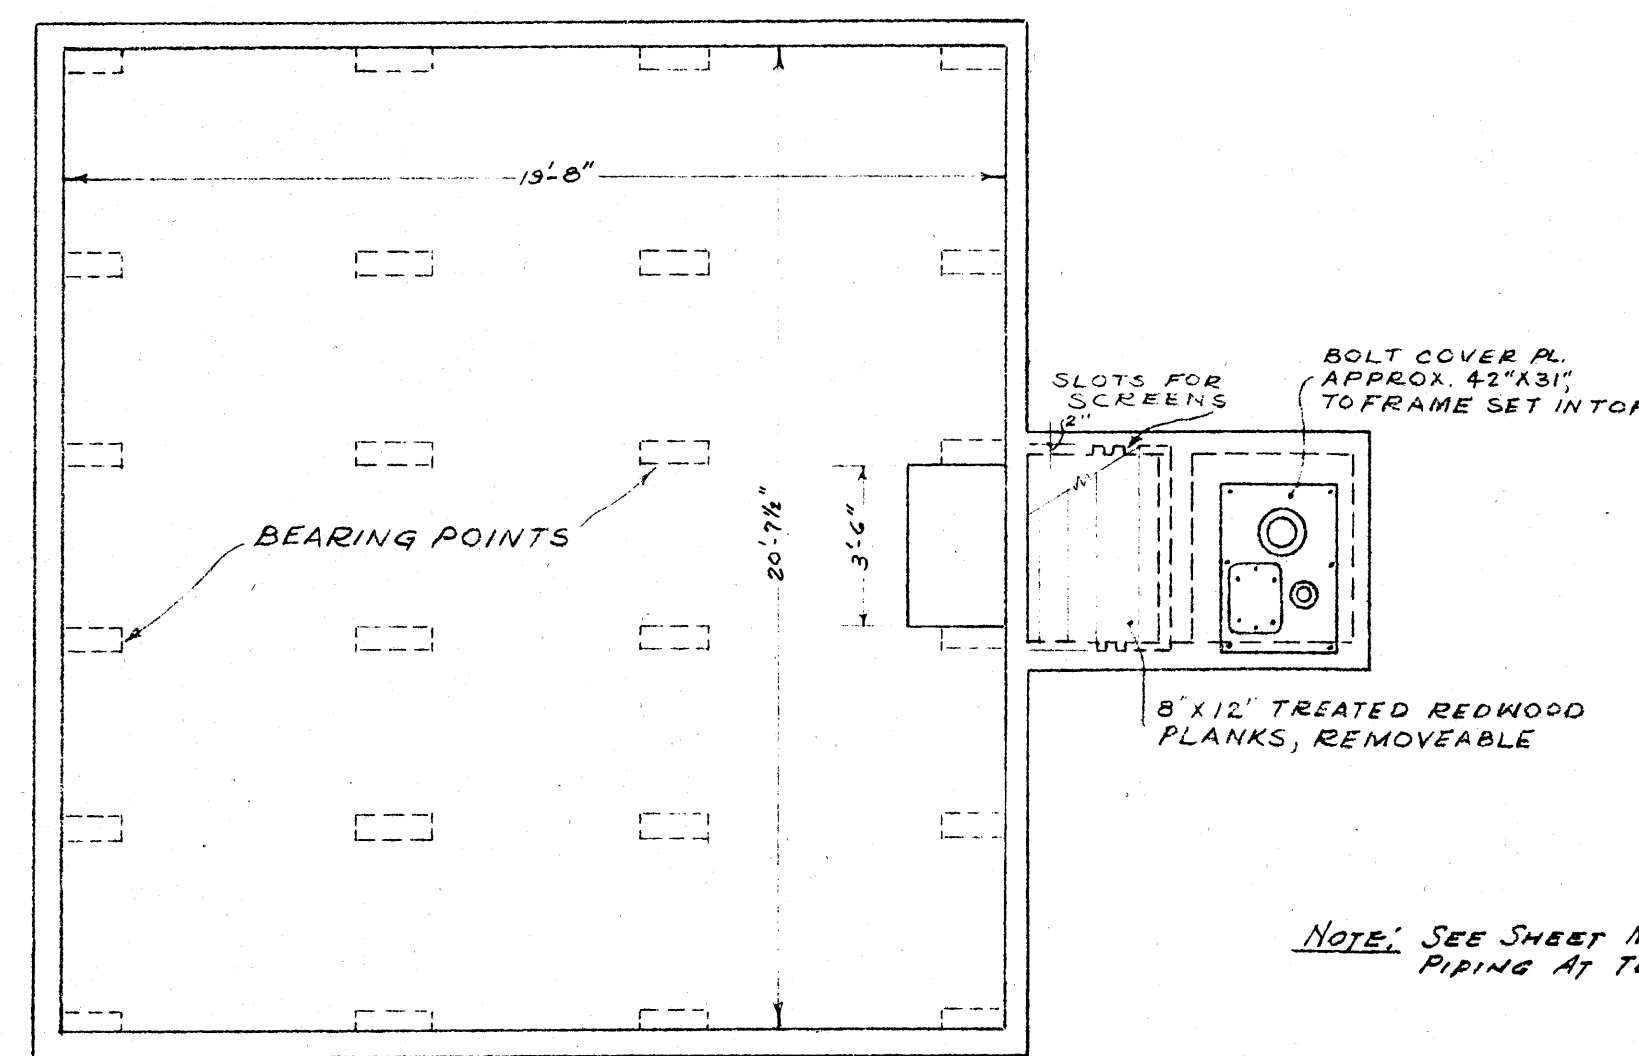

COOLING TOWER BASIN-PLAN SCALE 1/4"=1'-0"

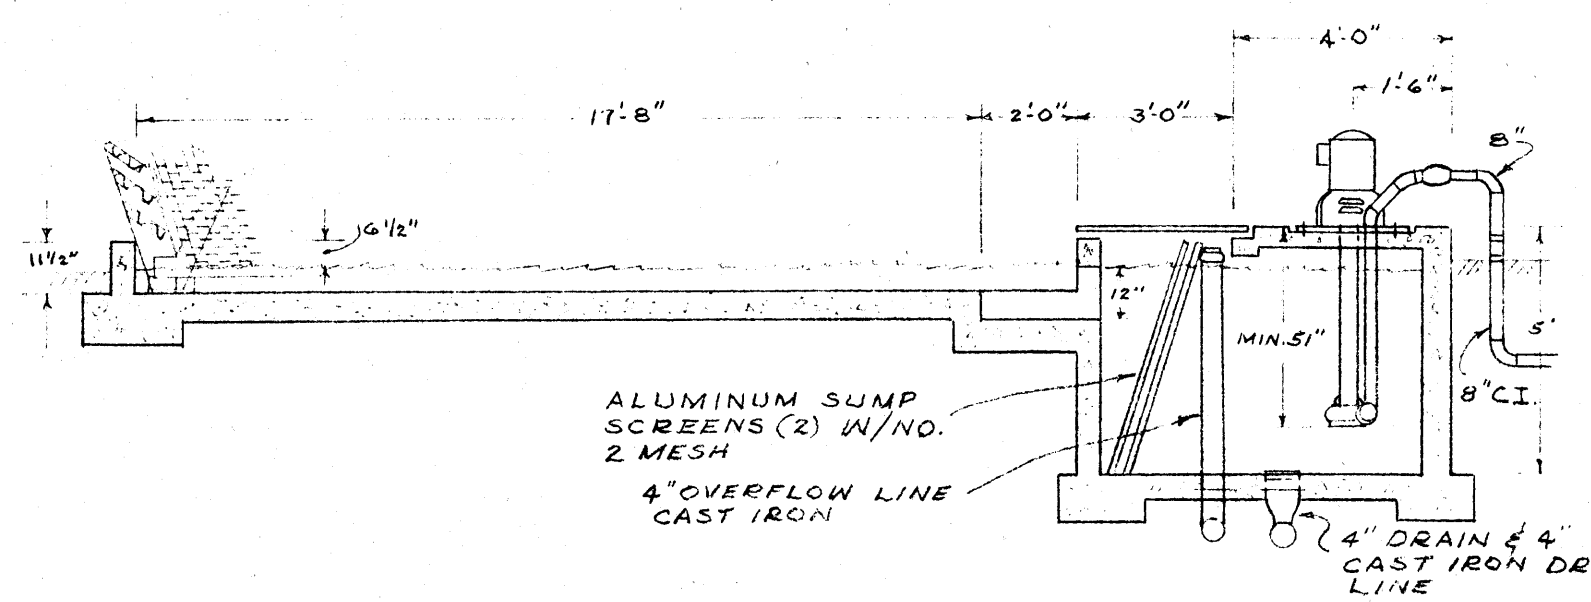

COOLING TOWER BASIN-SECTION SCALE 1/4"=1'-0"


GENERAL & DEMOLITION NOTES (MECHANICAL & ELECTRICAL)

1. REMOVE SIX PRESENT PACKAGED AIR CONDITIONING SYSTEMS, (NOT INCLUDING WINDOW A/C UNITS) AND AUDITORIUM UNIT VENTILATORS UNDER SUPERVISION OF A.S.C. PHYSICAL PLANT PERSONNEL. STORE A/C UNITS, GRILLES, STARTERS, DISCONNECTS AND ANY OTHER "REUSABLE" MATERIAL OR EQUIPMENT IN HANGER BUILDING, ON CAMPUS.
2. REMOVE ALL PRESENT ELECTRICAL LIGHTING FIXTURES, TRANSFORMERS, SWITCHES, OUTLETS, ETC. UNDER SUPERVISION OF A.S.C. PHYSICAL PLANT PERSONNEL. STORE ALL LIGHTING FIXTURES, TRANSFORMERS AND "REUSABLE" ITEMS IN HANGER BUILDING, ON CAMPUS.
3. REMOVE PLUMBING FIXTURES WHERE INDICATED, AND ALL ASSOCIATED PIPING, UNDER SUPERVISION OF A.S.C. PHYSICAL PLANT PERSONNEL. STORE FIXTURES AND BRASS IN HANGER BUILDING, ON CAMPUS.
4. REMOVE PIPING FOR EXISTING SYSTEMS, WHERE SAME INTERFERES WITH NEW WORK, AND RELOCATE TO NEW POSITION AS REQUIRED.
5. REMOVE ALL STEAM TRAPS AND STEAM DRIP STATIONS. REPIPE FOR HOT WATER HEATING AS REQUIRED. ORIGINAL BUILDING PLANS (1931) MAY BE REVIEWED IN ARCHITECT'S OR ENGINEER'S OFFICE. JOB CONDITIONS MUST BE OBSERVED BY BIDDERS.
6. ALL EQUIPMENT AND MATERIALS NOT DEEMED "REUSABLE" BY A.S.C. PHYSICAL PLANT PERSONNEL SHALL BE REMOVED FROM PREMISES BY CONTRACTOR.

INDEX TO MECHANICAL - ELECTRICAL DRAWINGS

SHEET	TITLE
M-1	PLOT PLAN
M-2	PLUMBING
M-3	HVAC & PLUMBING—FIRST FLOOR
M-4	HVAC & PLUMBING—SECOND FLOOR
M-5	HVAC & PLUMBING—THIRD FLOOR
M-6	HVAC & PLUMBING—FOURTH FLOOR
M-7	HVAC & PLUMBING—EQUIPMENT ROOMS
M-8	HVAC—SCHEDULES & DETAILS
M-9	HVAC & ELECTRICAL—CONTROL DIAGRAMS
M-10	HVAC & ELECTRICAL—AUDITORIUM ALTERNATE
M-11	ELECTRICAL LIGHTING—FIRST FLOOR
M-12	ELECTRICAL LIGHTING—SECOND FLOOR
M-13	ELECTRICAL LIGHTING—THIRD FLOOR
M-14	ELECTRICAL LIGHTING—FOURTH FLOOR
M-15	ELECTRICAL POWER—FIRST FLOOR
M-16	ELECTRICAL POWER—SECOND FLOOR
M-17	ELECTRICAL POWER—THIRD FLOOR
M-18	ELECTRICAL POWER—FOURTH FLOOR
M-19	ELECTRICAL DIAGRAMS
M-20	ELECTRICAL SCHEDULES



Office of GRIFFITH C. BURR
CONSULTING ENGINEERS
MEMPHIS, TENNESSEE

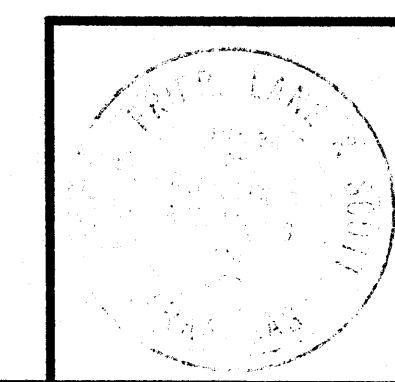

DATE
2-21-66
DRAWN BY
RL, BL
CHECKED BY
REVISIONS

RENOVATIONS TO
WILSON HALL
ARKANSAS STATE COLLEGE
JONESBORO, ARKANSAS
STUCK, FRIER, LANE & SCOTT, INC., ARCHITECTS
601 SOUTHWEST DRIVE • JONESBORO, ARKANSAS

SHEET NUMBER
M-1
COMMISSION NUMBER
43500

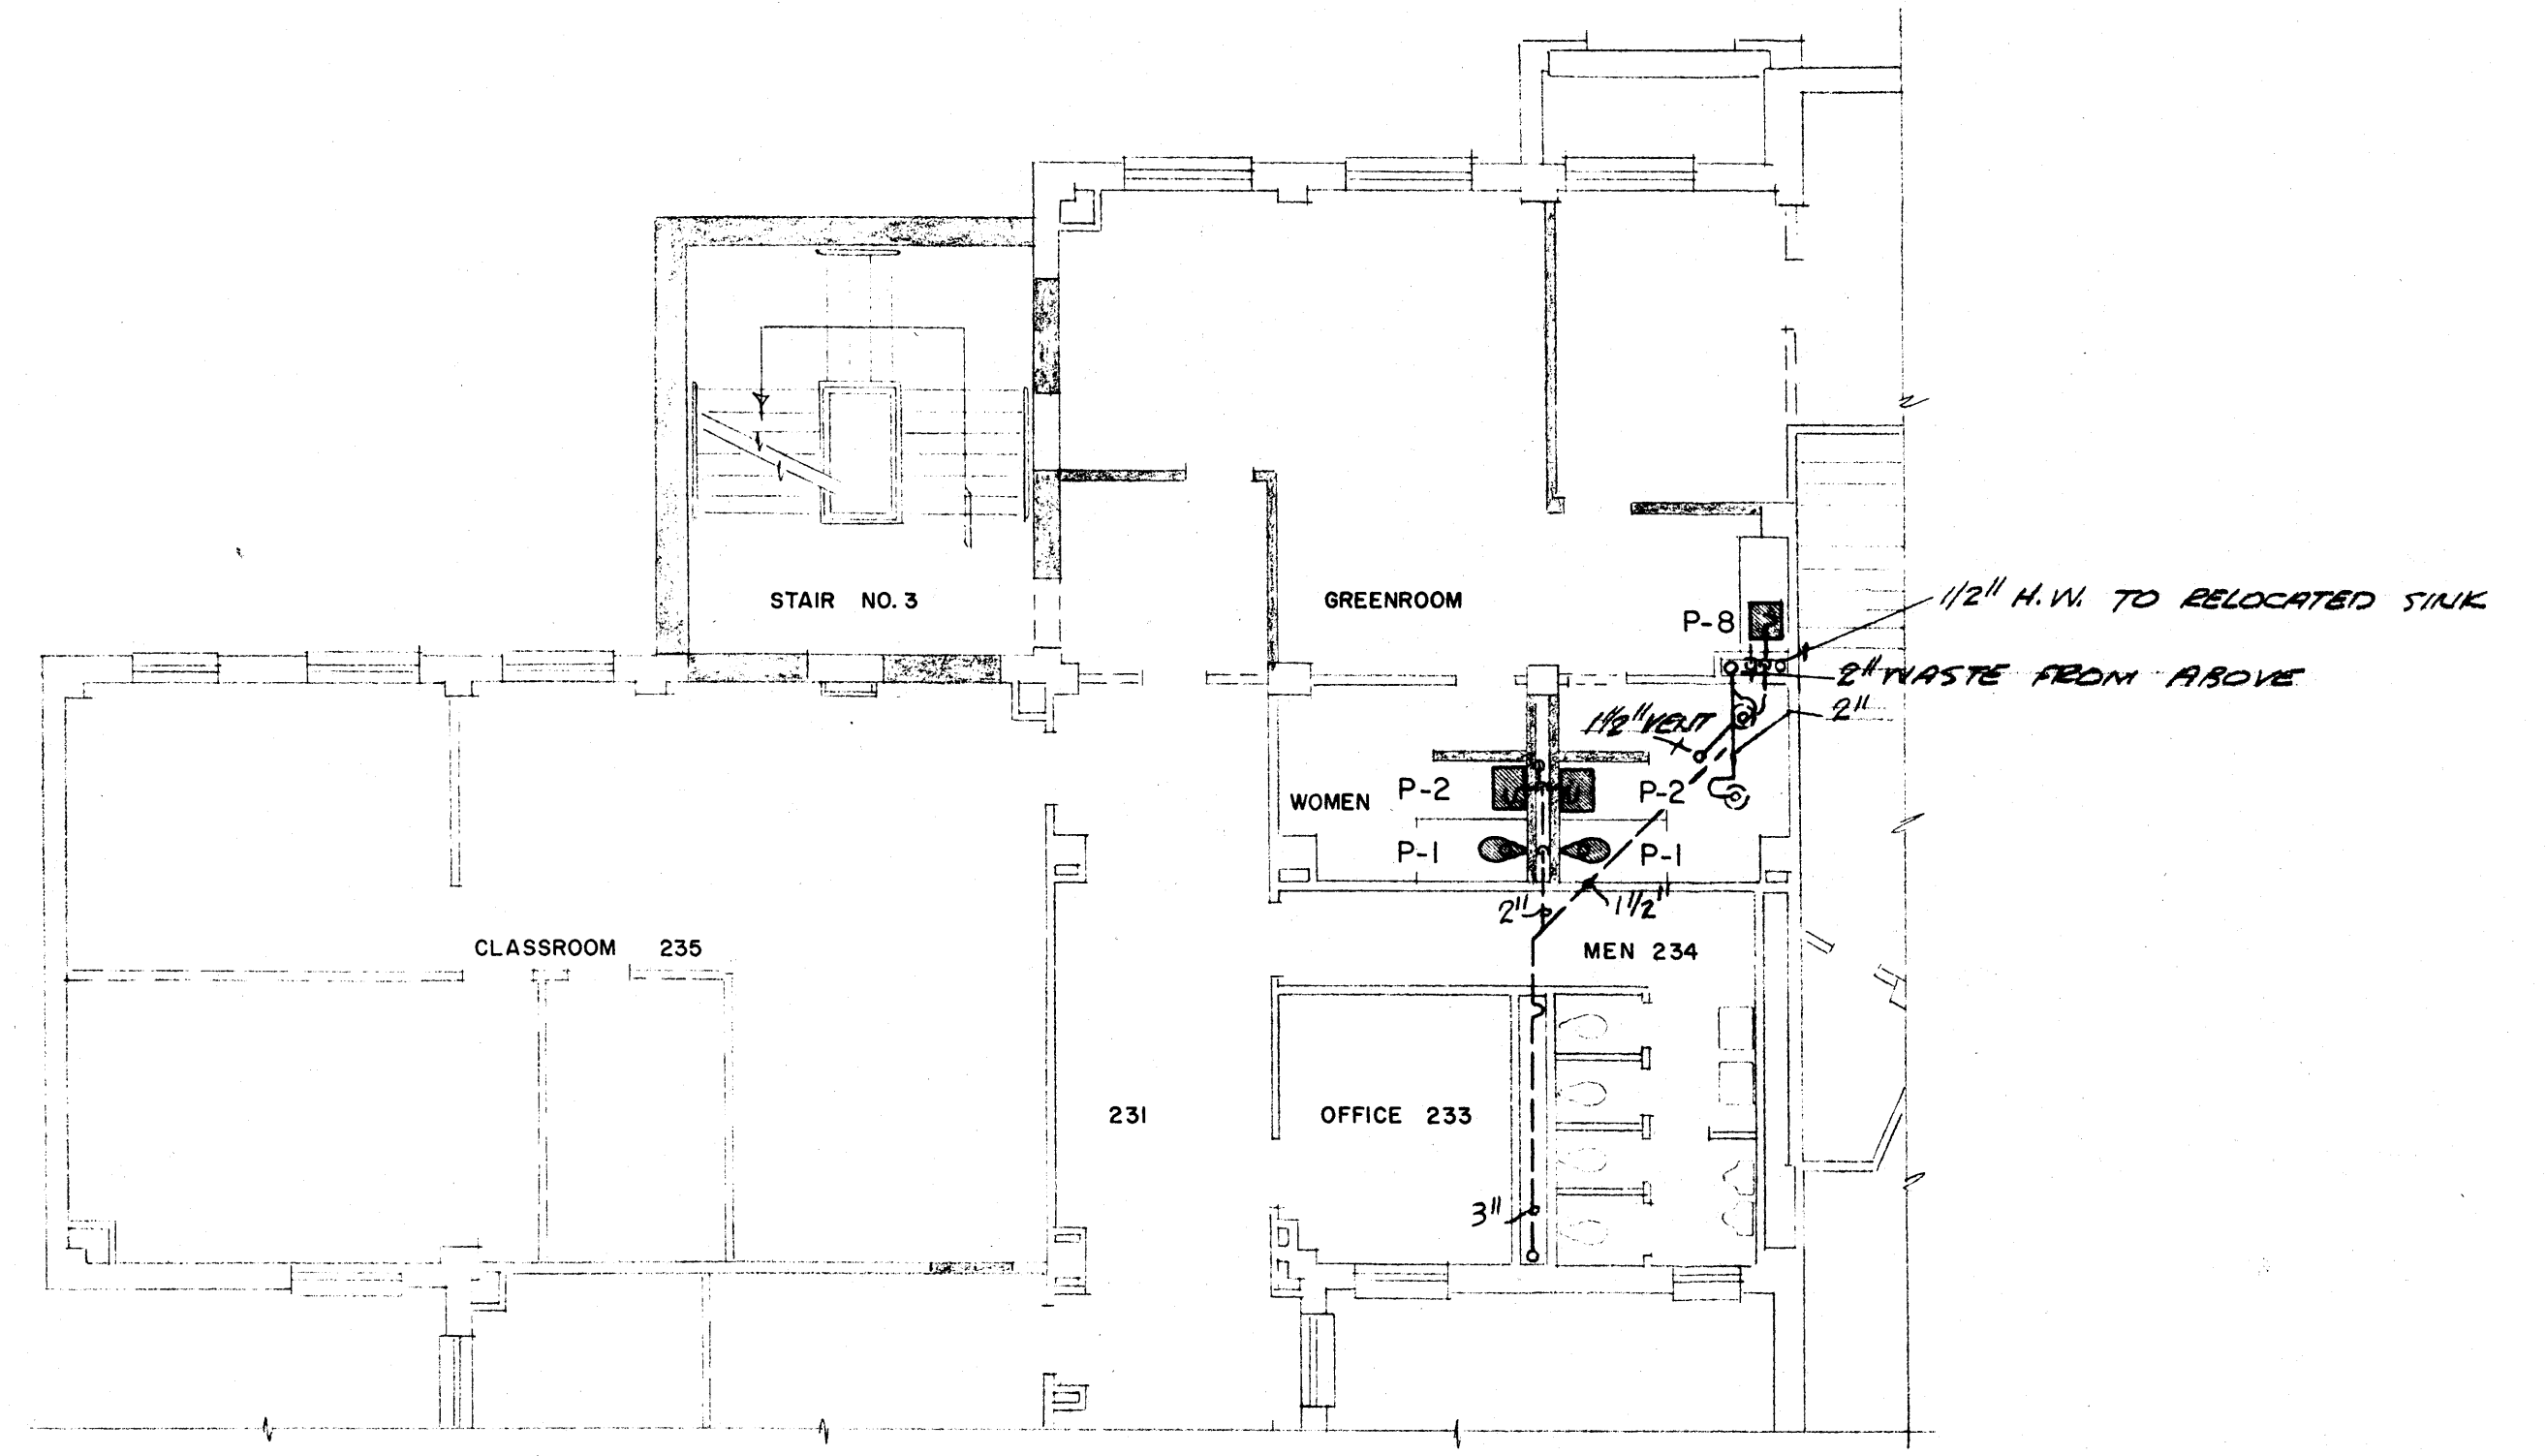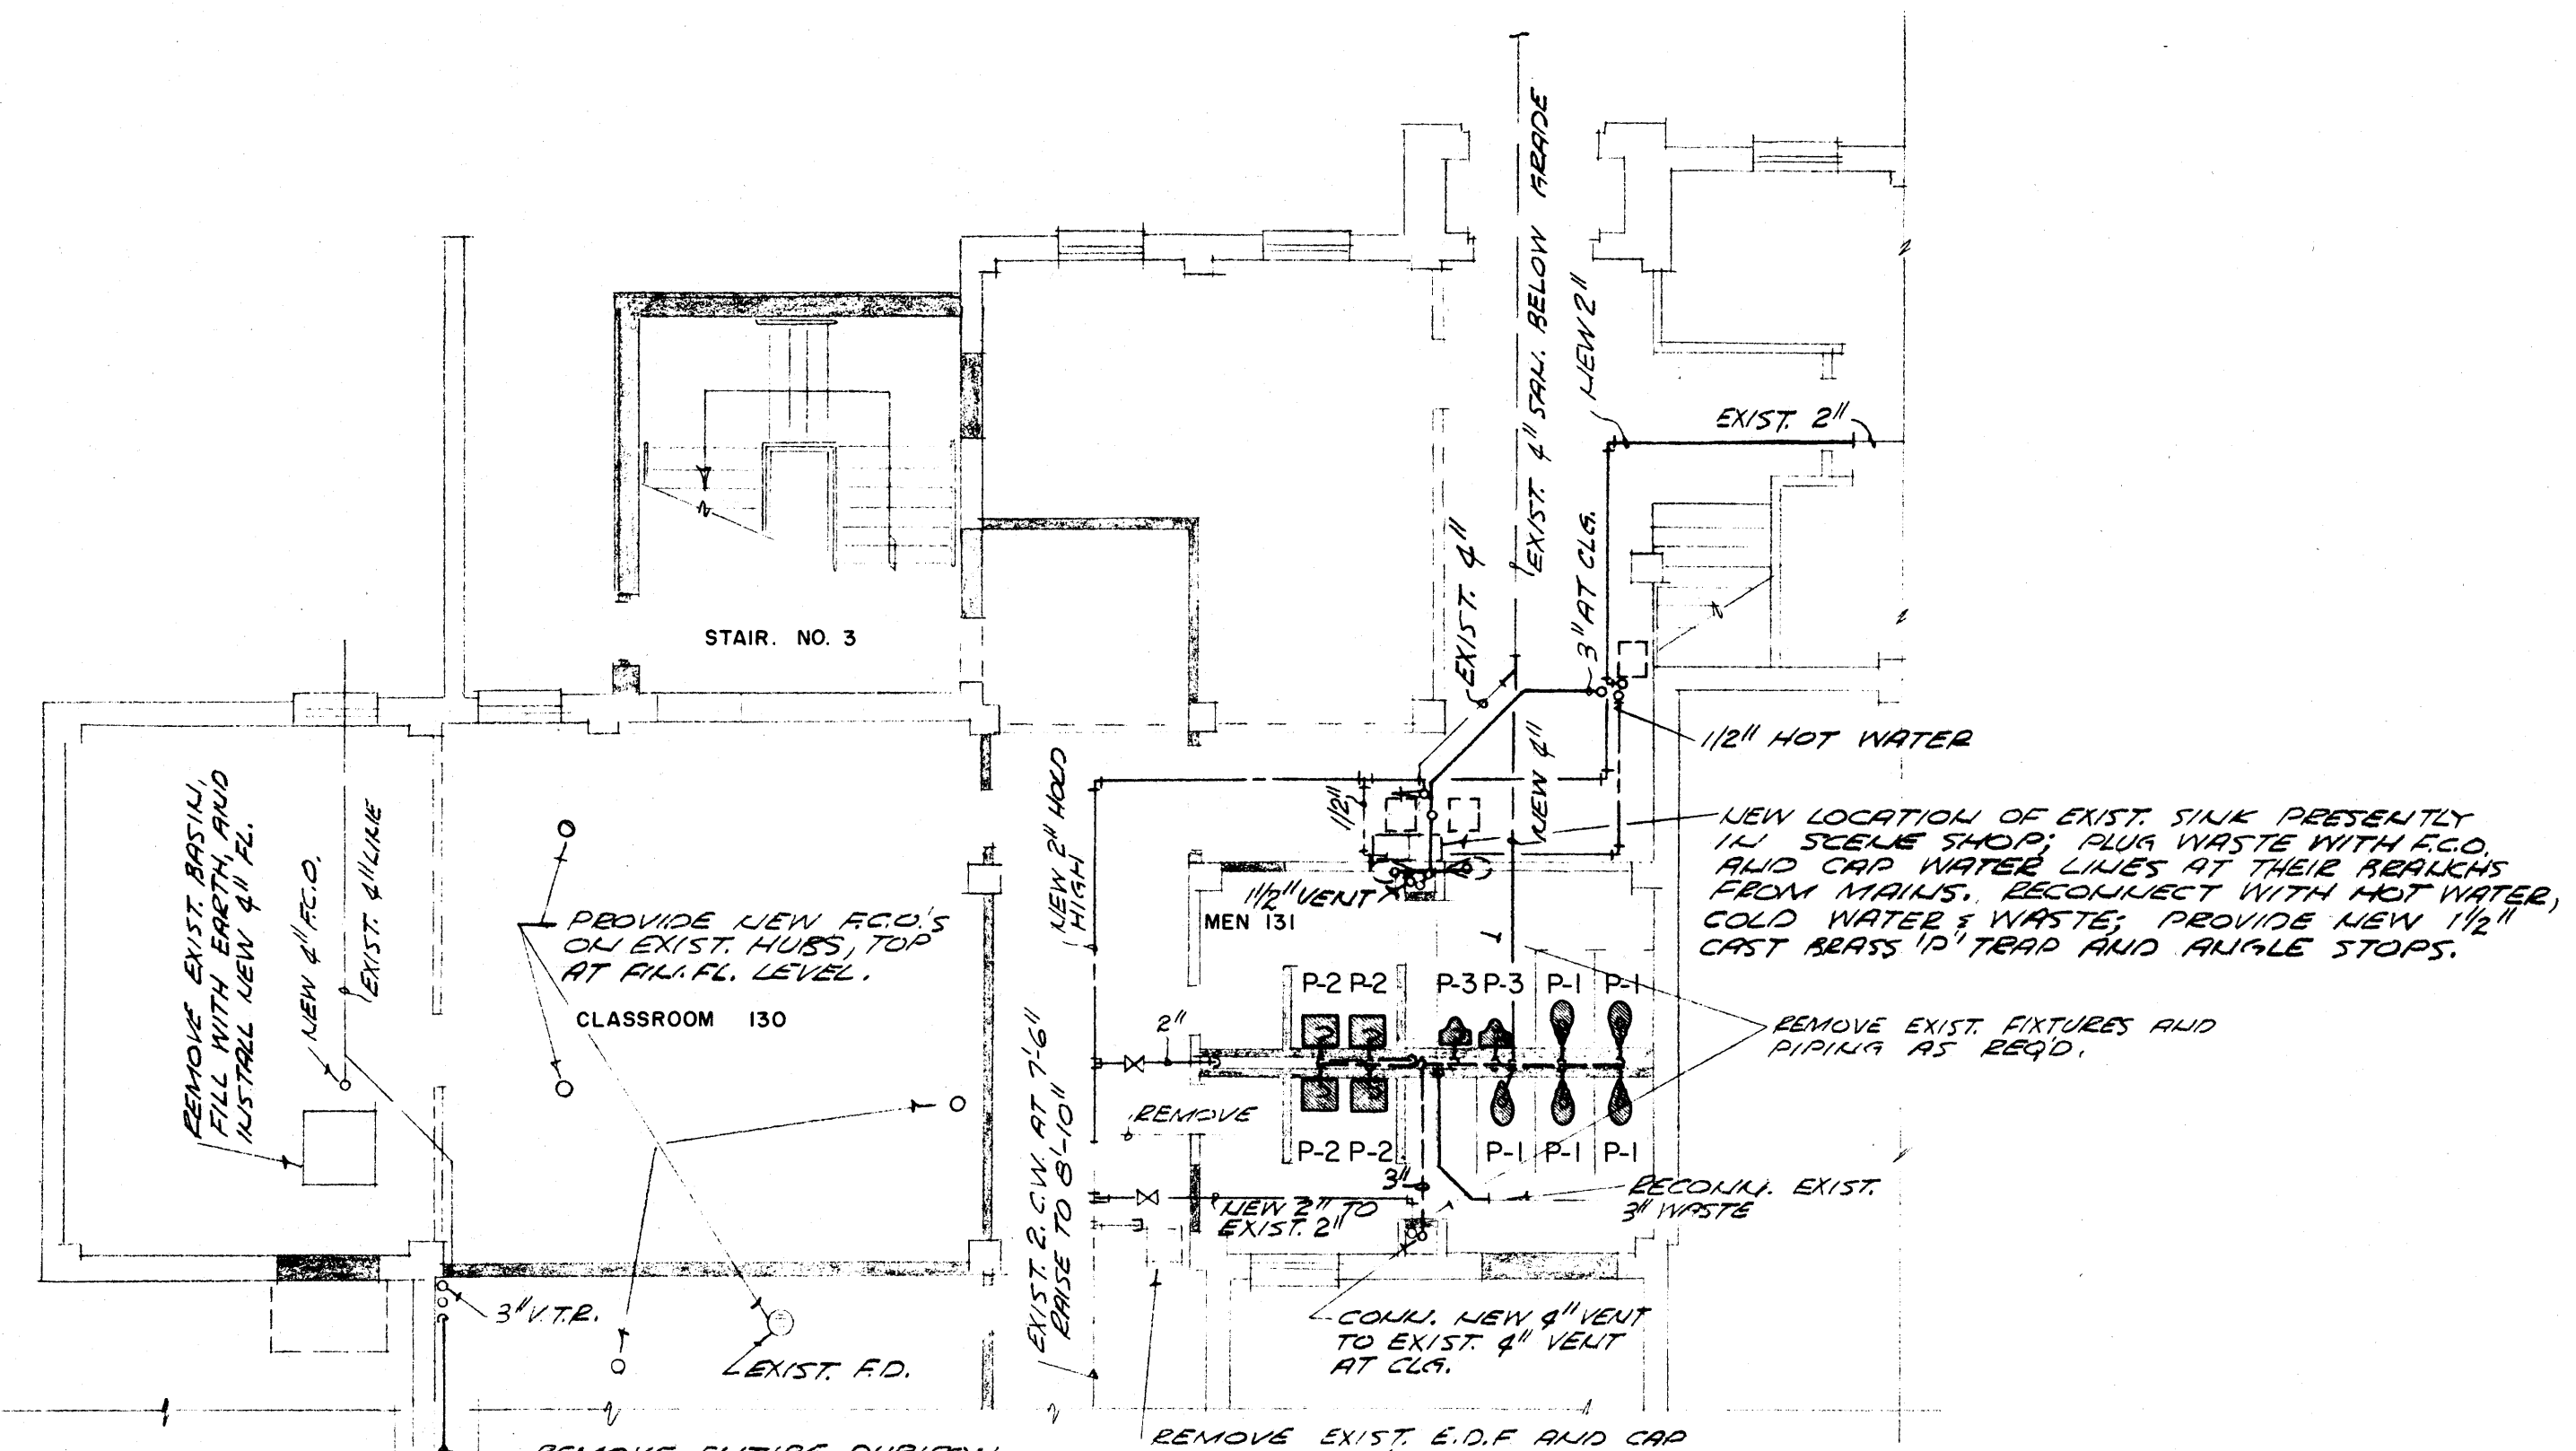


NOTE
REMOVE ALL ACCESSIBLE ACID WASTE
WATER & GAS LINES AT FIRST FL. CL.
THAT ARE NOT IN USE.


REINSULATE ALL DOMESTIC WATER
PIPE THAT IS TO BE REROUTED
OR REINSTALLED.

PART PLAN FIRST FLOOR - PLUMBING
SCALE 1/8"=1'-0"

PART PLAN SECOND FLOOR - PLUMBING
SCALE 1/8"=1'-0"

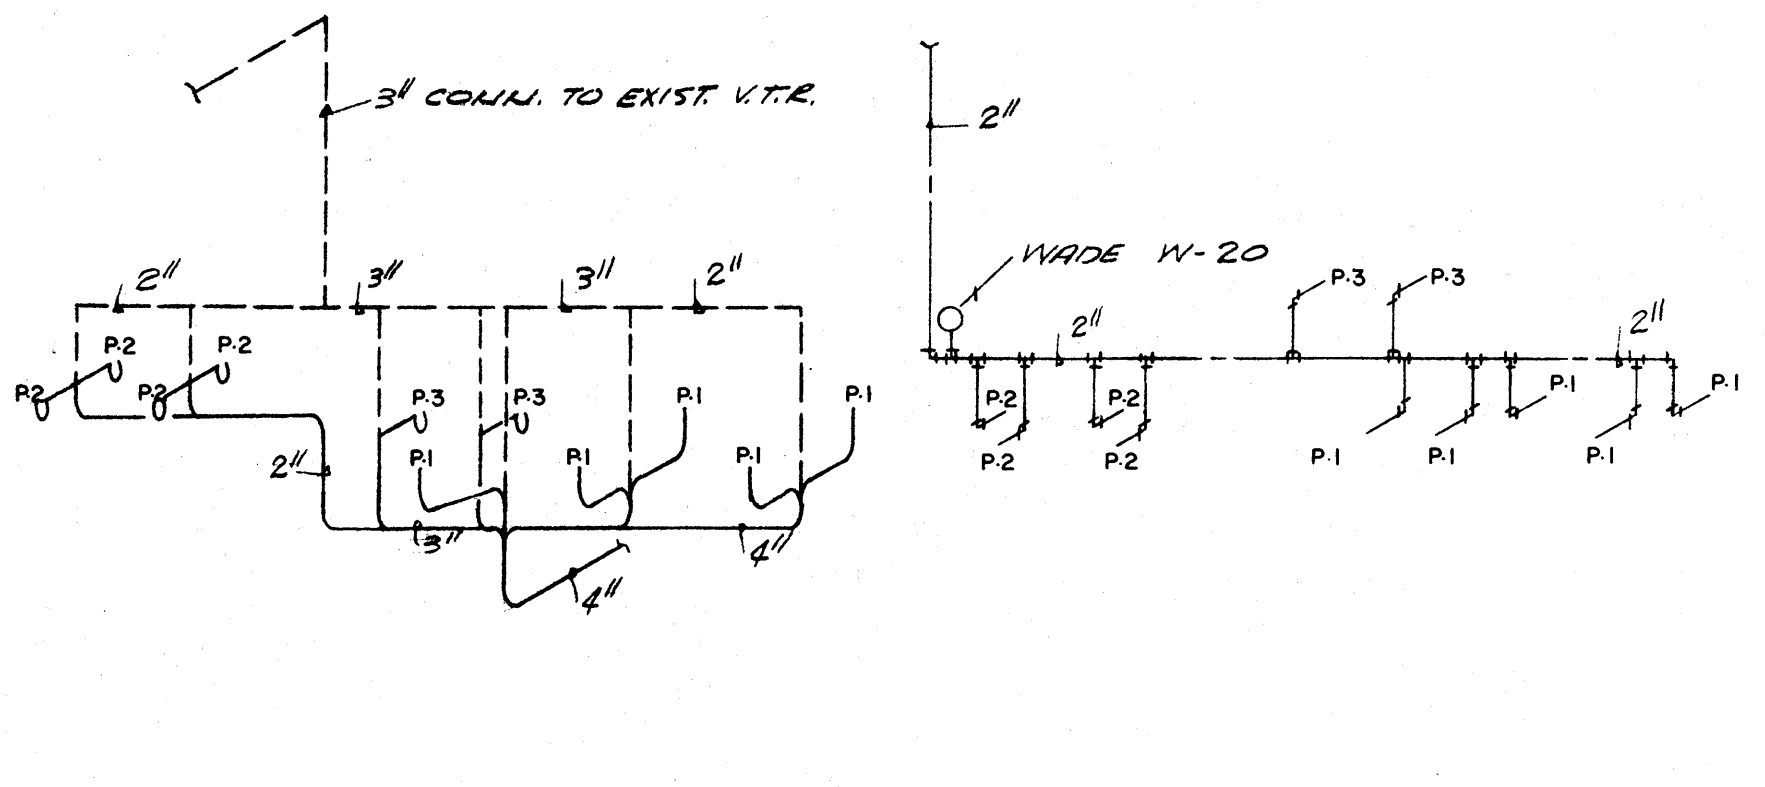

PIPING AT FIRST FLOOR TOILET ROOMS
NO SCALE

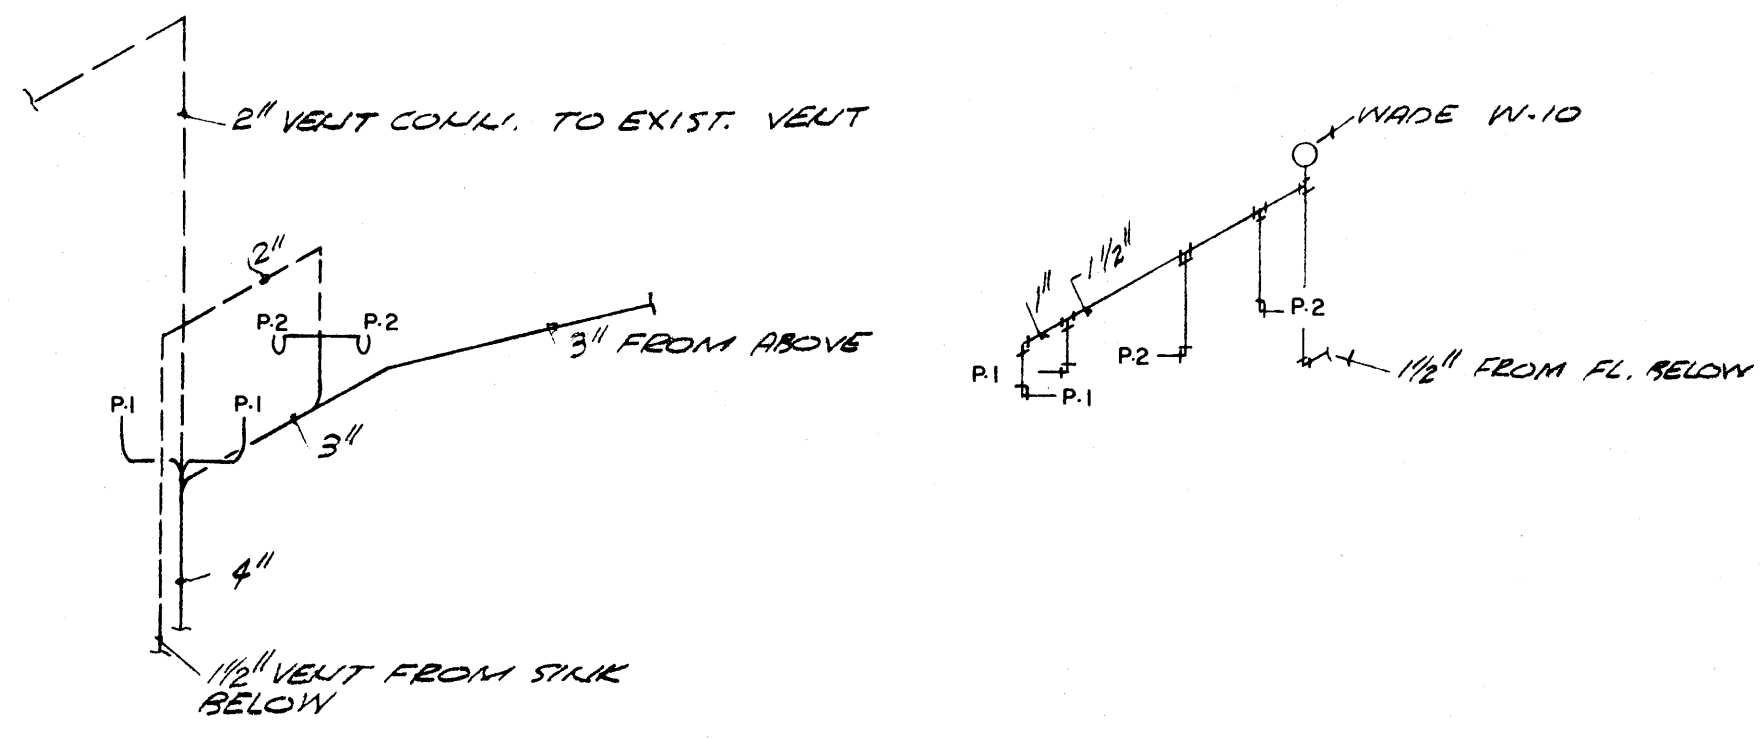

PIPING AT SECOND FLOOR TOILET ROOMS
NO SCALE

PLUMBING		FIXTURES				
SYMBOL	FIXTURE	WASTE	VENT	COLD W.	HOT W.	REMARKS
P-1	WATER CLOSET	4"	2"	1"	-	FLUSH VALVE
P-2	LAVATORY	2"	1 1/2"	1/2"	-	
P-2A	LAVATORY	2"	1 1/2"	1/2"	1/2"	HOT & COLD WATER
P-3	URINAL	2"	1 1/2"	3/4"	-	FLUSH VALVE
P-4	DELUK FTL.	2"	1 1/2"	1/2"	-	ELEC.
P-5	SERVICE SINK	3"	1 1/2"	1/2"	-	
P-6	SINK	2"	1 1/2"	1/2"	1/2"	STAINLESS STEEL
P-7	SHOWER	2"	1 1/2"	1/2"	1/2"	
P-8	SINK	2"	1 1/2"	1/2"	-	STAINLESS STEEL

WATER CONNECTION		SCHEDULE					
NUMBER	OF FIXTURES SUPPLIED						
BRANCH PIPE SIZE	1/2"	3/4"	1"	1 1/4"	1 1/2"	2"	2 1/2"
1/2" FIXTURE CONN.	1**	2 TO 3	4 TO 8				
3/8" FIXTURE CONN.	1	2 TO 3	4 TO 8				

FLUSH VALVES AND IN COMBINATION WITH SMALLER FIXT'US.						
3/8" FLUSH VALVE	1	2	3	4 TO 8	9 TO 15	
1" FLUSH VALVE		1	2	3	4 TO 8	9 TO 15

*PIPE RUNS EXCEEDING 25' IN LENGTH NOT OTHERWISE SHOWN SHALL BE ONE PIPE SIZE LARGER THAN GIVEN ABOVE.
*MAX. LENGTH OF RUN 1/2" PIPE IS 10'.

FLOOR DRAIN SCHEDULE		
FD-1	WADE W-2030-F	NICKEL-BRASS TOP
FD-2	WADE W-2030-EF	BRASS FULCRUM TOP
FD-3	WADE W-1100-EF	" " " " DEEP SEAL TRAP
FD-4	WADE W-1100-A	NICKEL-BRASS TOP, " " " "

PLUMBING SYMBOLS			
---	SANITARY WASTE	---	HOT WATER
---	SANITARY VENT	---	GAS
---	WATER	---	F.C.O. FLOOR CLEAN OUT

DATE 2-21-66
DRAWN BY RSJ
CHECKED BY
REVISIONS

RENOVATIONS TO
WILSON HALL
ARKANSAS STATE COLLEGE
JONESBORO, ARKANSAS

STUCK, FRIER, LANE & SCOTT, INC., ARCHITECTS
601 SOUTHWEST DRIVE • JONESBORO, ARKANSAS





SHEET NUMBER
M-2
COMMISSION NUMBER
43866

Office of GRIFFITH C. BURR
CONSULTING ENGINEERS
MEMPHIS, TENNESSEE

GRILLES, REGISTERS & DIFFUSERS				
SYMBOL	DESCRIPTION	FINISH	MFR.	MODEL
CD	ROUND CEILING DIFFUSER	PAKED WHITE ENAMEL	ANEMOSTAT	CD-2/LD/EO
CD-1	SQUARE PERF. FACE FOR LAT-IN CLD.	"	"	PD/POB/PEO
CD-2	SQUARE PERF. FACE FOR PLASTER CLG.	"	"	PD-1/POB/PED
CD-3	HALF RD. LOUVER FACE FOR EXPOSED DUCT, 2-WAY	"	"	W-13/INOB
SAR	REMOVABLE CORE, ALUMINUM REG.	NATURAL ALUMINUM	WATERLOO	2250/SILHOUETTE
SG	REMOVABLE CORE SUPPLY GRILLE W/CORE SECURED	WHITE ENAMEL FACE	"	225/SILHOUETTE
RAG	REMOVABLE CORE RETURN GRILLE	NATURAL ALUMINUM	"	355
DG	ADJUSTABLE TYPE FLANGED DOOR GRILLE	"	"	X/OVA
ER	EXHAUST REGISTER	"	"	XRG 35HD
RAG	SAME AS RAG EXCEPT W/ OPPOSED BLADE DAMPER	"	"	3550

NOTE: APPROXIMATE OUTLINE OF EXISTING STEAM SYSTEM PIPE TUNNEL. EXISTING RUNOUTS TO PERIMETER ARE 1/2" TILE

NOTE: SHADING DENOTES NEW CONSTRUCTION. SEE ARCHITECTURAL PLANS FOR EXISTING PARTITIONS, ETC.

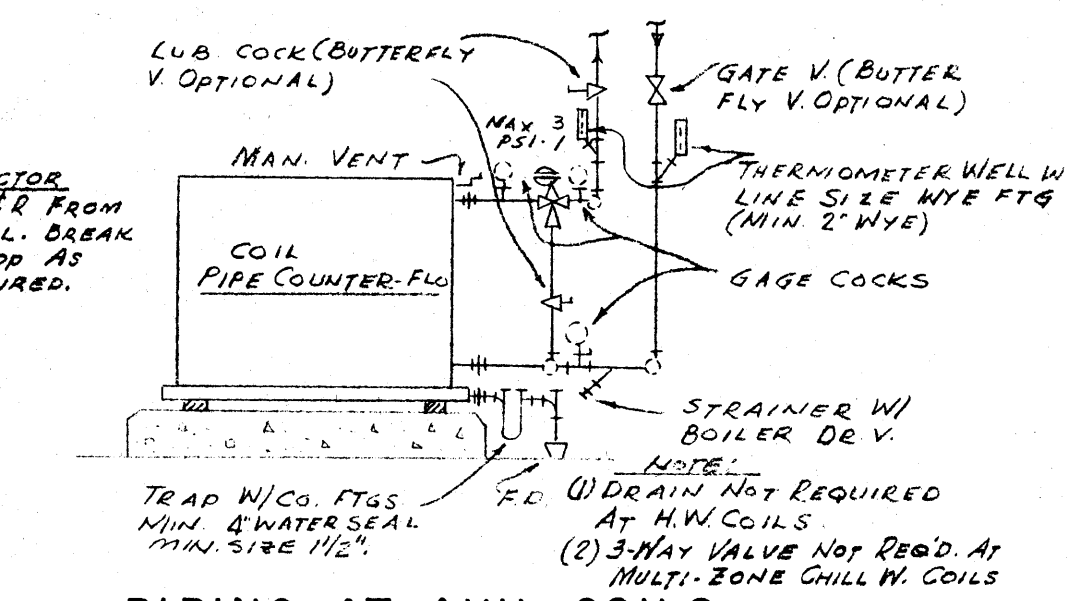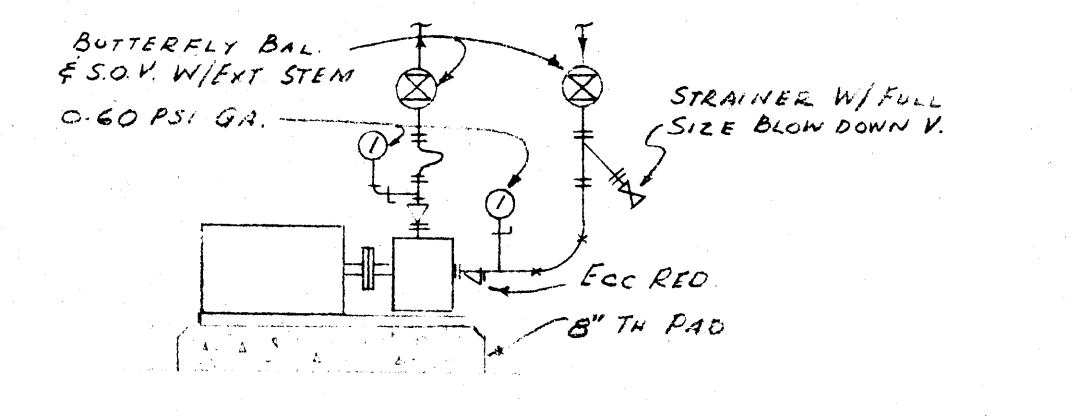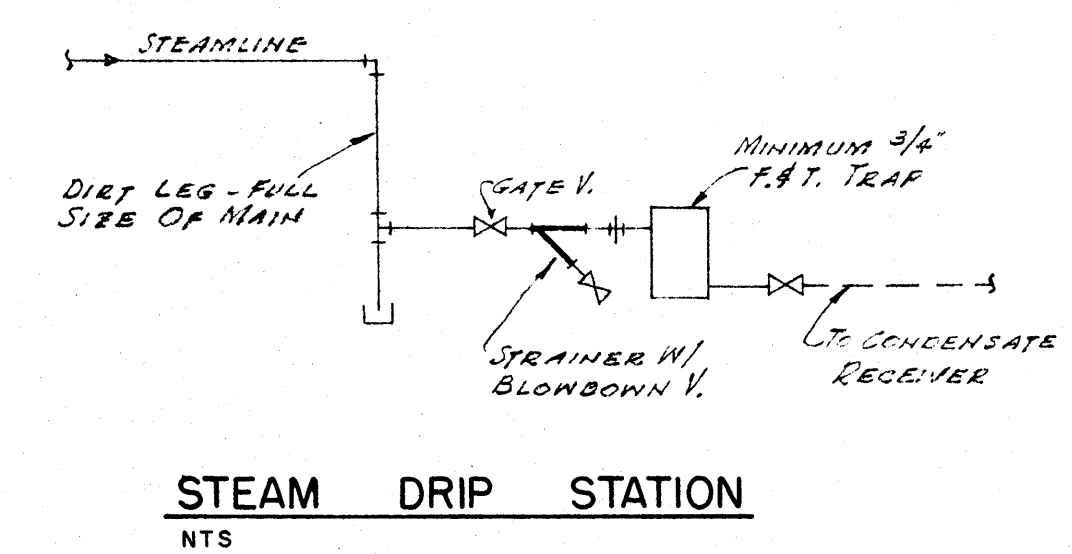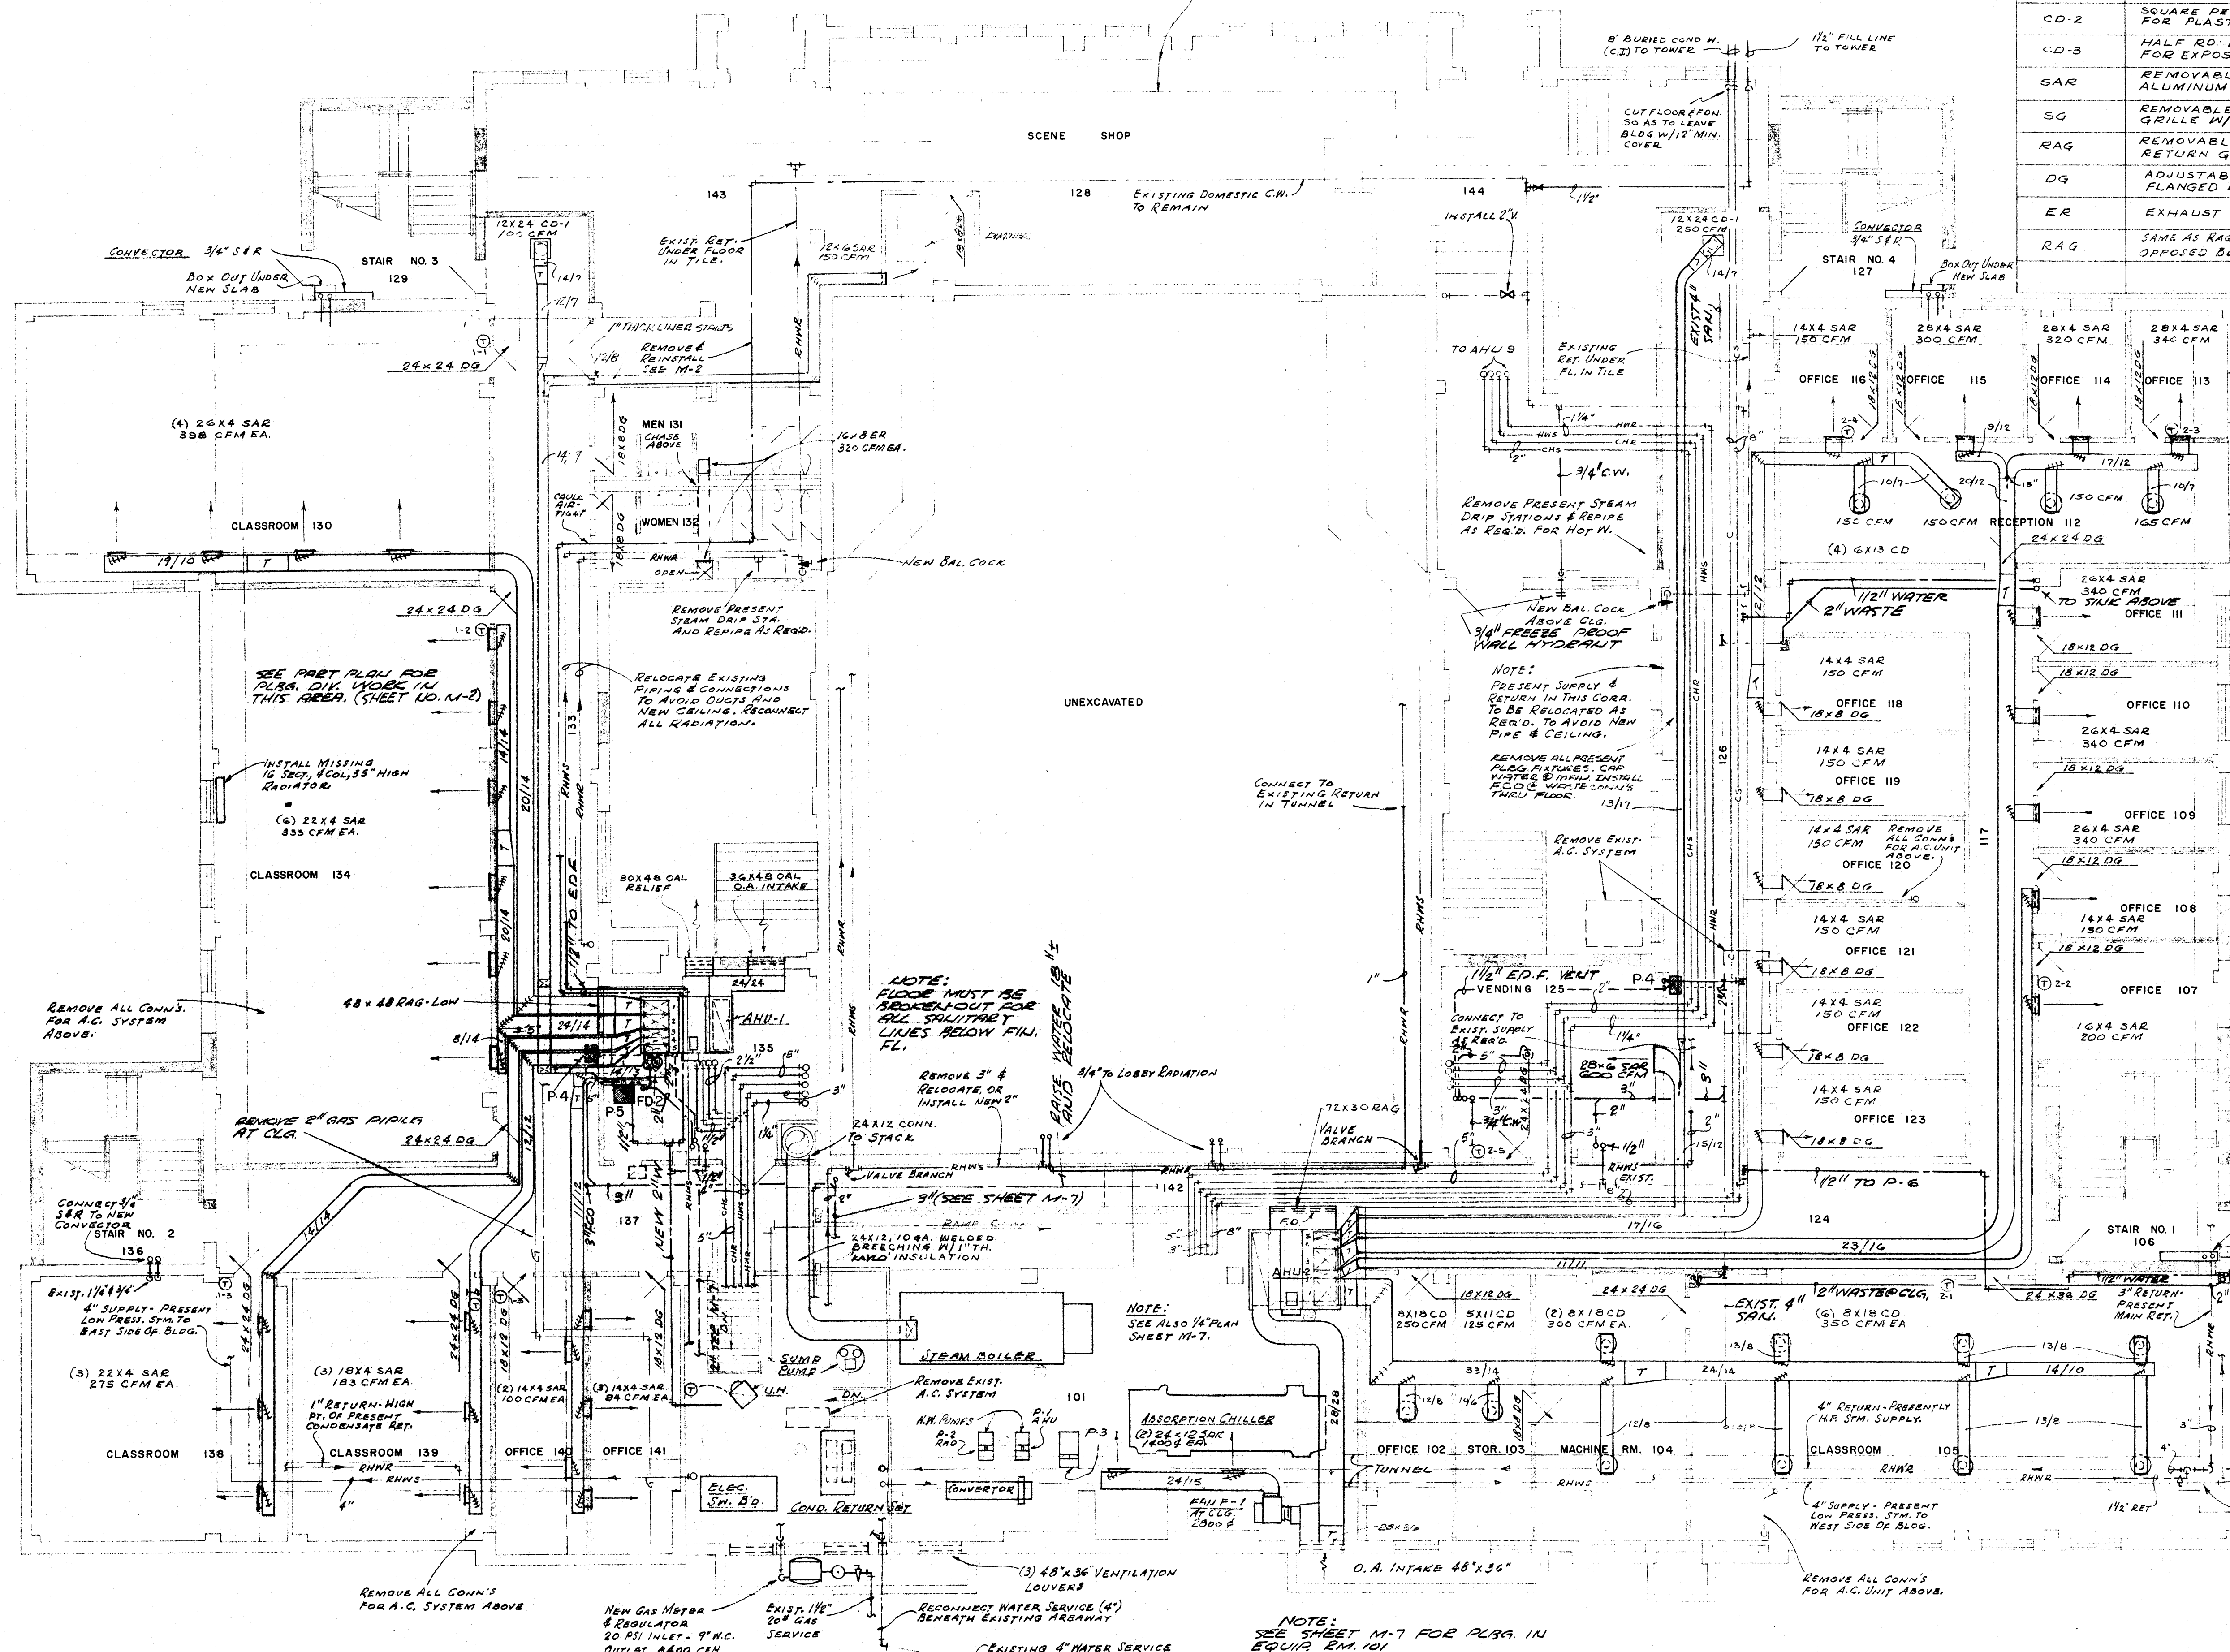


FIRST FLOOR PLAN - HVAC & PLUMBING SCALE 1/8"=1'-0"

	DATE	2-21-66	RENOVATIONS TO WILSON HALL ARKANSAS STATE COLLEGE JONESBORO, ARKANSAS	SHEET NUMBER M-3
	DRAWN BY	GBJR, RP		
	CHECKED BY			
	REVISIONS			
Office of GRIFFITH C. BURR CONSULTING ENGINEERS MEMPHIS, TENNESSEE			STUCK, FRIER, LANE & SCOTT, INC., ARCHITECTS 601 SOUTHWEST DRIVE • JONESBORO, ARKANSAS	

NOTE:
SHADING DENOTES NEW CONSTRUCTION.
SEE ARCHITECTURAL PLANS FOR
EXISTING PARTITIONS, ETC.

UNIT	ZONE									
	1	2	3	4	5	6	7	8	9	10
AHU-1	1,590	2,000	825	550	700					
AHU-2	3,075	350	2,295	1,350	850					
AHU-3	1,010	800	1,940	2,840	890	740	700	800		
AHU-4	980	870	1,545	675	1,935	1,920				
AHU-5	730	2,680	810	1,200	450	1,090	670	570	1,150	750
AHU-6	1,165	1,250	890	670	2,050	2,640	730			
AHU-7	1,415	1,690	1,470	1,375	690	6,350	1,400	870	665	1,360
AHU-8	1,360	1,070	870	1,400	6,350	905	1,375	1,500	1,710	1,240


NOTE: INSTALL OPPOSED BLADE DAMPER W/
INDEXED QUADRANT IN EACH ZONE DUCT.

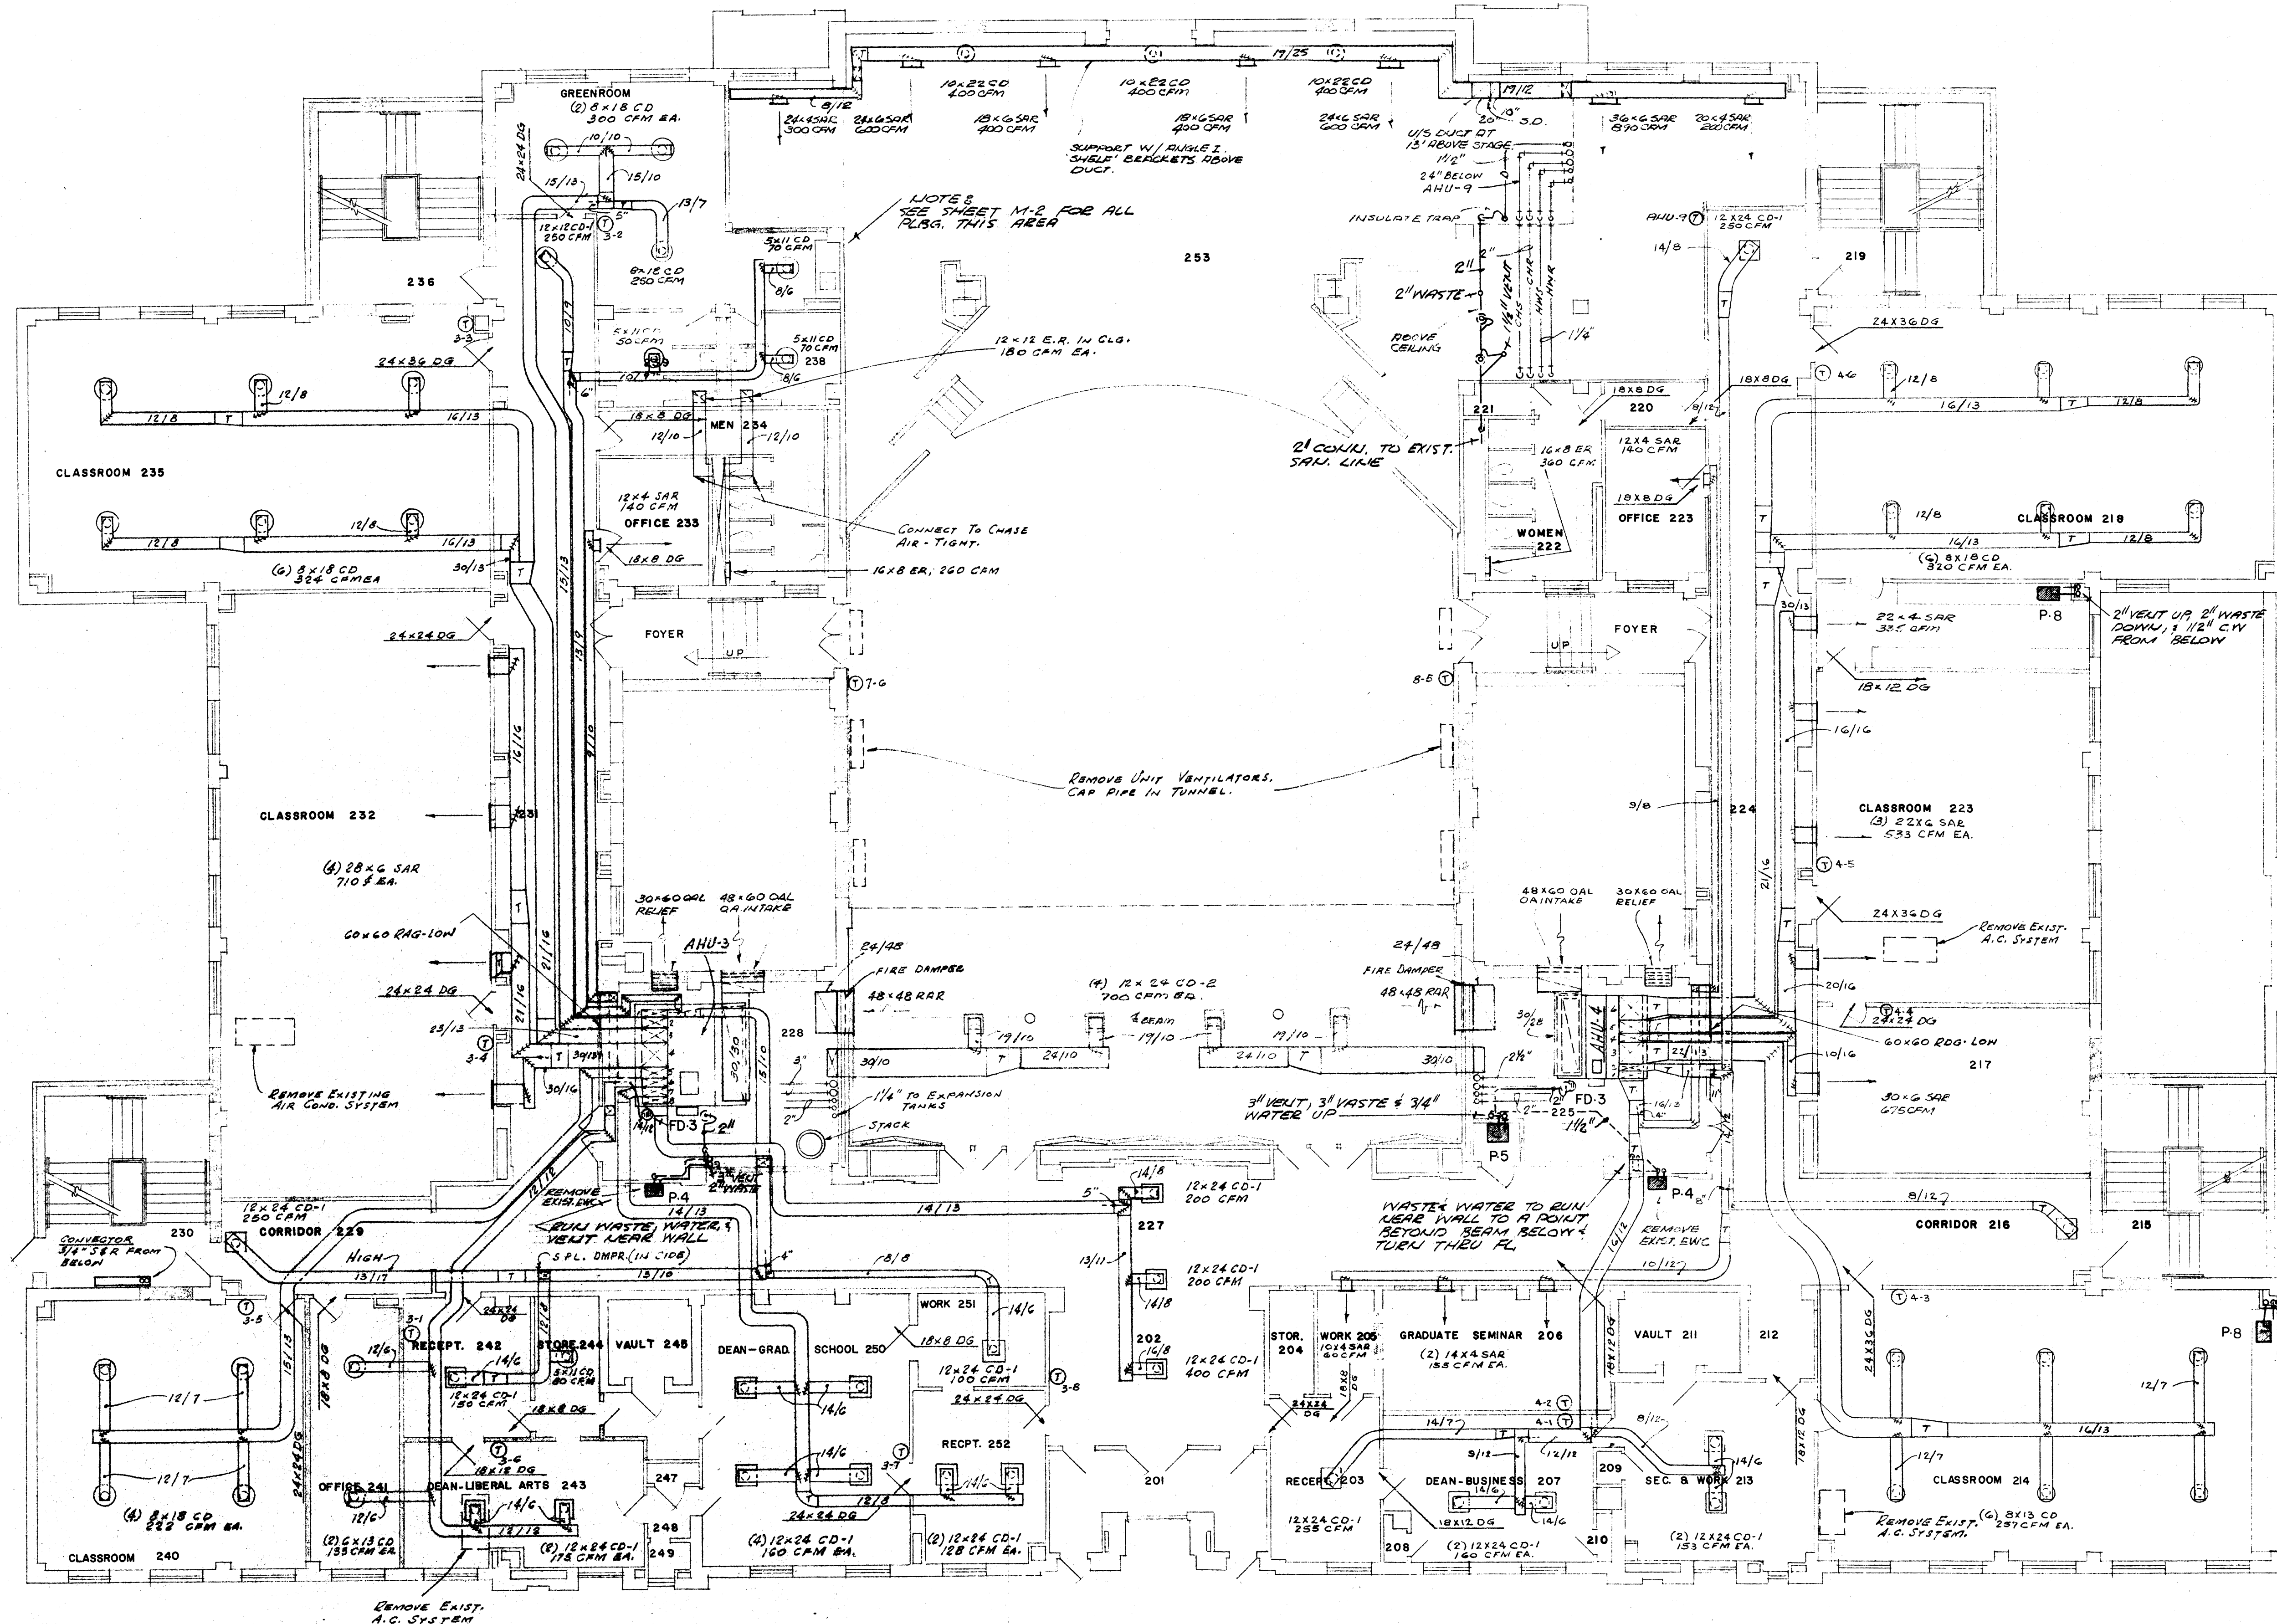

HVAC SYMBOLS

- STEAM
- PR — CONDENSATE RETURN
- CHS — PUMPED RETURN
- CHR — CHILL WATER SUPPLY
- CWR — CHILL WATER RETURN
- HWS — HOT WATER SUPPLY (AHU)
- HWR — HOT WATER RETURN (AHU)
- RHWS — HOT WATER SUPPLY (RADIATION)
- RHWR — HOT WATER RETURN (RADIATION)
- CS — SUPPLY TO CONDENSER
- C — RETURN FROM CONDENSER
- G — GATE VALVE
- G — GLOBE VALVE
- B — BUTTERFLY BAL. & GATE VALVE W/ THROTTLE PLATE
- C — CHECK VALVE
- W — WYE STRAINER
- B — BAL. COCK
- V — VENT COCK
- S — STEAM TRAP
- T — THERMOSTAT (ZONE #2 AT AHU-3)
- R — RECTANGULAR RISER (NEG. PRESSURE)
- R — RECTANGULAR RISER (POS. PRESSURE)
- A — ADJUSTABLE SPLITTER DAMPER (PROPORTION SPLITTER TO BRANCH SIZE)
- B — BRANCH DUCT W/ STATIONARY VOL. EXTRACTOR & TRANSITION
- FD — FIRE DAMPER (20" H.C. BALL BEARING E.M.C. "FIRESEAL")
- OAL — OUTSIDE AIR LOUVER (BY GEN. CONTR.)





SECOND FLOOR PLAN-HVAC & PLUMBING SCALE 1/8" = 1'-0"

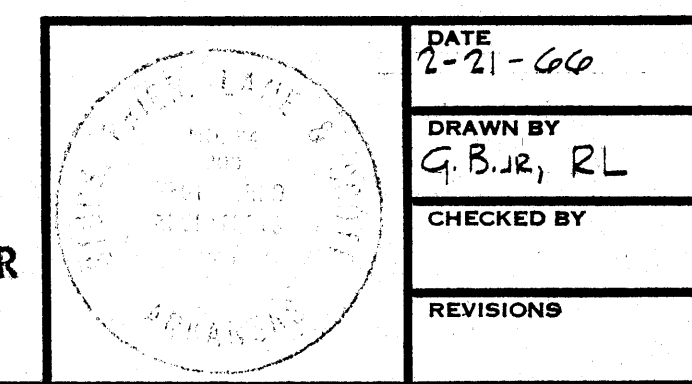


Office of GRIFFITH C. BURR
CONSULTING ENGINEERS
MEMPHIS, TENNESSEE

RENOVATIONS TO
WILSON HALL
ARKANSAS STATE COLLEGE
JONESBORO, ARKANSAS
STUCK, FRIER, LANE & SCOTT, INC., ARCHITECTS
601 SOUTHWEST DRIVE • JONESBORO, ARKANSAS

SHEET NUMBER
M-4
COMMISSION NUMBER
45800

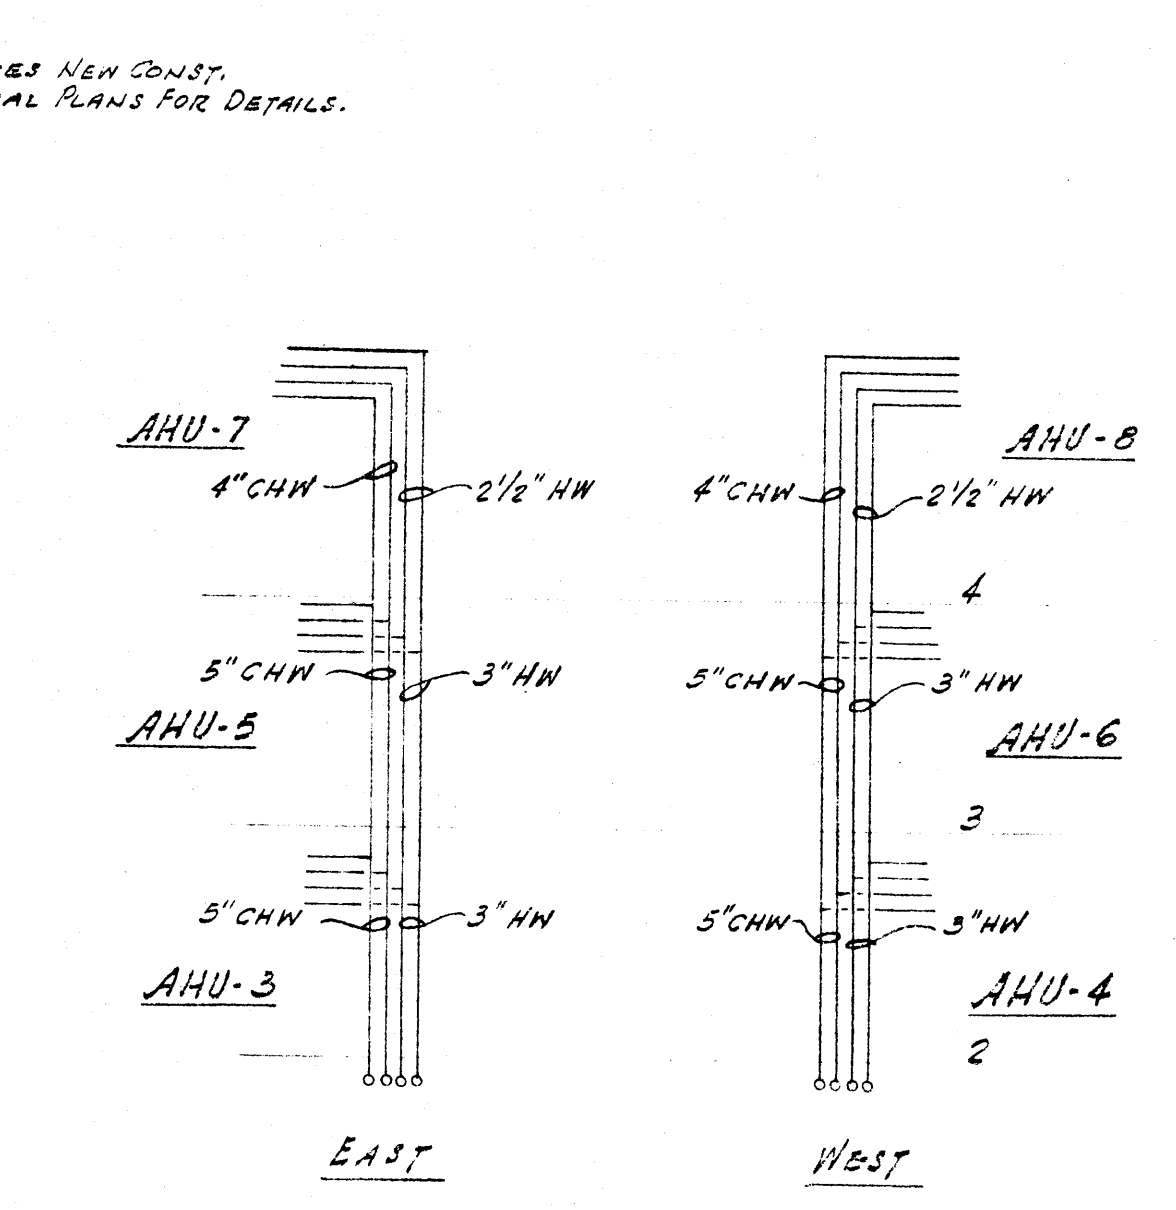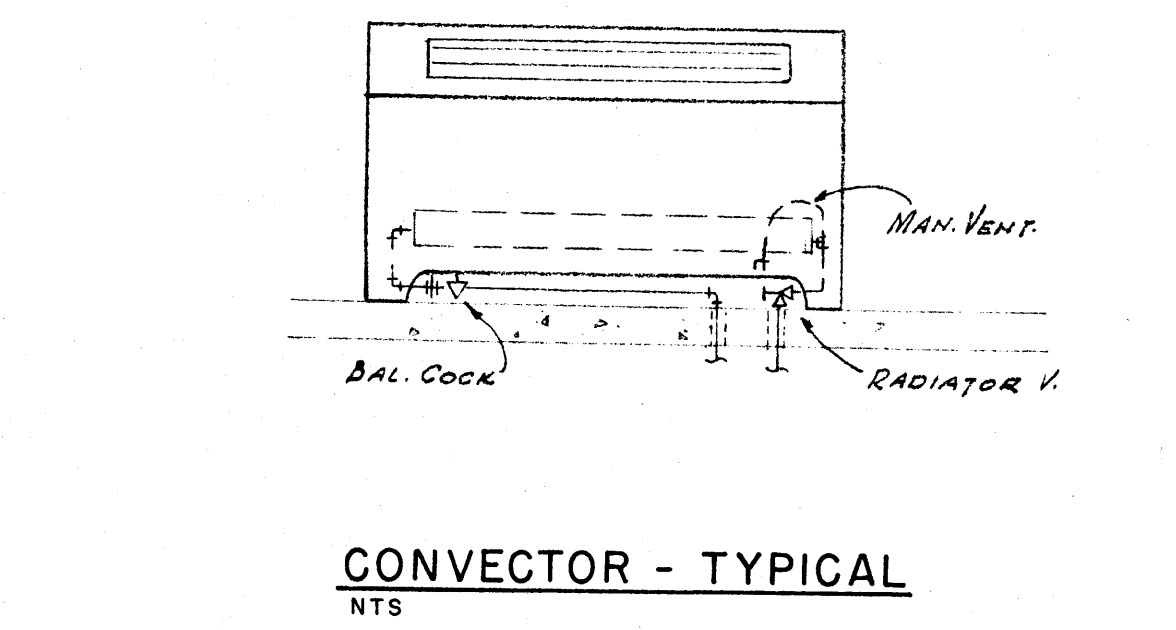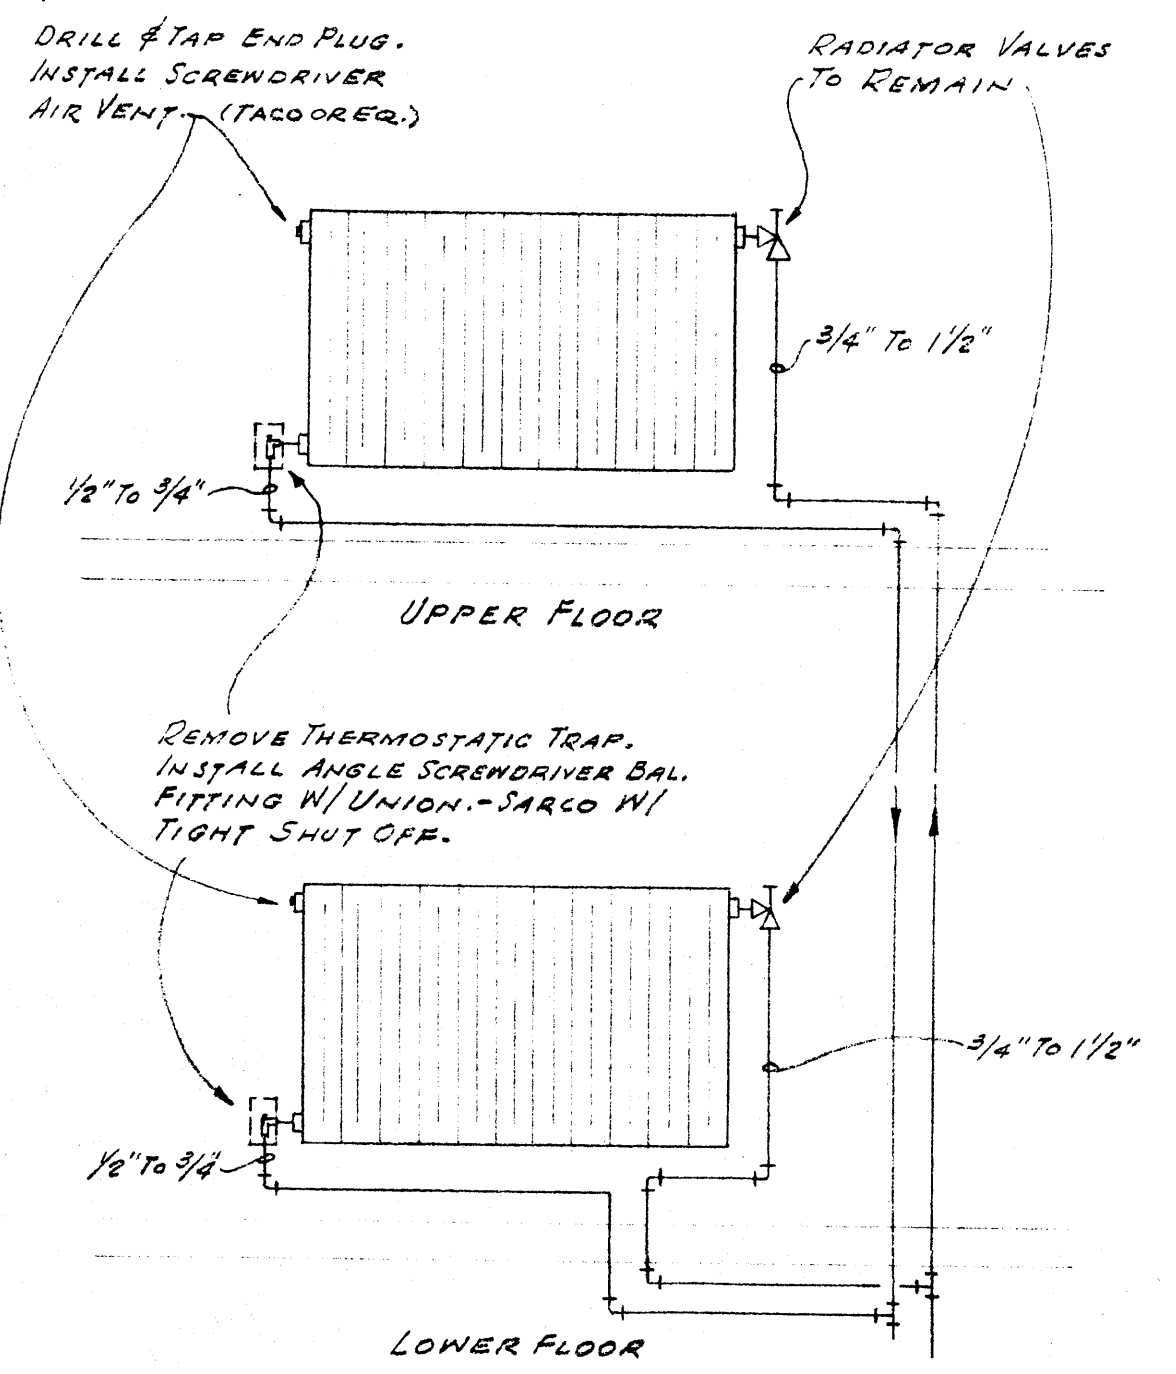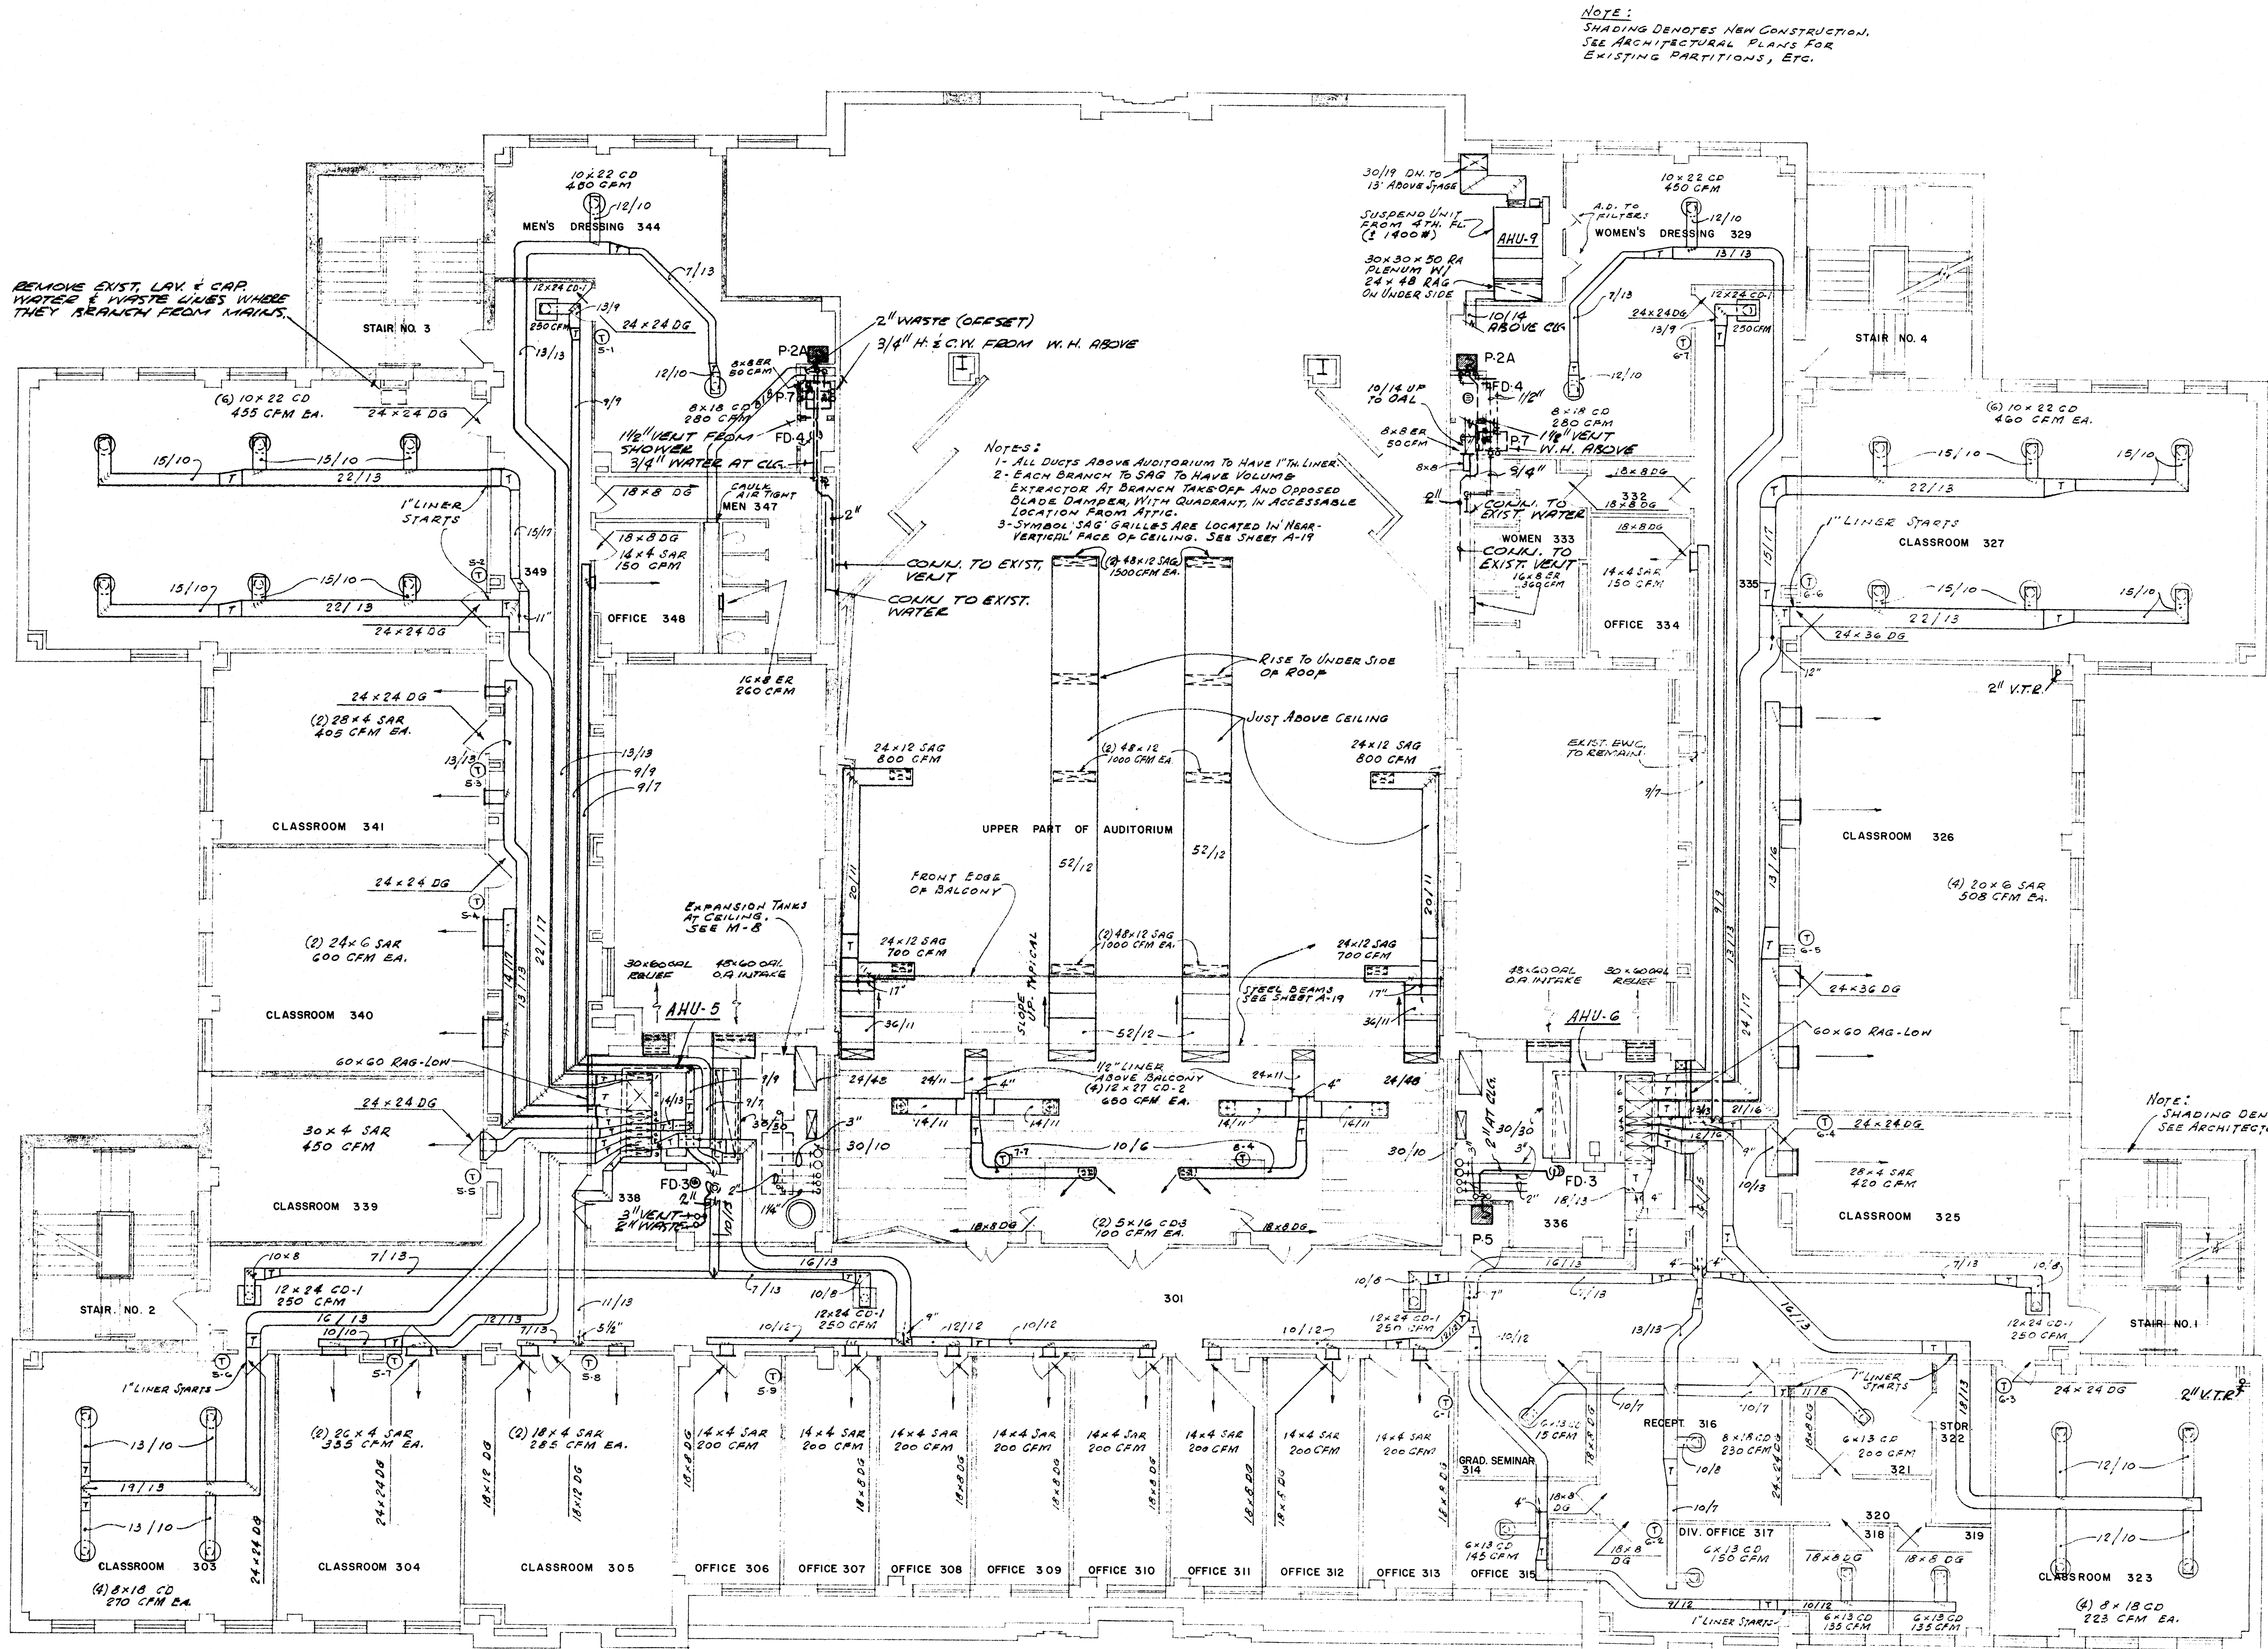


THIRD FLOOR PLAN - HVAC & PLUMBING SCALE 1/8" = 1'-0"

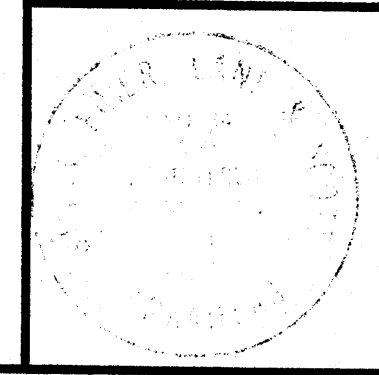


DATE 2-21-66	REVISIONS	RENOVATIONS TO WILSON HALL ARKANSAS STATE COLLEGE JONESBORO, ARKANSAS	SHEET NUMBER M-5
DRAWN BY G.B.R., B.L.	CHECKED BY		
Office of GRIFFITH C. BURR CONSULTING ENGINEERS MEMPHIS, TENNESSEE		STUCK, FRIER, LANE & SCOTT, INC., ARCHITECTS 601 SOUTHWEST DRIVE • JONESBORO, ARKANSAS	


NOTE:
 SHADING DENOTES NEW CONSTRUCTION.
 SEE ARCHITECTURAL PLANS FOR
 EXISTING PARTITIONS, ETC.

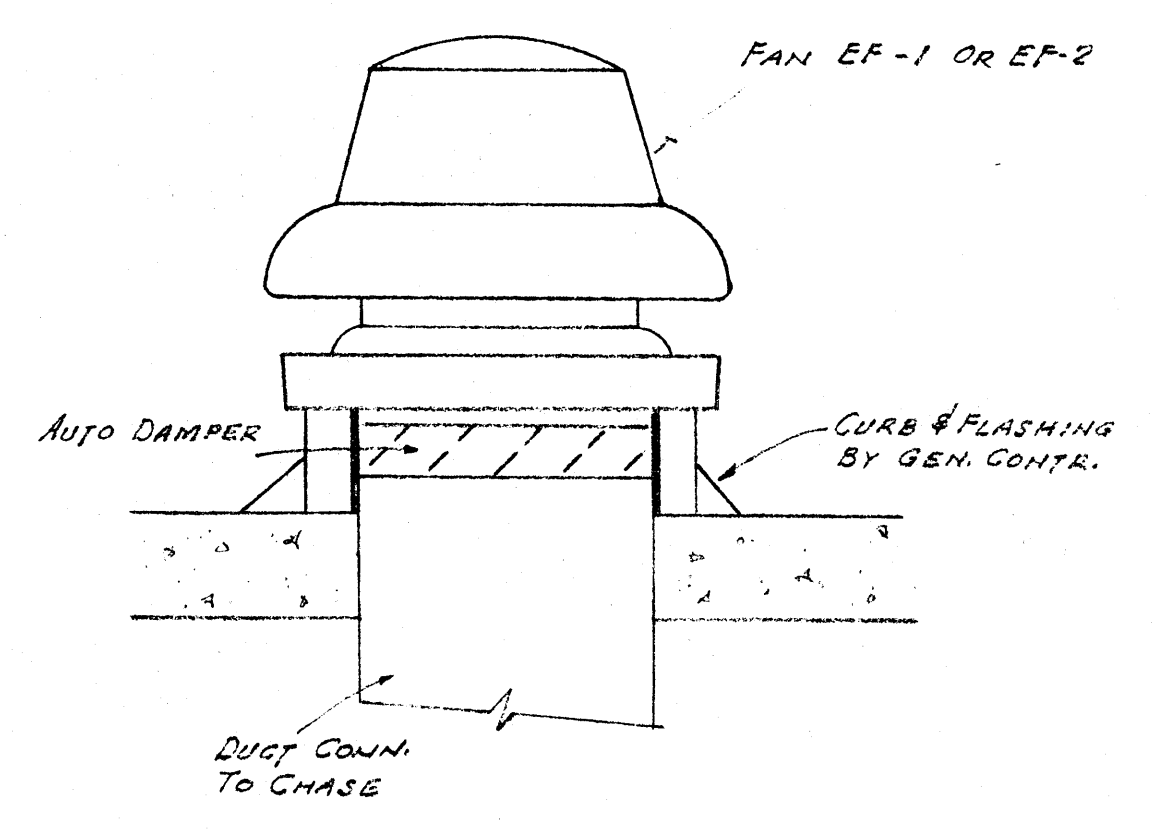

ROOF EXHAUSTER
 NTS

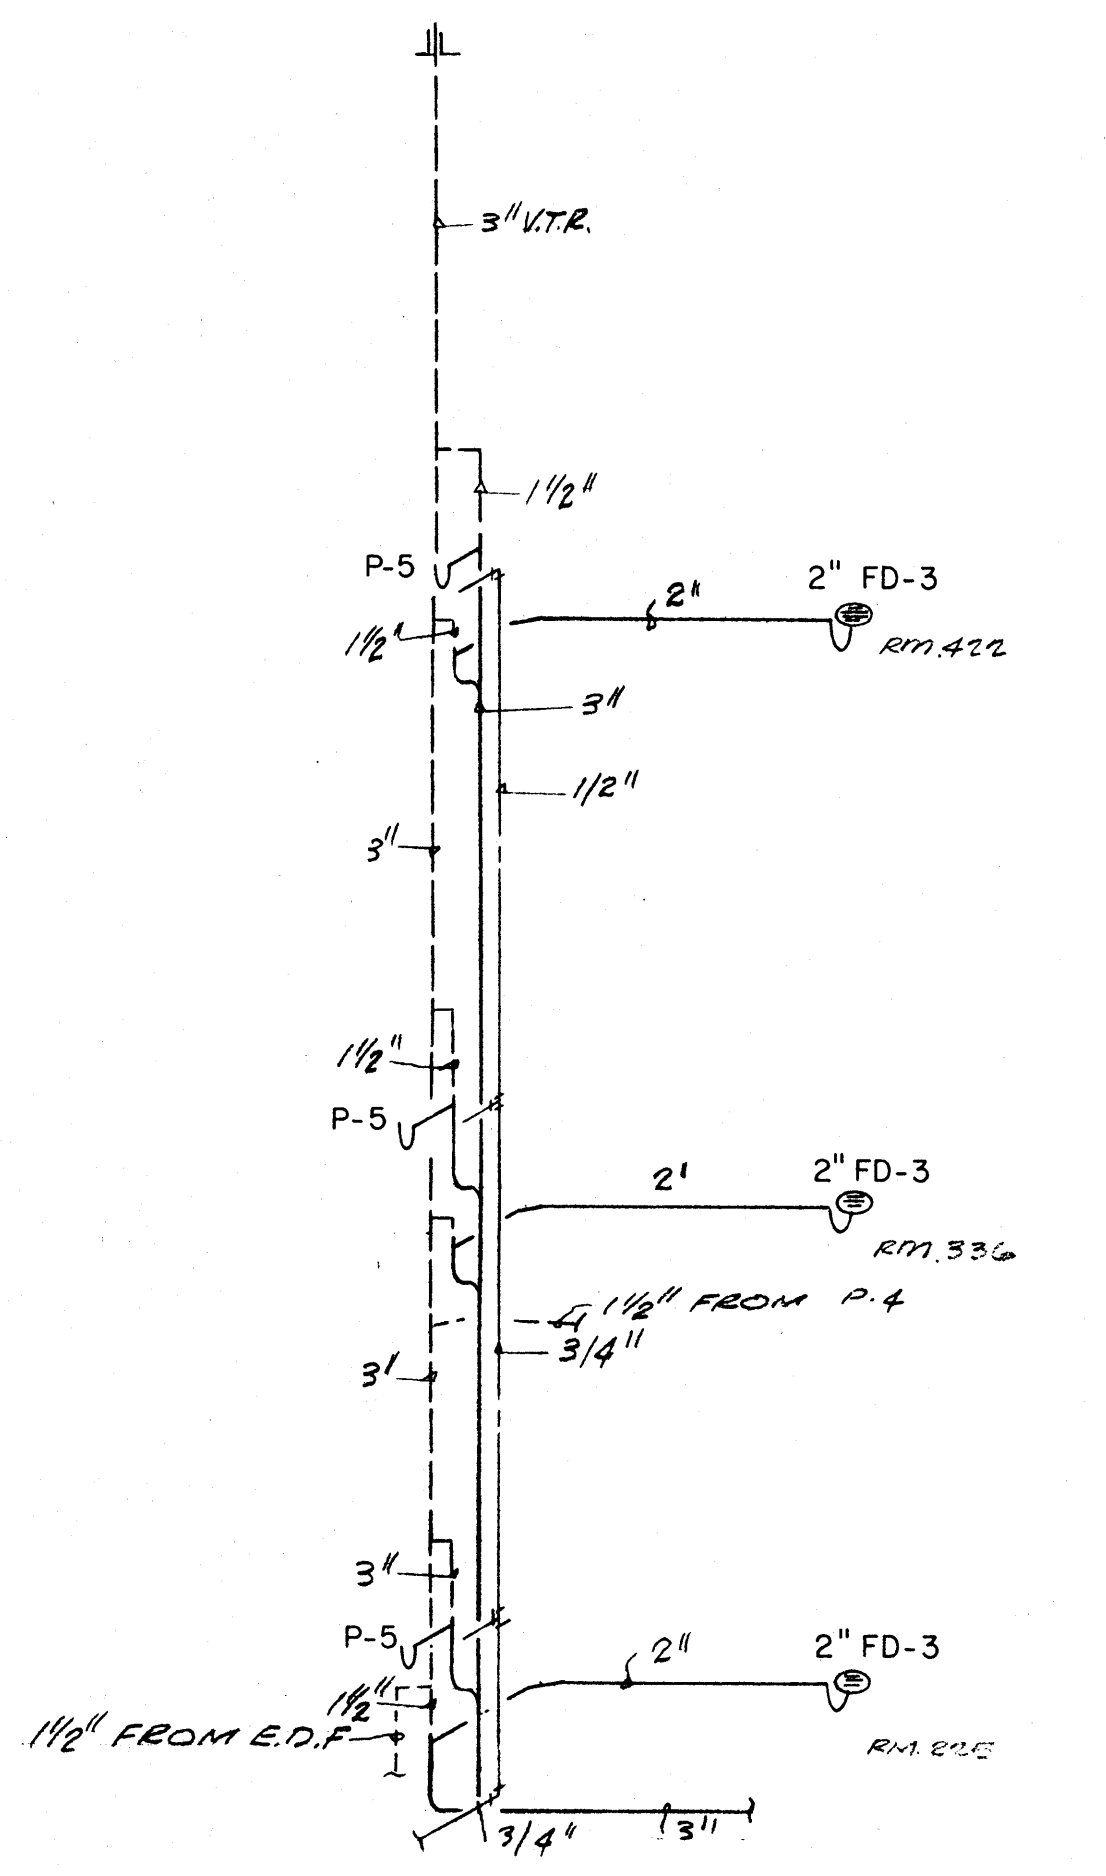


PIPING AT SERVICE SINKS
 NO SCALE

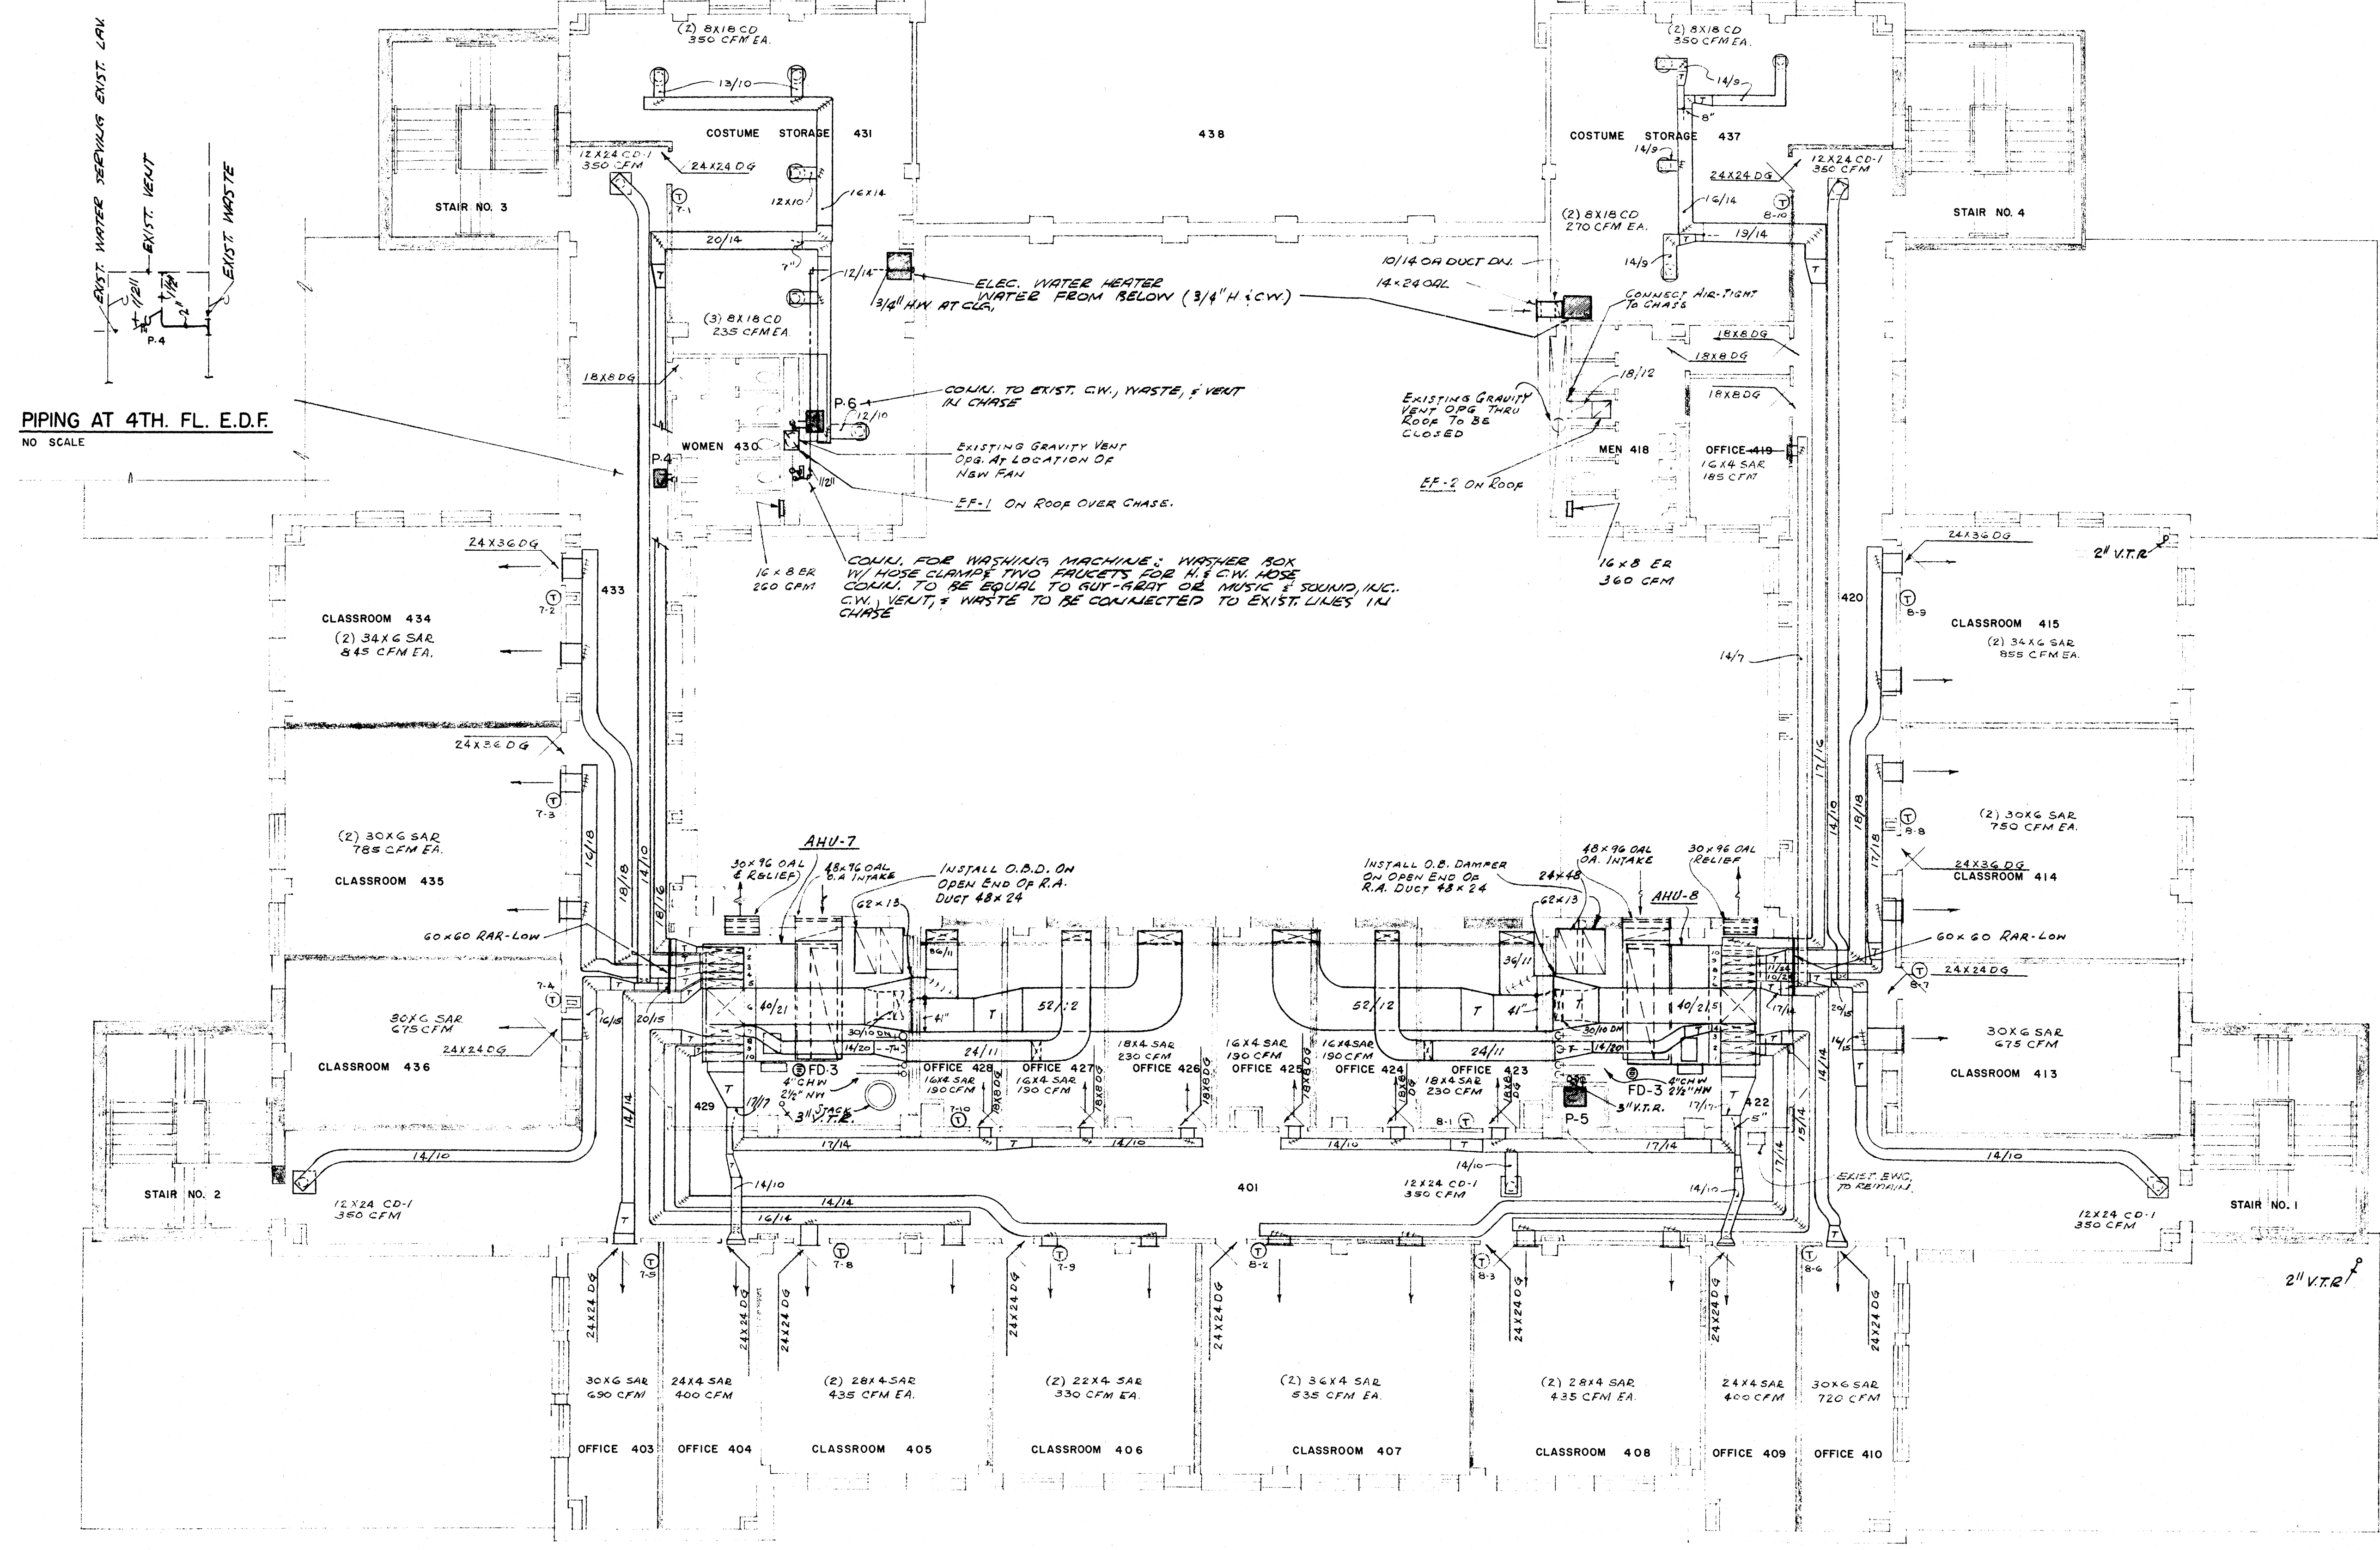


PIPING AT 4TH. FL. E.D.F.
 NO SCALE

FOURTH FLOOR PLAN-HVAC & PLUMBING SCALE 1/8" = 1'-0"

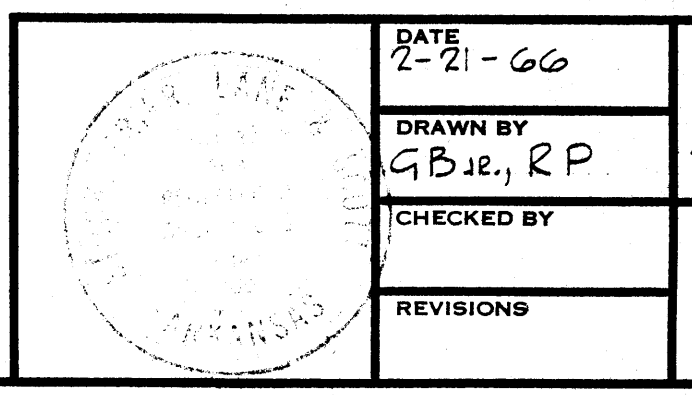


Office of GRIFFITH C. BURR
 CONSULTING ENGINEERS
 MEMPHIS, TENNESSEE


DATE 2-21-66	RENOVATIONS TO WILSON HALL ARKANSAS STATE COLLEGE JONESBORO, ARKANSAS	SHEET NUMBER M-6
DRAWN BY GB Jr., RP		
CHECKED BY	STUCK, FRIER, LANE & SCOTT, INC., ARCHITECTS	COMMISSION NUMBER 43866
REVISIONS		
601 SOUTHWEST DRIVE • JONESBORO, ARKANSAS		

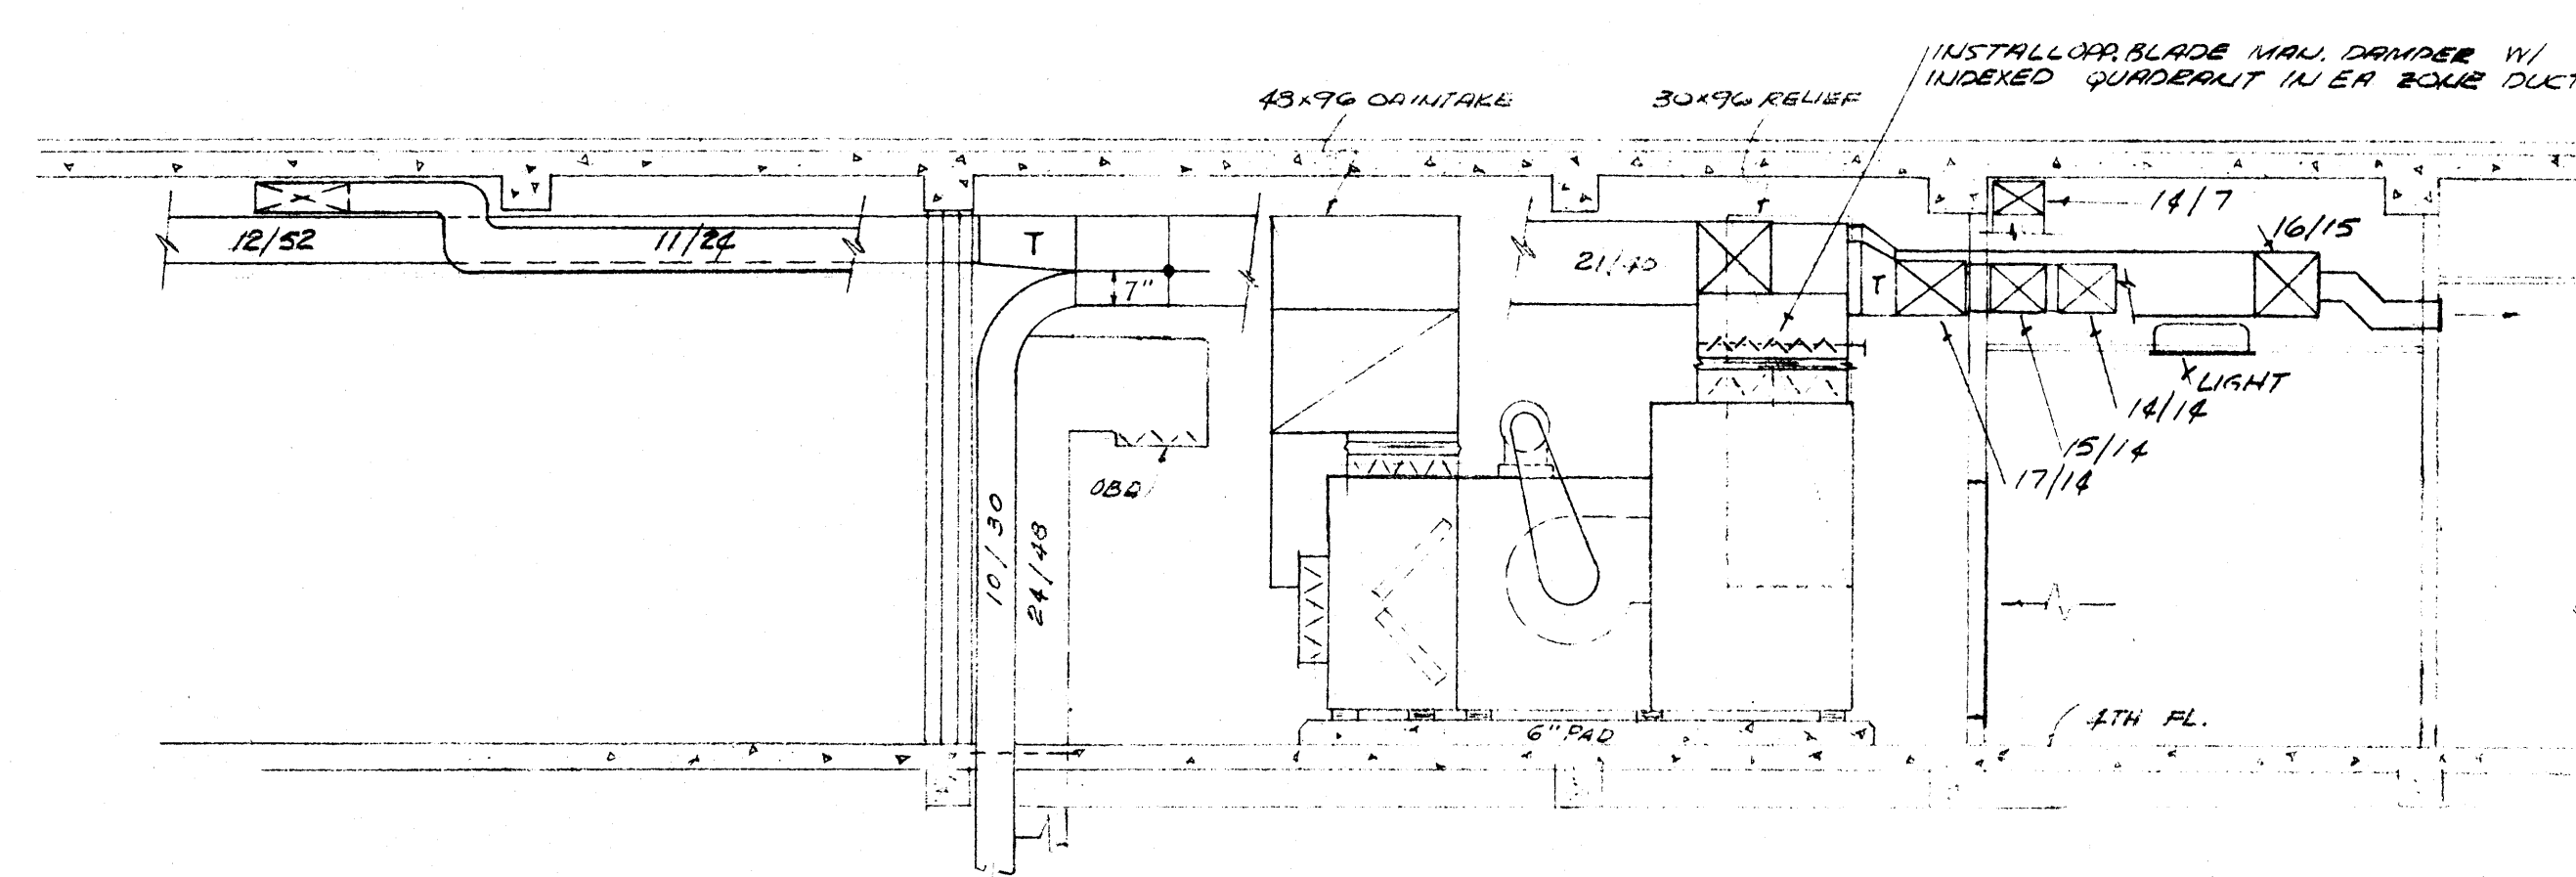


SECTION AT AHU-8
SCALE 1/4" = 1'-0"

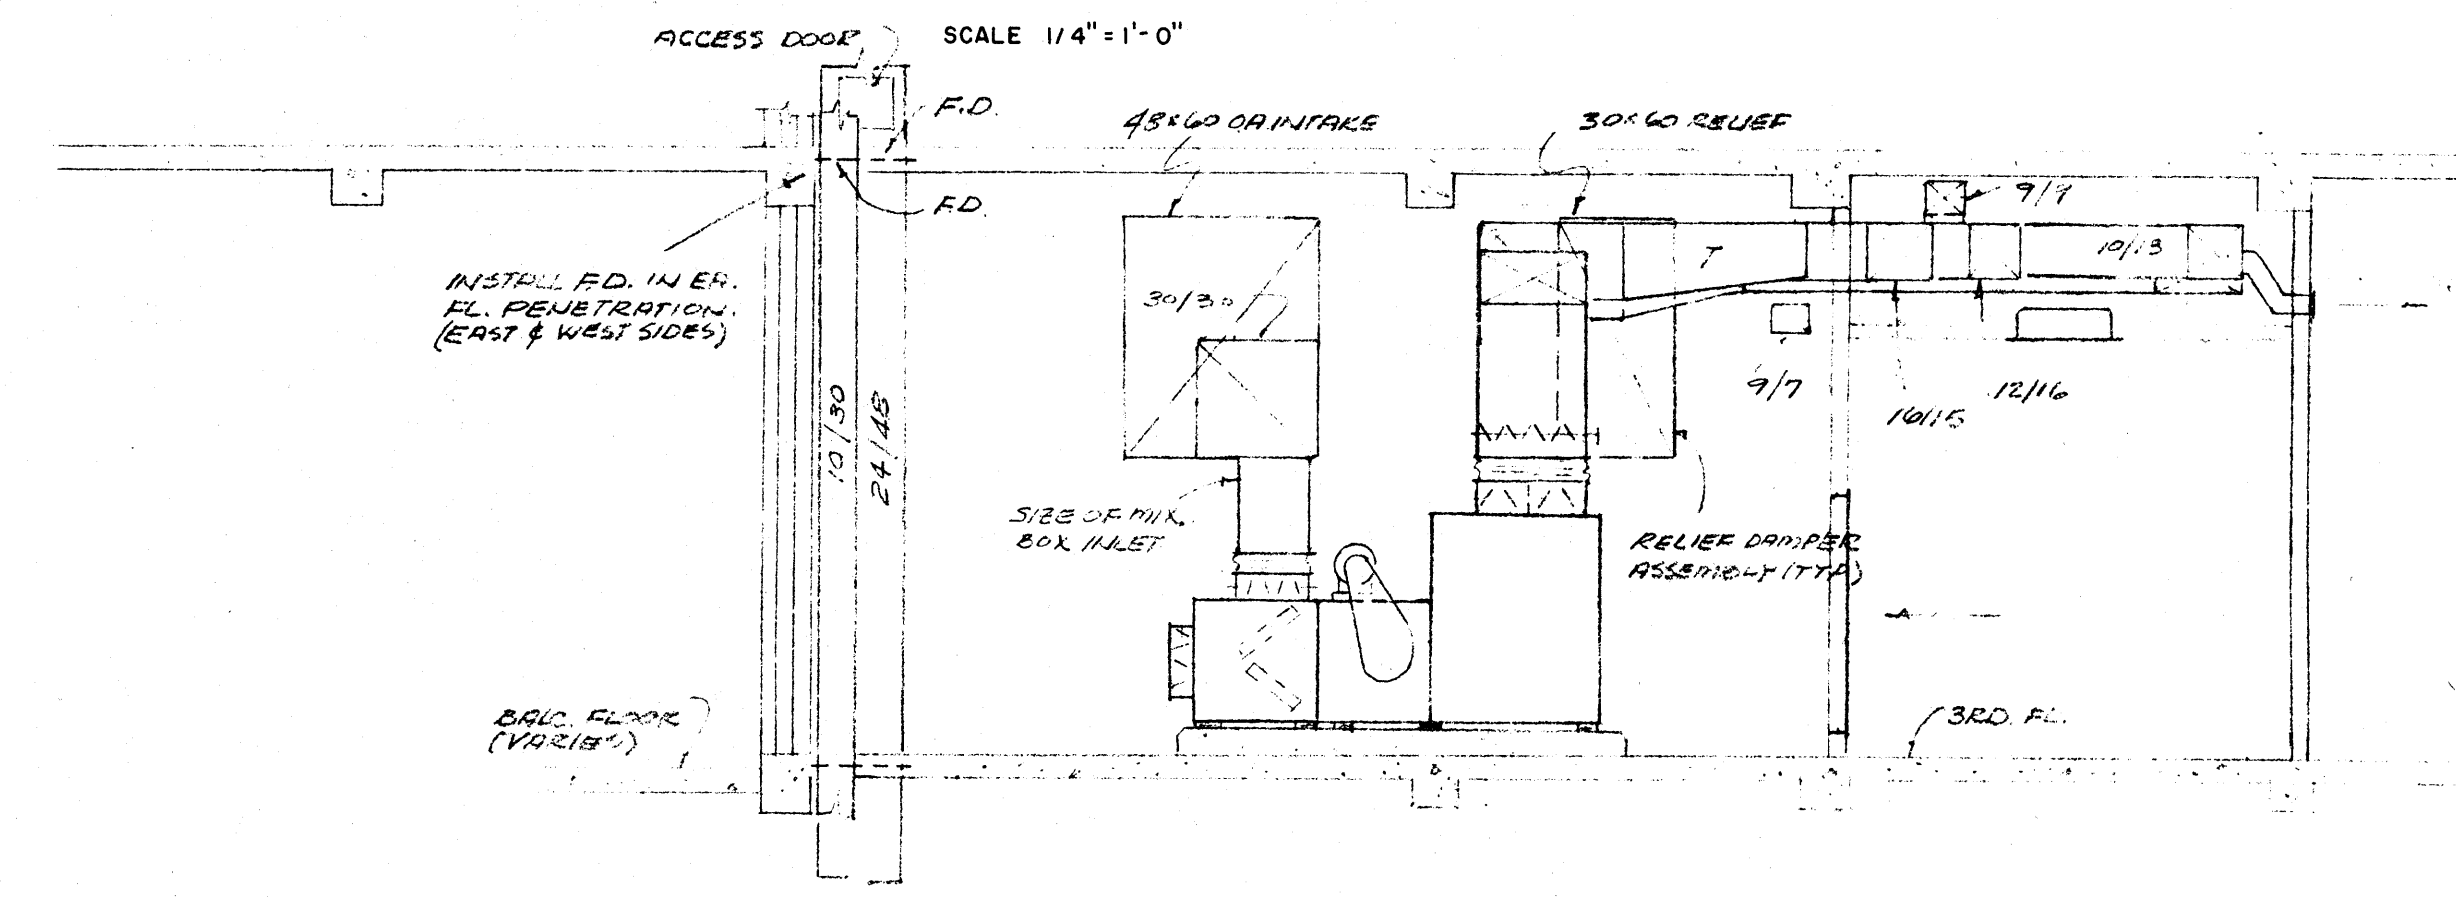


SECTION AT AHU-6
SCALE 1/4" = 1'-0"

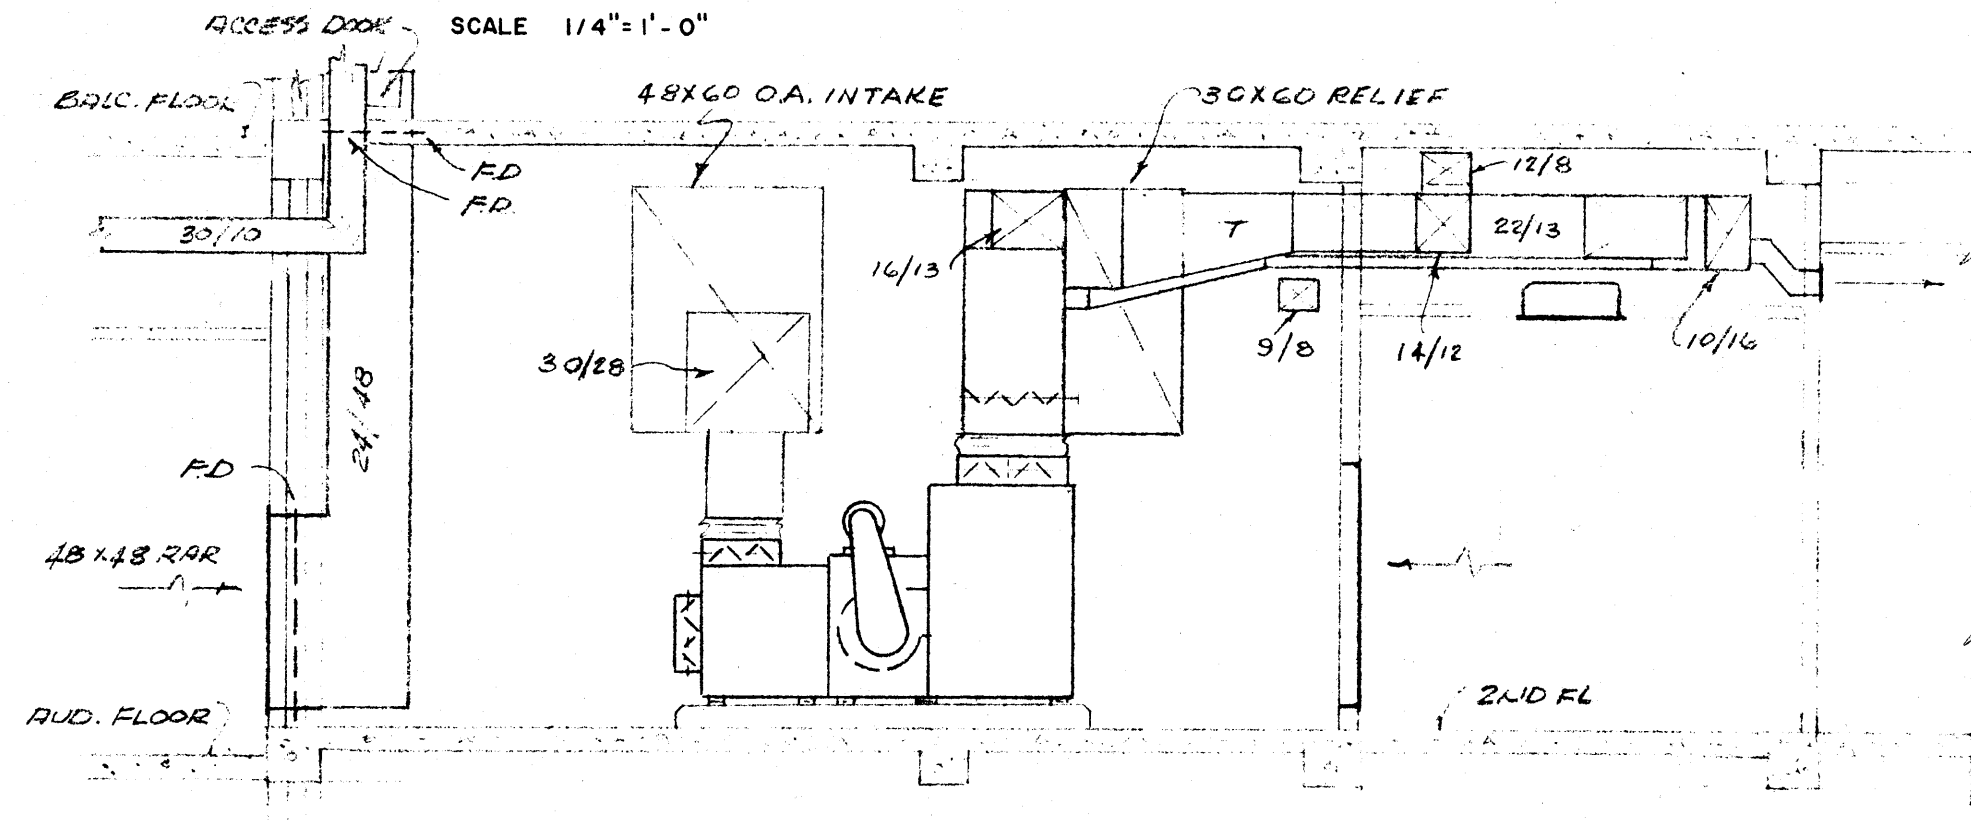

SECTION AT AHU-4
SCALE 1/4" = 1'-0"

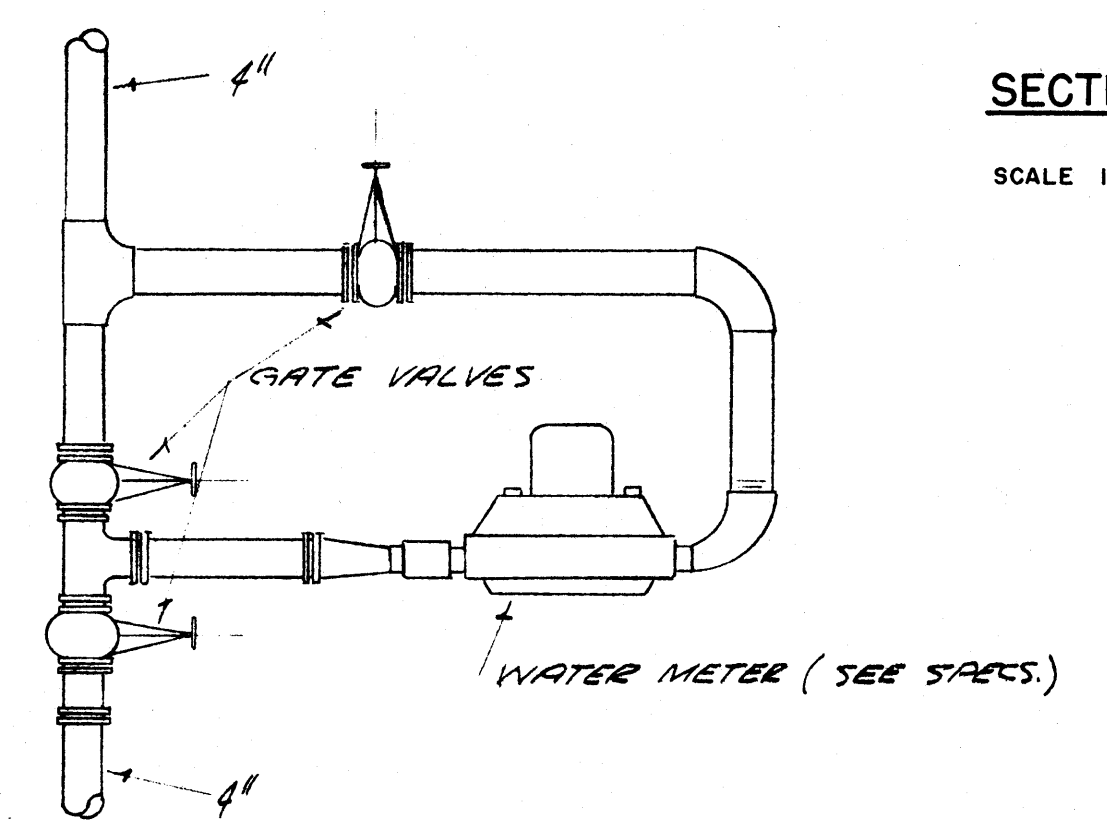


WATER METER DETAIL
NO SCALE

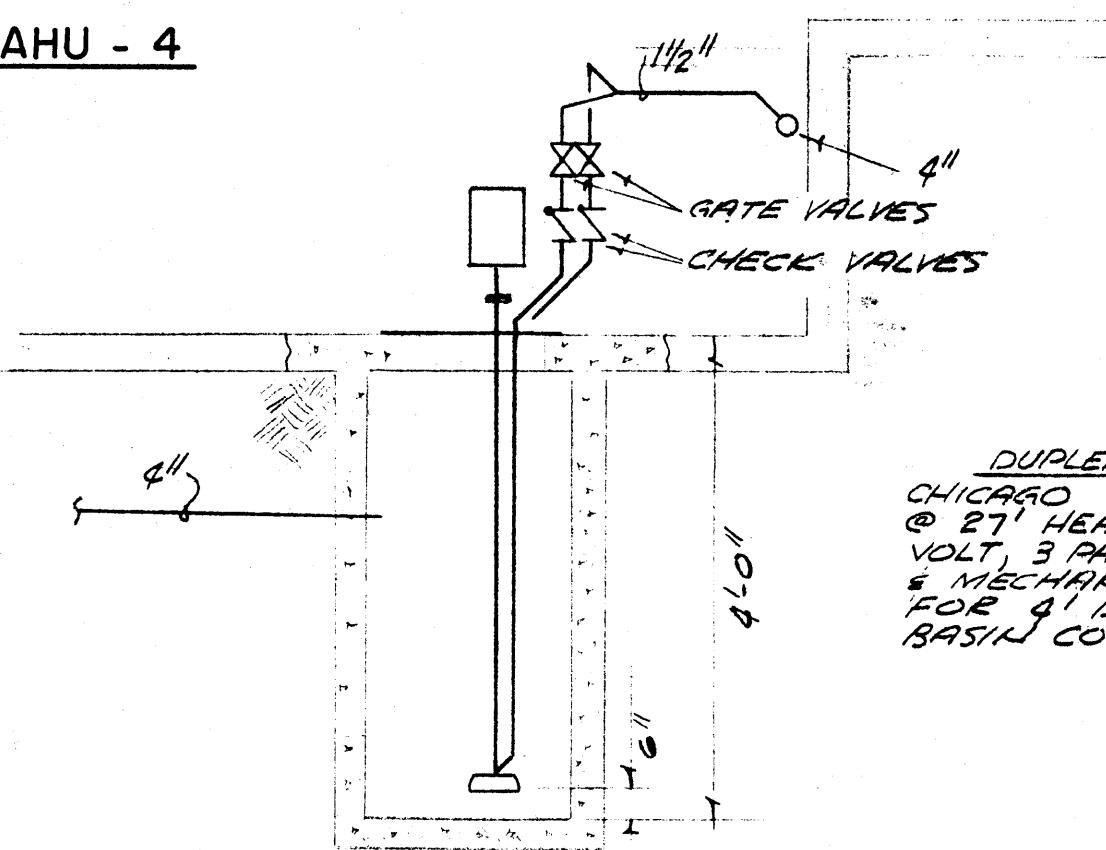


SECTION - SUMP PUMP
NO SCALE

DUPLEX SUMP PUMPS
CHICAGO DUPLEX LGL-2 20 GPM
@ 21' HEAD 1750 RPM 1/2 HP 208
VOLT 3 PHASE WITH NEMA STARTER
& MECHANICAL ALTERNATOR PUMP
FOR 4' DEEP SUMP 36" DIA C.I.
BASIN COVER W/ MANHOLE.

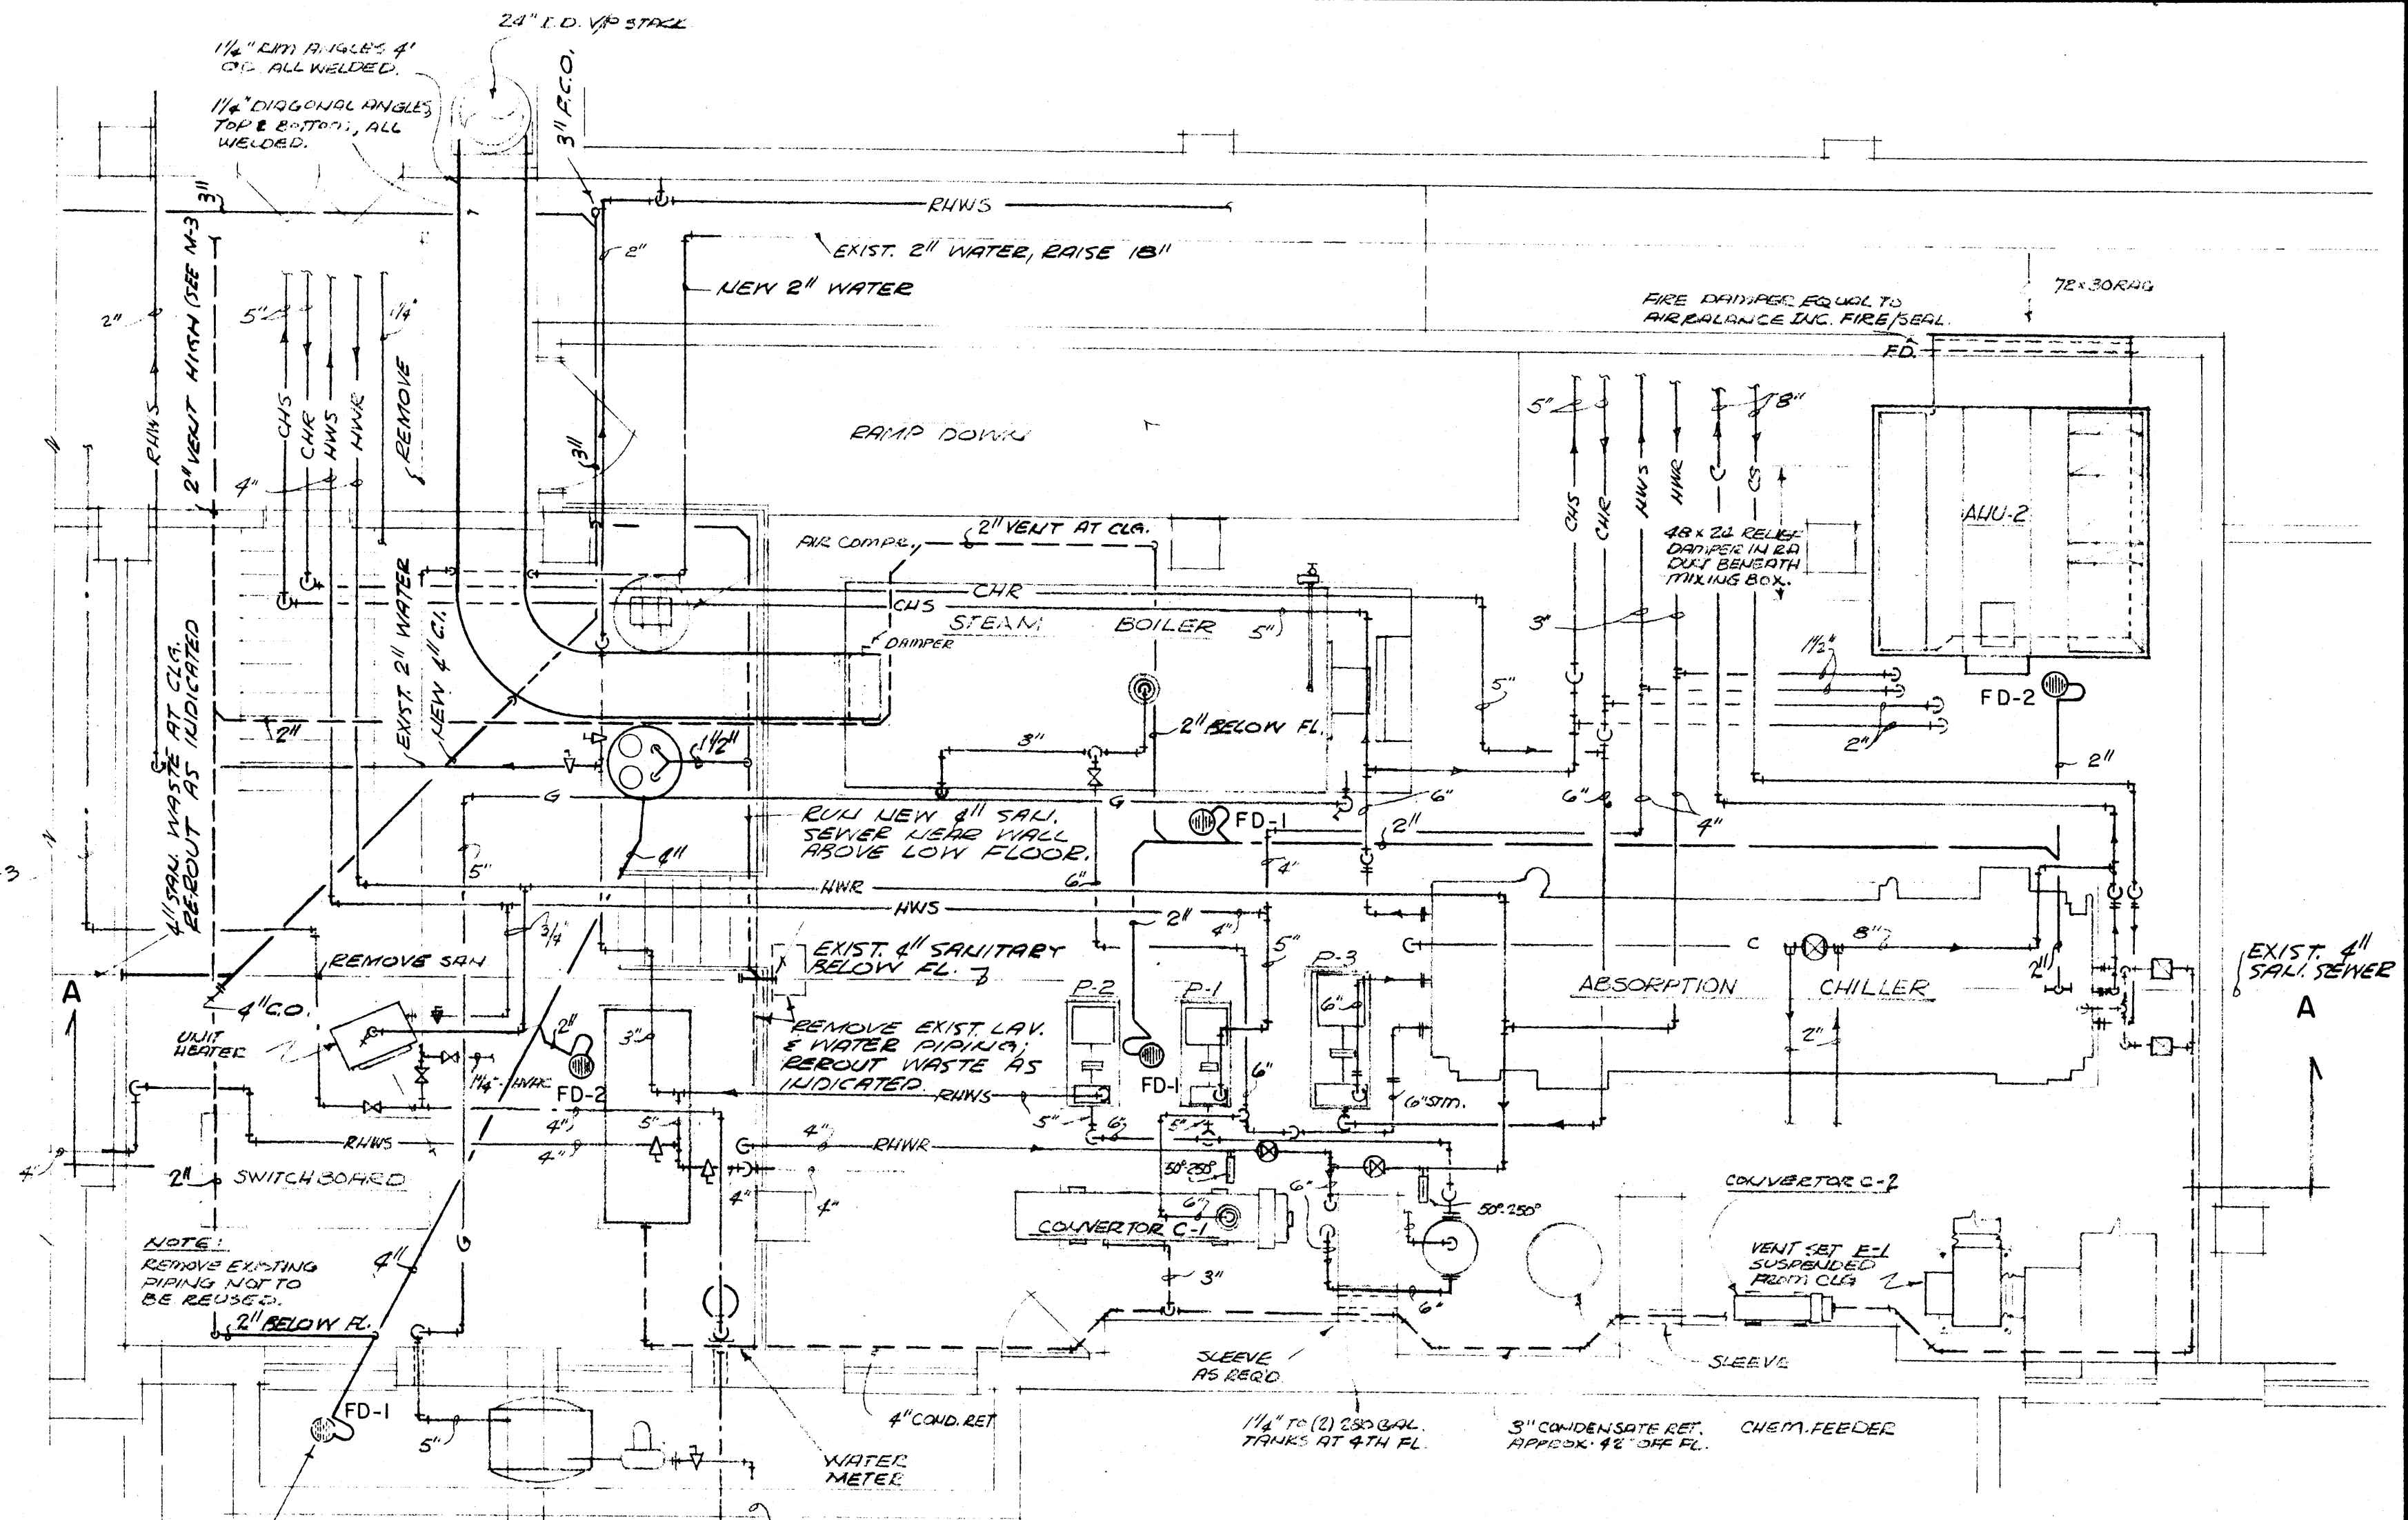


MECHANICAL EQUIPMENT ROOM 101 PLAN
SCALE 1/4" = 1'-0"

NOTE:
PLS. CONTR. WILL BREAK OUT FL.
AS REQ'D. FOR U/A WASTE PIPING.

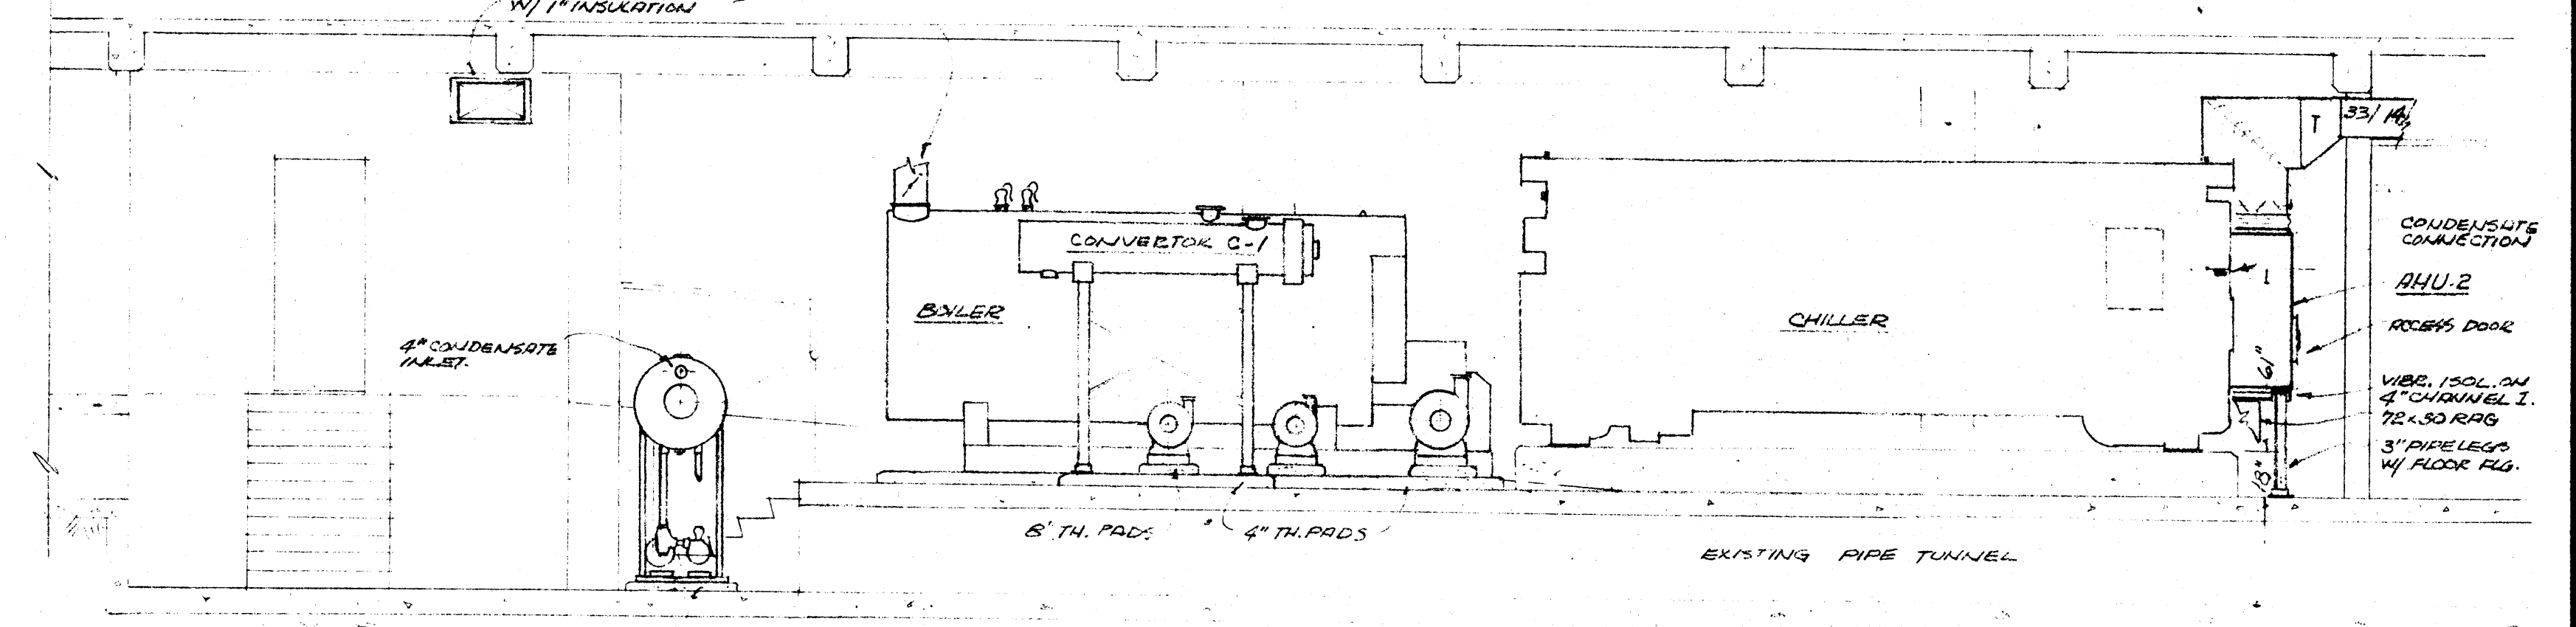

SECTION 'A-A'
SCALE 1/4" = 1'-0"

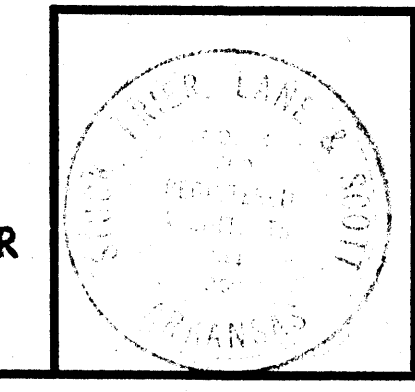


DATE	2-21-66
DRAWN BY	GBJR, RJ
CHECKED BY	
REVISIONS	

RENOVATIONS TO
WILSON HALL
ARKANSAS STATE COLLEGE
JONESBORO, ARKANSAS

STUCK, FRIER, LANE & SCOTT, INC., ARCHITECTS
601 SOUTHWEST DRIVE • JONESBORO, ARKANSAS


SHEET NUMBER
M-7
COMMISSION NUMBER
43866

NOTES:
 (1) ALL DRAIN VALVES TO BE SET IN CAST IRON VALVE BOX W/TOP MARKED "DRAIN" SET IN 12"x12" CONCRETE PAD AT GRADE.
 (2) ALL CLEANOUTS SHALL HAVE 12"x12" CONCRETE PAD AT GRADE.

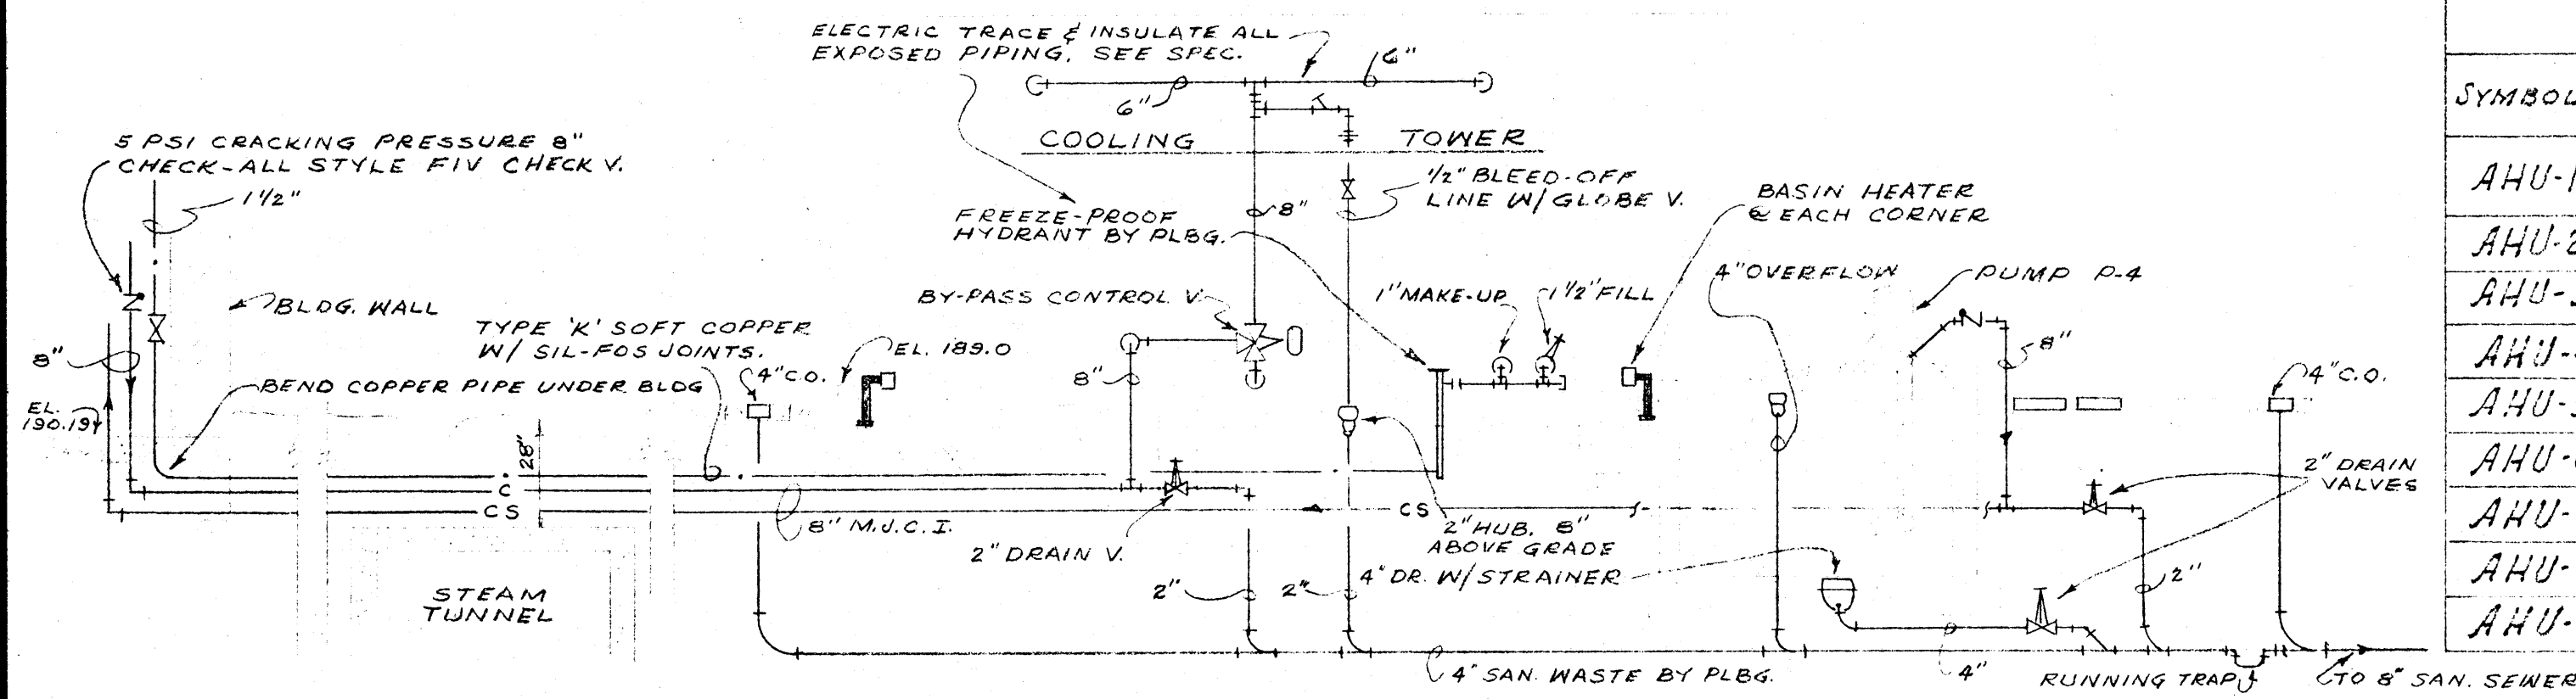


PIPING DIAGRAM - COOLING TOWER
DO NOT SCALE


SYMBOL	SERVICES	CFM		EXT. S.P.	MAX. O.V.	HP/1/2 V	STARTER	COOLING COIL @ 43° EWT					HEATING COIL @ 200° EWT			REMARKS	MFR	MODEL				
		TOTAL	MIN. O.A.					MM. EV. GPM/HR	EA	EWB	LDB	LWB	GPM	P.D.	EA				LA	M.B.H.		
AHU-1	FIRST FL. - EAST	5,665	1,000	0.5"	1,000	5/3/208	COMB. MAG. W/ PILOT LIGHT	500	47/10'	219.3	81.0	67.4	55.0	51.2	23	10'	57.5°	115°	350	SLOW-FLOW, MULTI-ZONE UNIT W/ COMBINATION FILTER & MIXING BOX.	TRANE	No. 12
AHU-2	FIRST FL. - WEST	7,920	1,200	0.5"	1,000	5/3/208	"	500	35/10'	342.8	80.6	67.1	55.0	52.9	26	10'	59°	105°	390	"	"	No. 17
AHU-3	SECOND FL. - EAST	9,720	1,500	0.5"	1,000	7 1/2/3/208	"	500	74/10'	444.4	80.6	67.1	55.0	52.1	34	10'	57°	107°	505	"	"	No. 21
AHU-4	SECOND FL. - WEST	7,745	1,500	0.5"	1,000	5/3/208	"	500	62/10'	367.4	81.3	67.9	55.0	52.2	34	10'	56.5°	117°	510	"	"	No. 17
AHU-5	THIRD FL. - EAST	10,030	1,500	0.5"	1,000	7 1/2/3/208	"	500	80/10'	480.4	80.6	67.1	55.0	51.1	35	10'	59.5°	107°	515	"	"	No. 21
AHU-6	THIRD FL. - WEST	9,355	1,500	0.5"	1,000	7 1/2/3/208	"	500	75/10'	452.4	80.7	67.2	55.0	51.1	34	10'	59°	107°	50.5	"	"	No. 21
AHU-7	FOURTH FL. - EAST	17,285	3,000	0.6"	1,000	10/3/208	"	500	154/10'	836.8	80.9	67.3	55.0	50.3	50	10'	58°	97°	730	"	"	No. 35
AHU-8	FOURTH FL. - WEST	17,780	3,000	0.6"	1,000	10/3/208	"	500	161/10'	819.8	80.9	67.3	55.0	50.3	51	10'	58°	97°	750	"	"	No. 35
AHU-9	STAGE	4,570	800	0.35"	1,800	3/3/208	"	500	31/10'	186.0	79.8	66.4	55.0	53.3	14	10'	58°	101°	213	DEAN-FLOW, SINGLE ZONE, HORIZONTAL, 515CM UNIT W/ V. FILTER BOX	"	No. 10

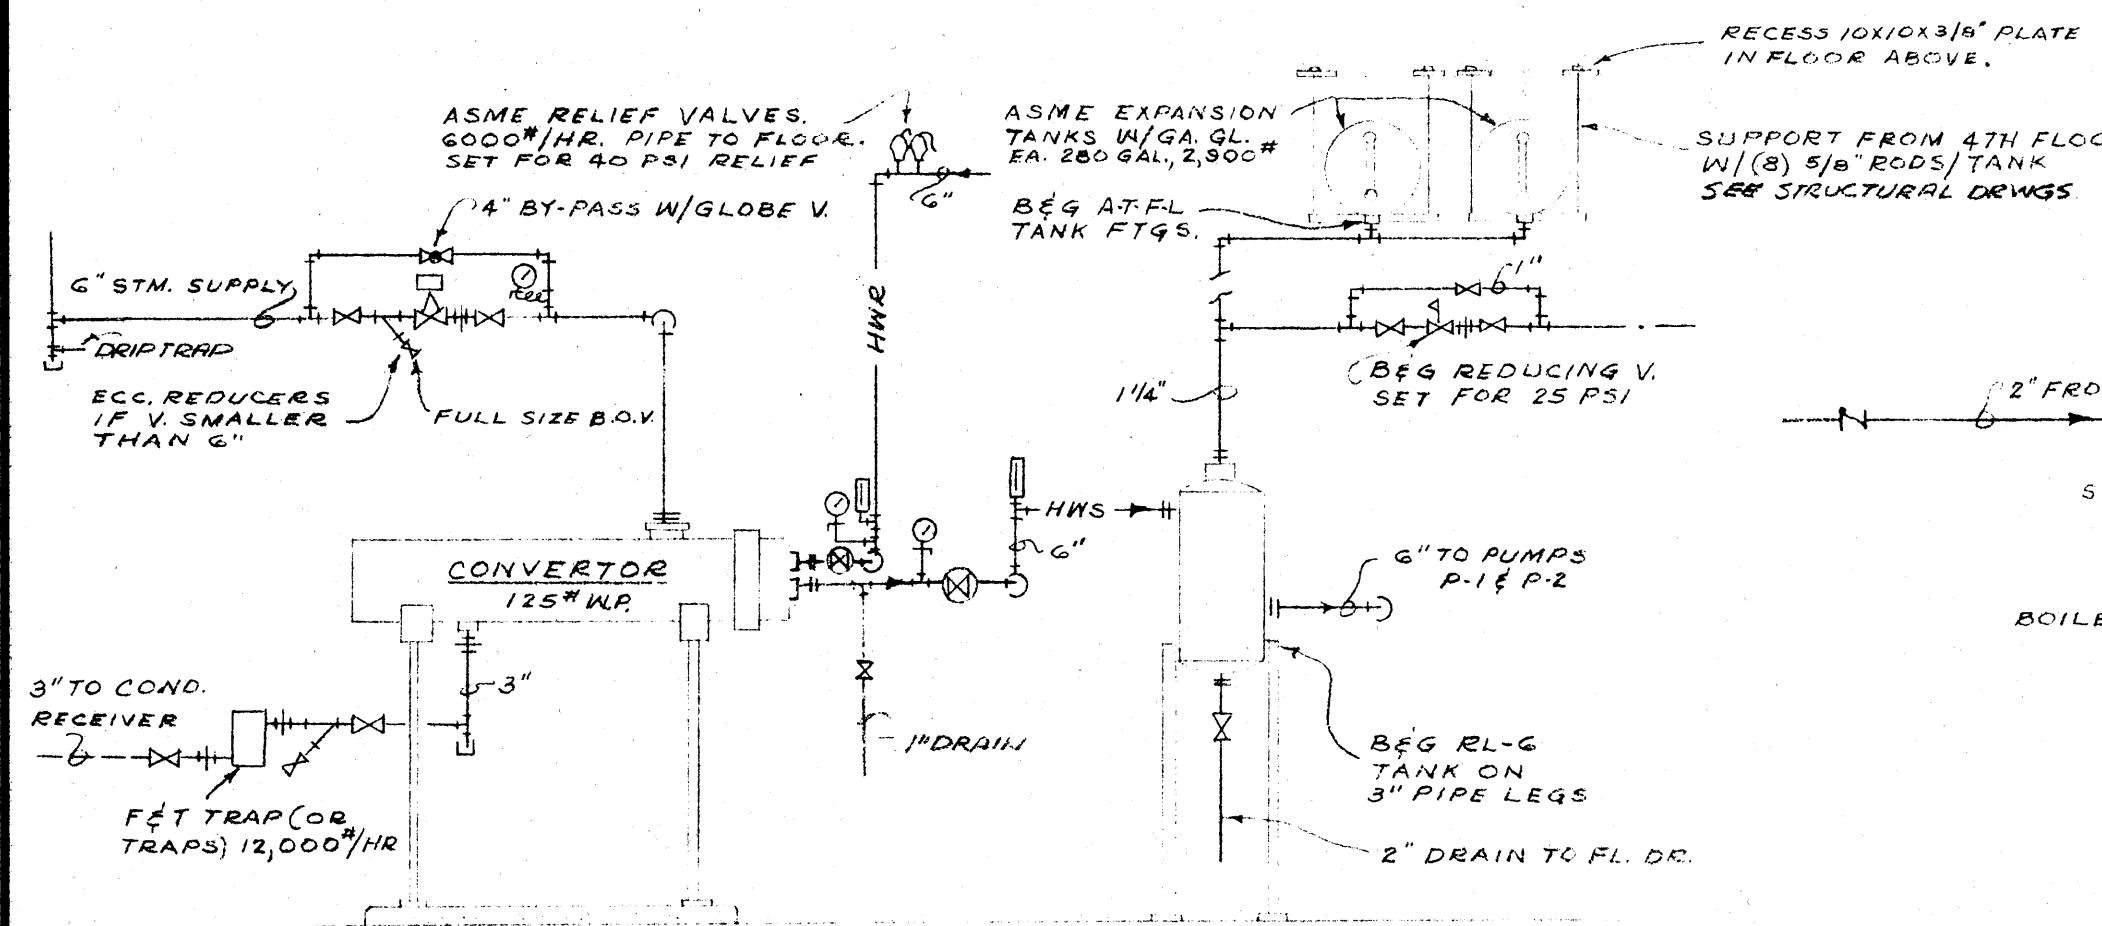

PIPING DIAGRAM - CONVERTOR C-1
DO NOT SCALE

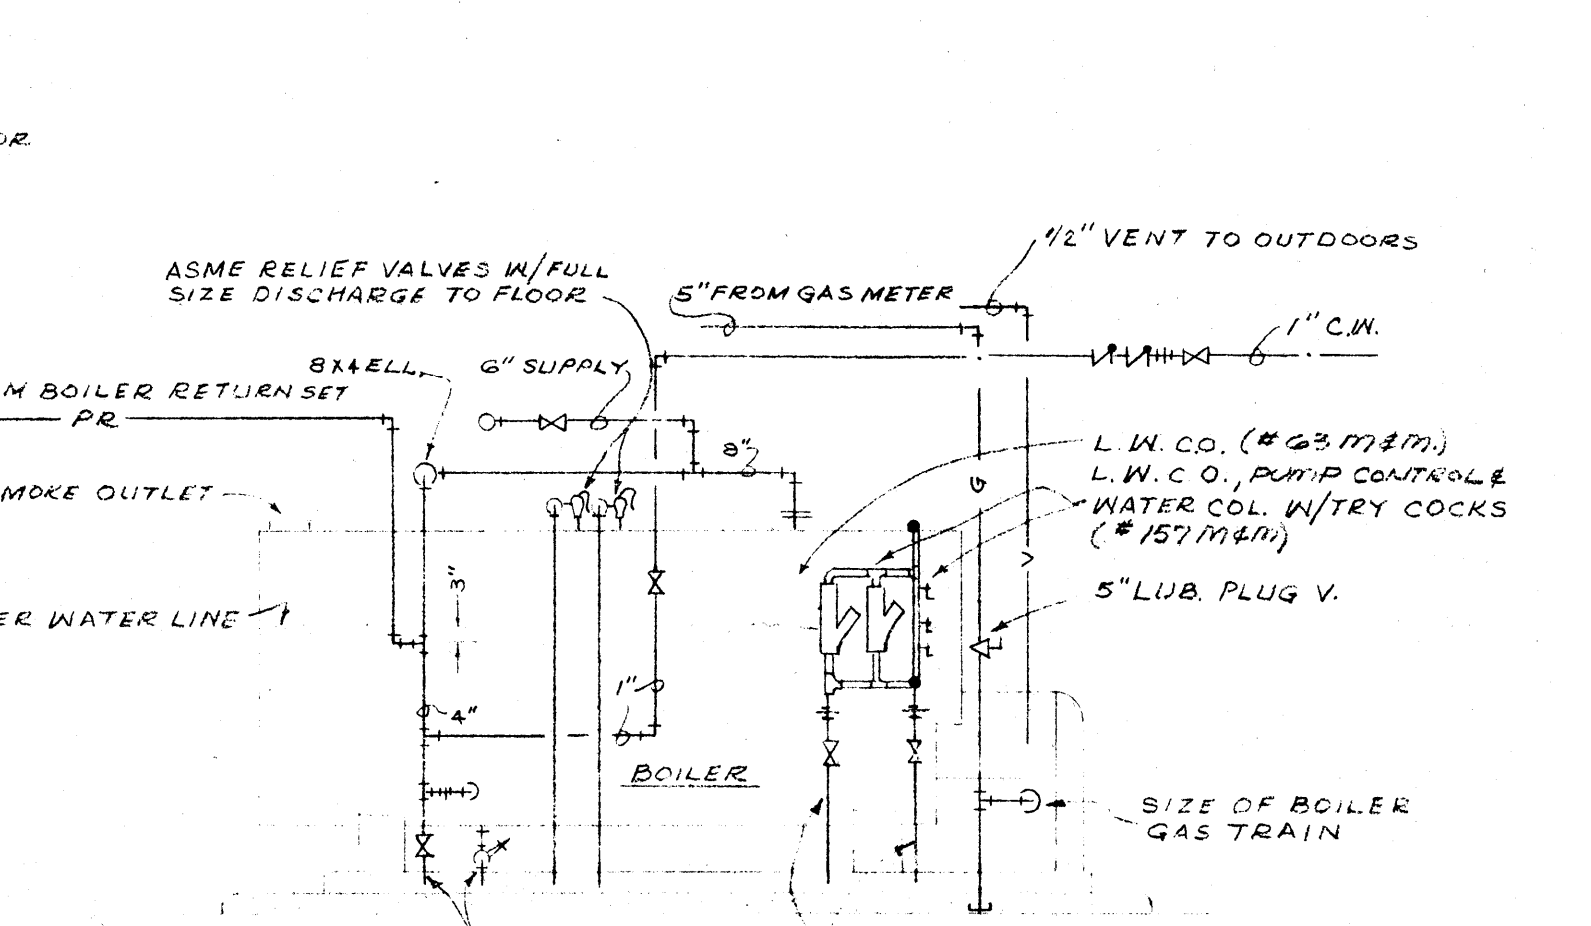

PIPING DIAGRAM - BOILER
DO NOT SCALE

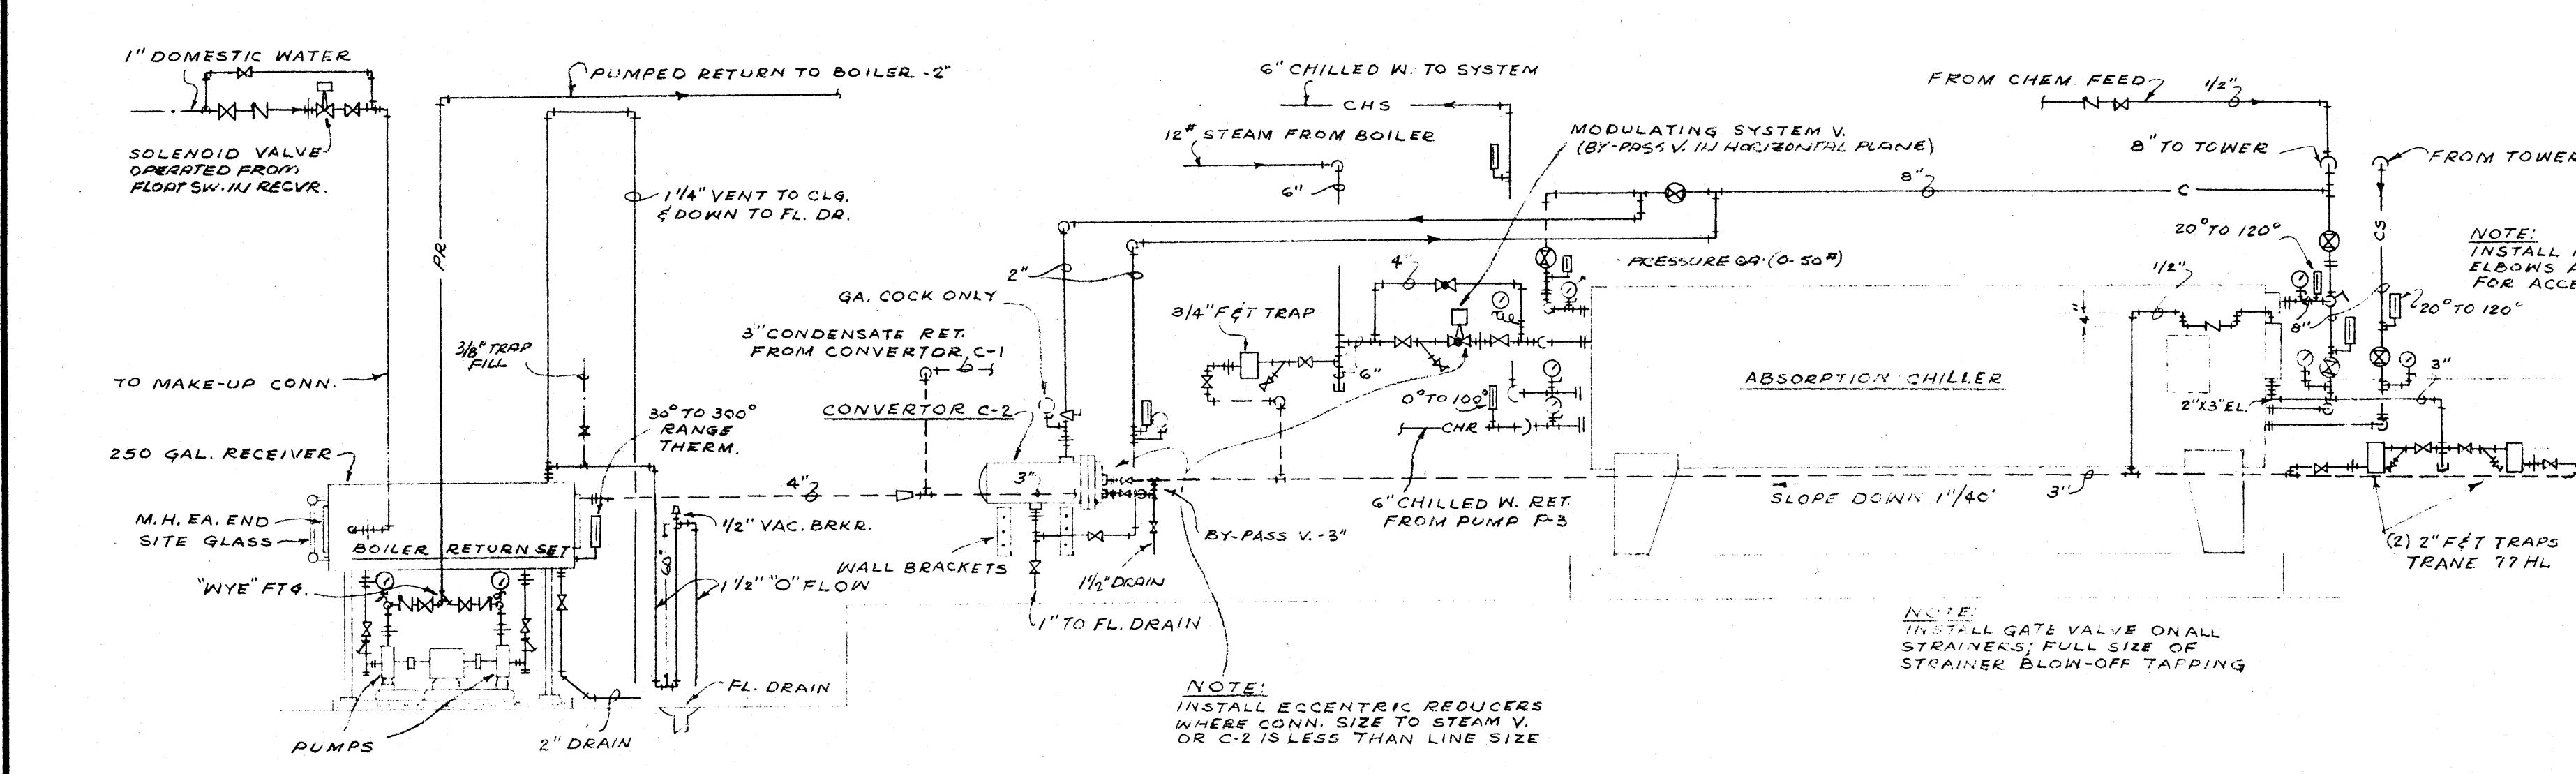

PIPING DIAGRAM - CHILLER & BOILER RETURN SET
DO NOT SCALE

AIR HANDLING UNITS

CHILLER

TYPE	STEAM PRESS.	STEAM CONSUMPT.	TONS REFRIG.	COOLER		ABS CONDENSER			ELEC.	OPR. WT.	MFR.	MODEL		
				LVG. W.	GPM	PD	ENT. W.	GPM					PD	LVG. W.
STEAM ABSORPTION	12 PSIG	6,000/HR	300	42°	720	32'	85°	112.5	15'	102.1	(3) SHRT/1/2HP 208V/3Ø	31,000#	TRANE	A3B

COOLING TOWER

TYPE	GPM	WB	WATER ON	WATER OFF	REMARKS	MOTOR	STARTER	BASEIN	MFR.	MODEL
WOOD DOUBLE-FLOW	1125	78°	103°	85°		208V/3Ø	25 HP	CONC. MAG. W/ HCA.	CONCRETE	MARLEY 355-101

PUMPS

SYMBOL	SERVICE	MIN. EFF.	GPM	HEAD-FT.	RPM	MOTOR	STARTER	REMARKS	MFR.	MODEL
P-1	HOT WATER AHU COILS	75%	300	55'	1750	7 1/2 HP	COMB. MAG. W/ PILOT		BUFFALO	3X4 CM
P-2	HOT WATER RADIATION	67%	320	70'	1750	10HP	"		"	3X4 CL
P-3	CHILLED WATER CONDENSER WATER	75%	720	90'	1750	25HP	"		"	5X6 CM
P-4			1125	90'	1750	40HP	"	VERTICAL TYPE W/ MFG. PLATE, M.H., FOR 5' SUPP.	"	6 CLV

BOILER

TYPE	MAX. STEAM W.P.	OUTPUT	INPUT (NAT. GAS)	HEATING SURF	HP/1/2 V	MFR.	MODEL
SCOTCH	15 PSI	6,695 MBH	8,370 CFH	1,000 SQ. FT.	7 1/2/3/208	KEWANEE	No. 200

CONVERTORS


SYMBOL	MOUNTING	GRM	TUBE SIDE		SHELL SIDE	STEAM TRAP CAP.	MFR.
			P.D.	L.W.			
C-1	PIPE STAND	620	10'	180°	200°	0 PSI STM	PK-18-102
C-2	SHELF BRACKET	12	0.05'	240°	200°	24GPM, ENT. 95° LV. 9.15", 5' F.O.	PK-8-40

FANS


SYMBOL	SERVICE	TYPE	DRIVE	CFM	S.P. (W.G.)	MAX. T.S.	R.P.M.	MOTOR	STARTER	REMARKS	MFR.	MODEL
EF-1	TOILETS - EAST	CENTRIFUGAL ROOF MTD.	BELT	1,830	1/2"	5000	1040	1/2HP, 3Ø, 208V	MANUAL STARTER W/ PILOT LT.	NEW ROOF CPG. REQ'D.	PENN.	CB-801
EF-2	TOILETS - WEST	"	"	1,130	1/2"	5000	1235	1/2HP, 1Ø, 120V	"	"	"	BB-45
F-3	BOILER ROOM	CENTRIFUGAL VENT. SET	DIRECT	2,800	3/8"	3600	690	1/2 HP, 1Ø, 120V	"	SUSPEND ON PLYWOOD (1") PLATFORM W/ VIBR. ISOL.	FEERLESS	D 200 C

CONVERTORS: (4) REQ'D. TRANE TYPE SFK, 17.8 MBH @ 190° EWT, 10" O.D. x 38" H x 64" L. SEE SPEC.
 UNIT HEATER: (1) REQ'D. TRANE 100-S, 6.8 MBH @ 200° EWT, 6.3 GPM, 1535 CFM, 1/8 HP.


	DATE	2-21-66	RENOVATIONS TO WILSON HALL ARKANSAS STATE COLLEGE JONESBORO, ARKANSAS	SHEET NUMBER	M-8 COMMISSION NUMBER 45806
	DRAWN BY	JT, JG			
	CHECKED BY				
	REVISIONS				
Office of GRIFFITH C. BURR CONSULTING ENGINEERS MEMPHIS, TENNESSEE			STUCK, FRIER, LANE & SCOTT, INC., ARCHITECTS 601 SOUTHWEST DRIVE • JONESBORO, ARKANSAS		

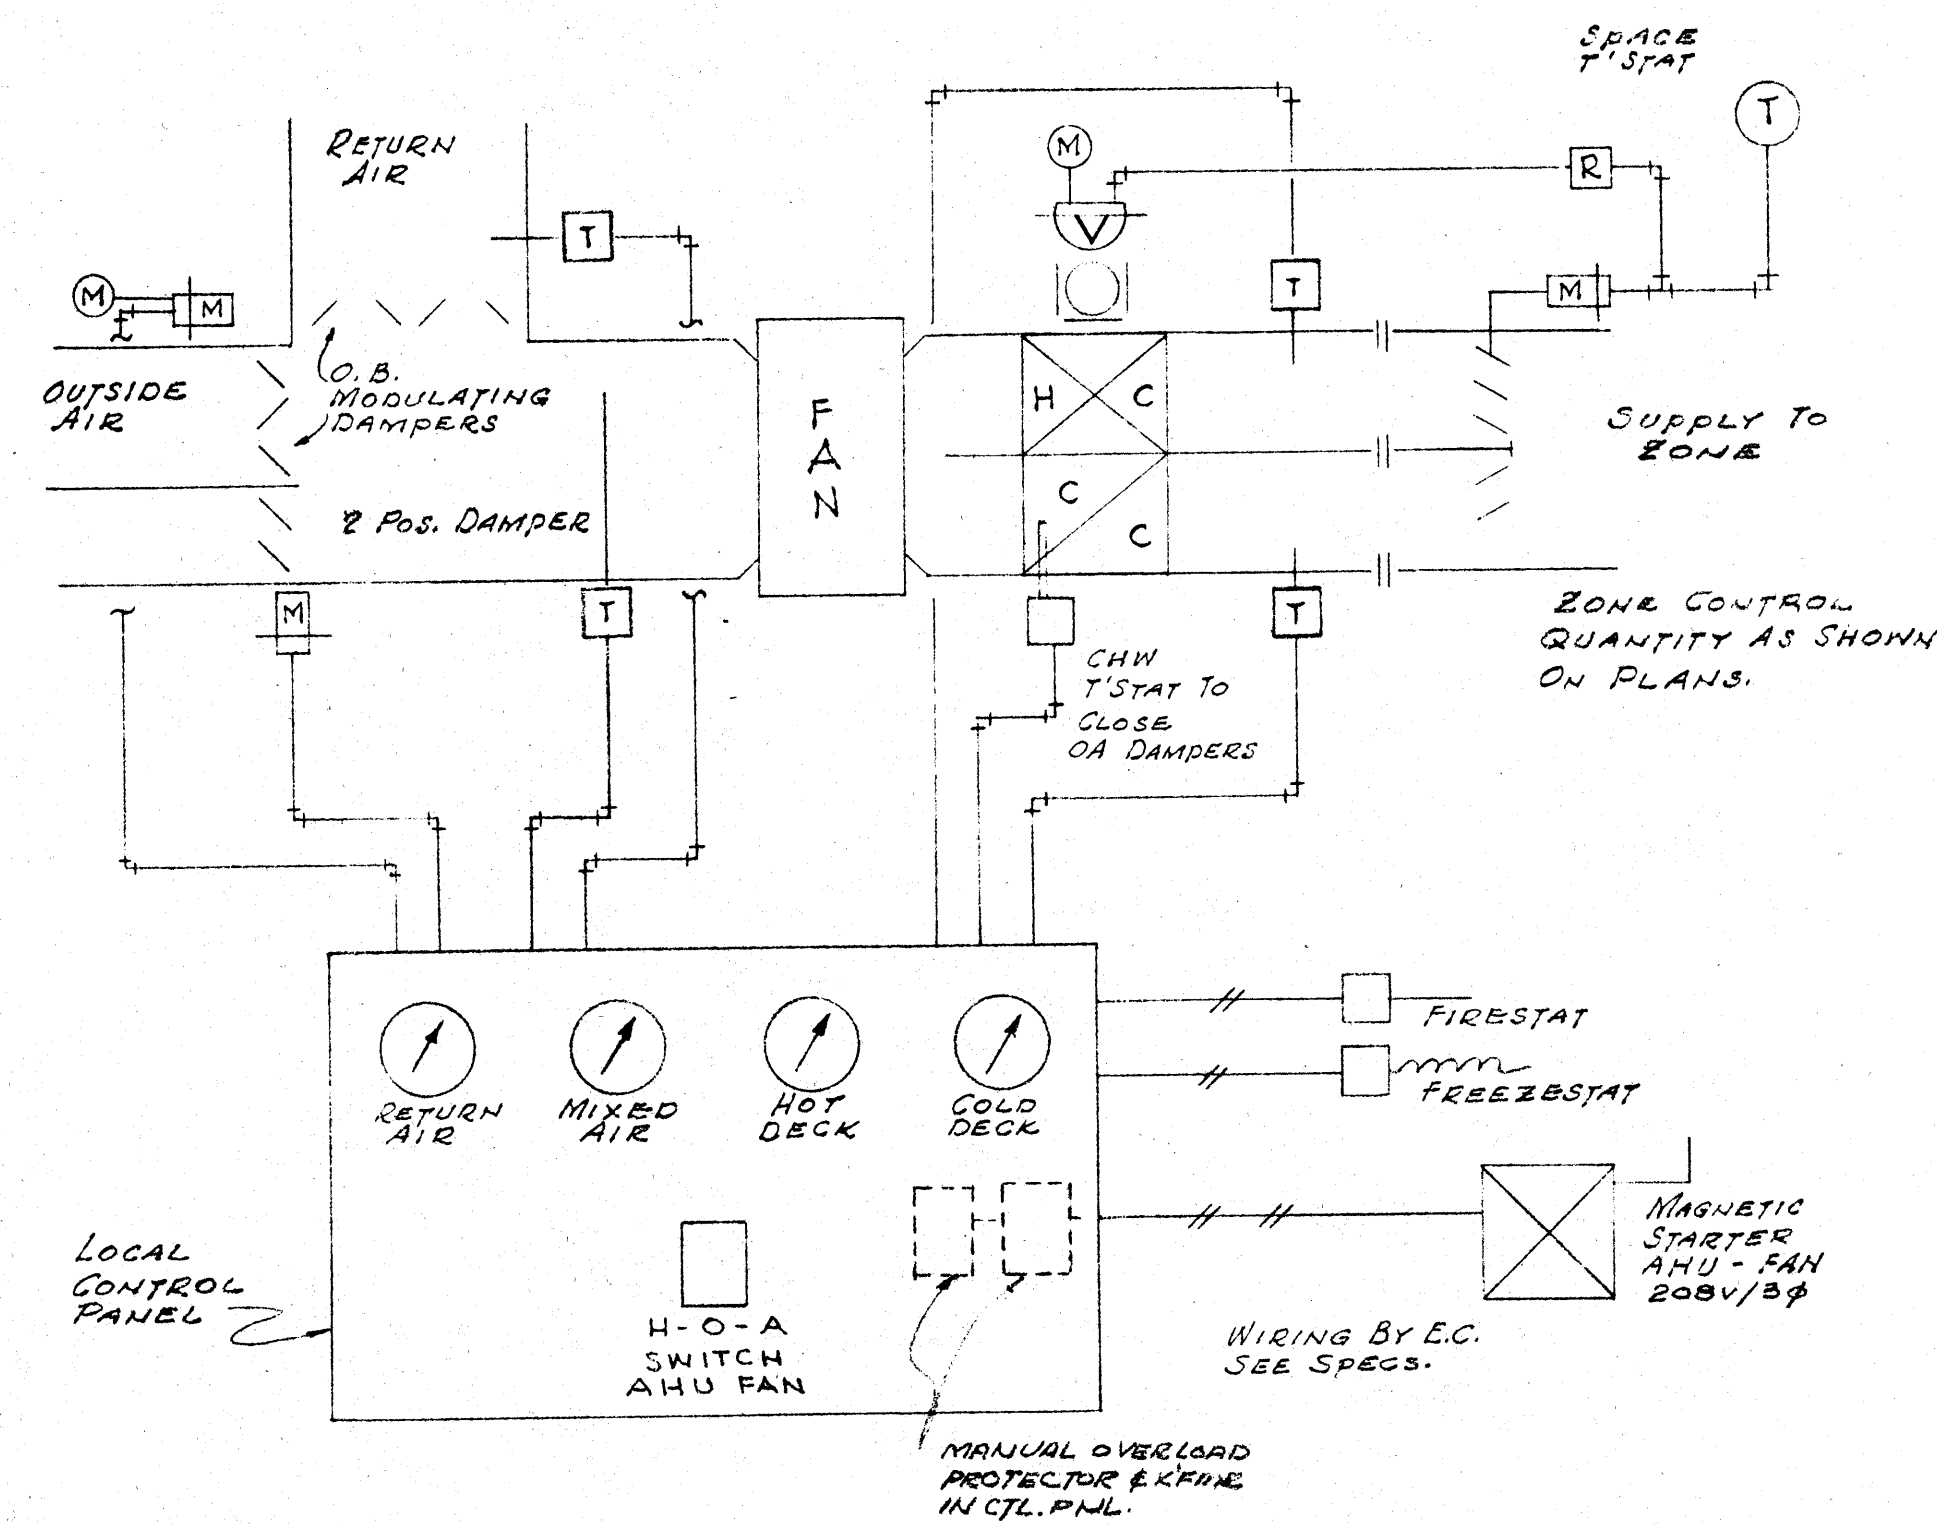


MULTI-ZONE UNITS - (8) REQ'D

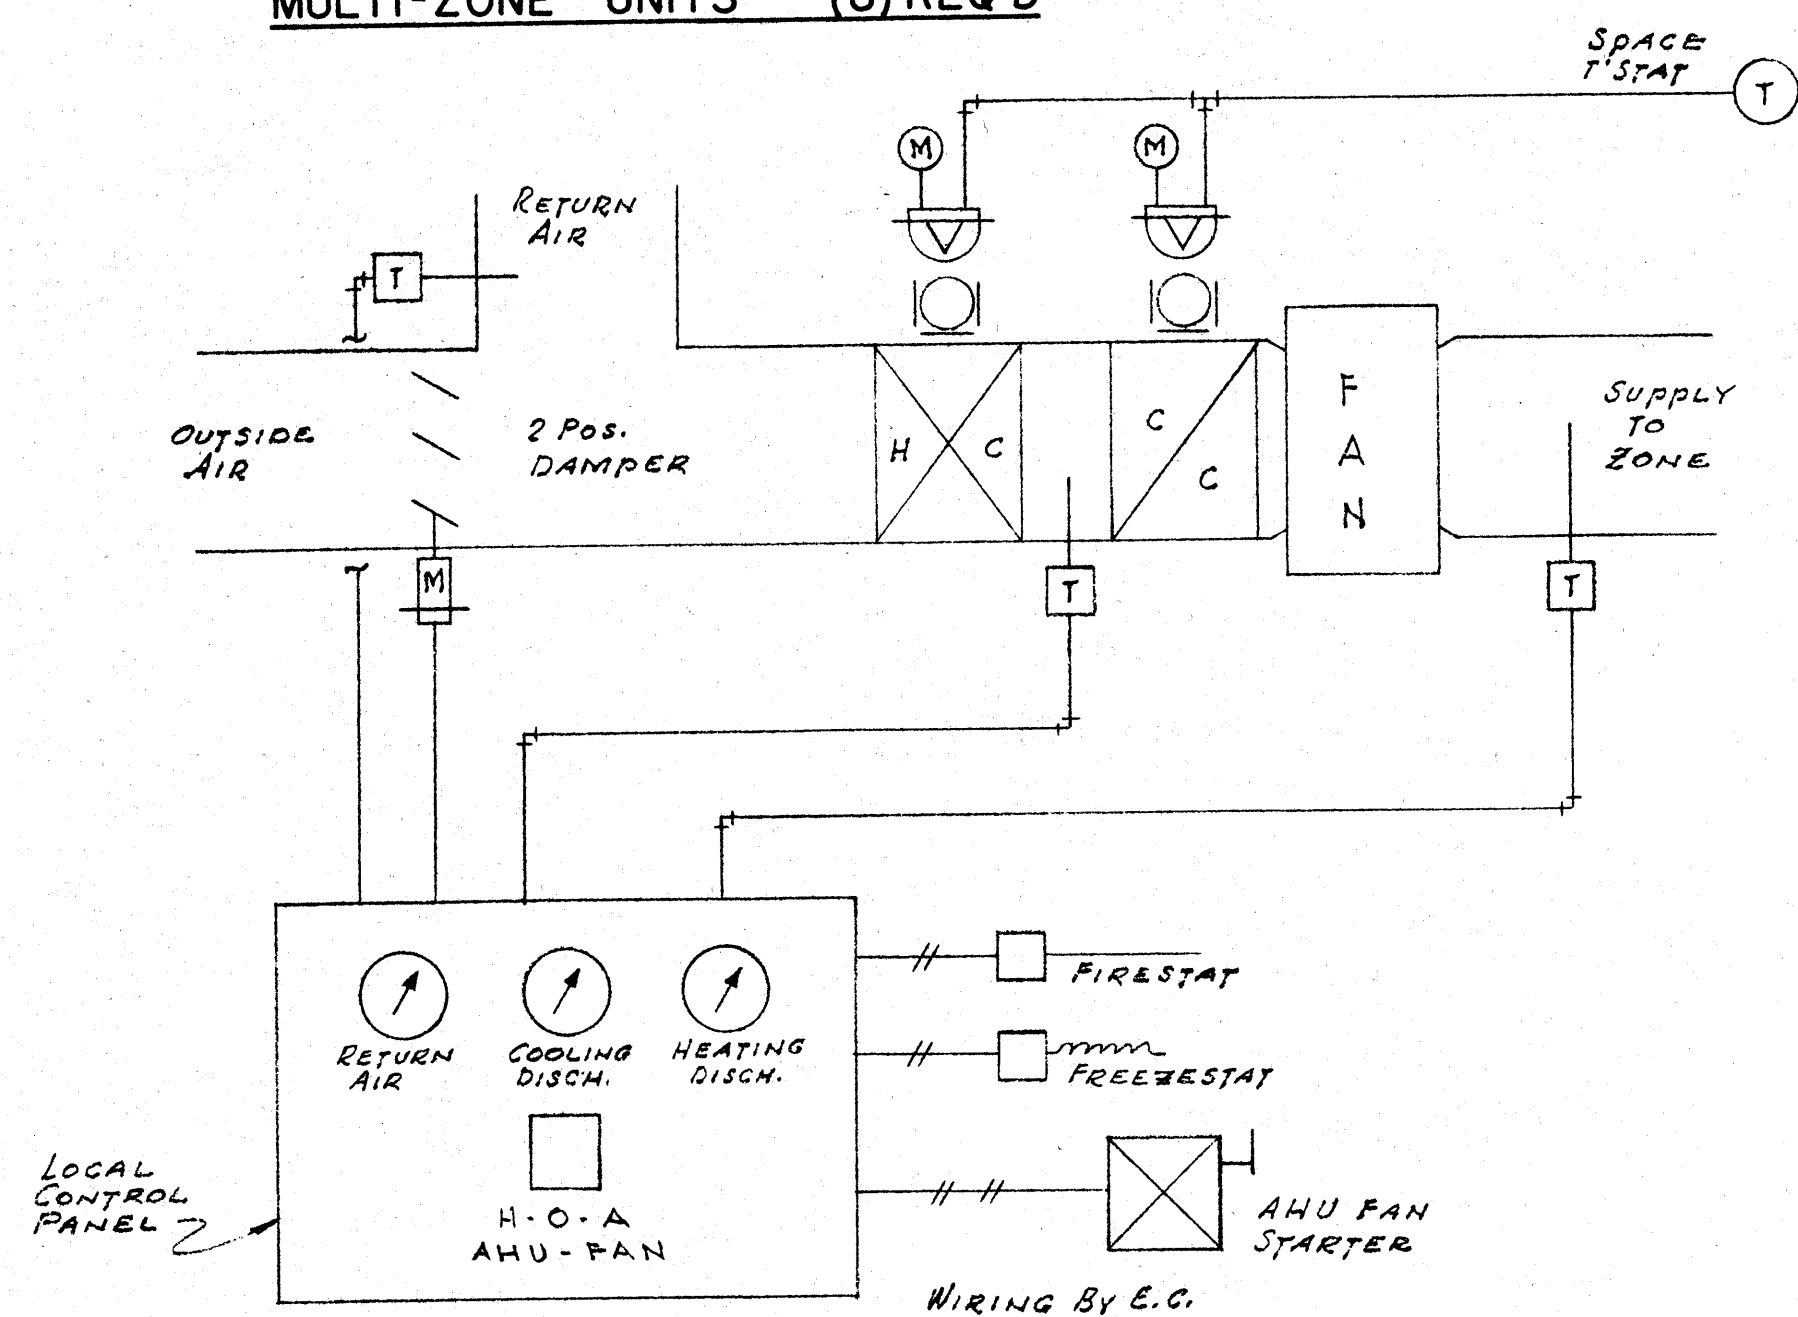


SINGLE ZONE UNIT - (1) REQ'D

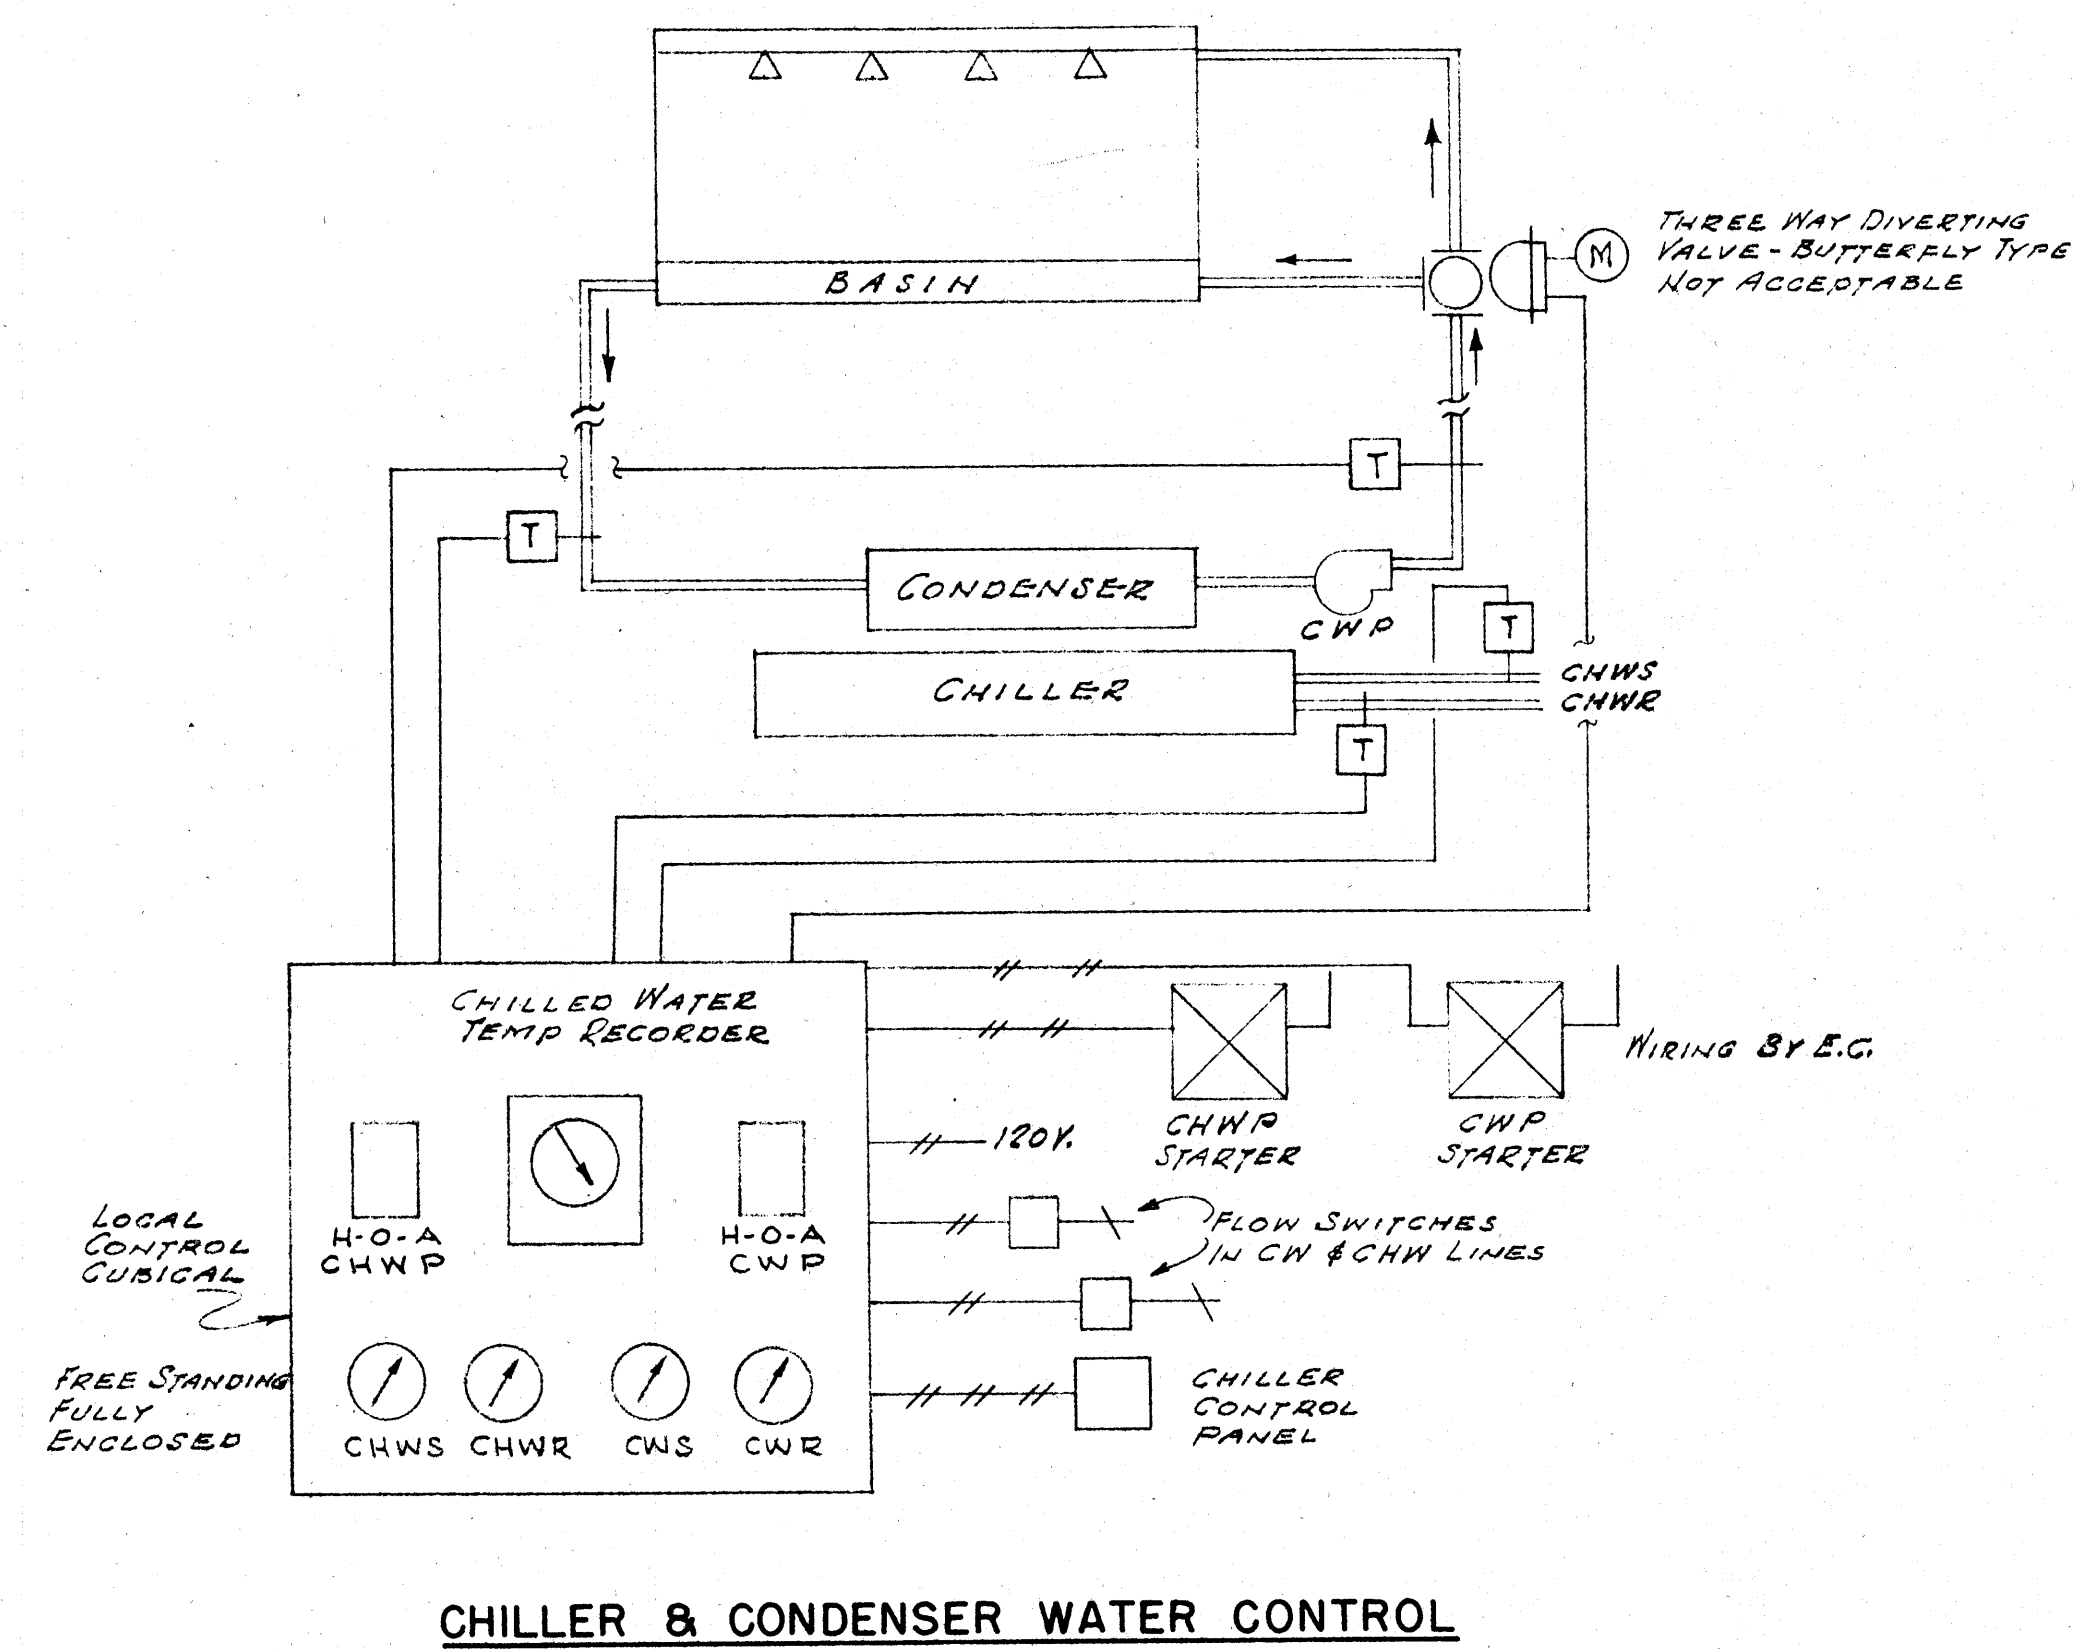


CHILLER & CONDENSER WATER CONTROL

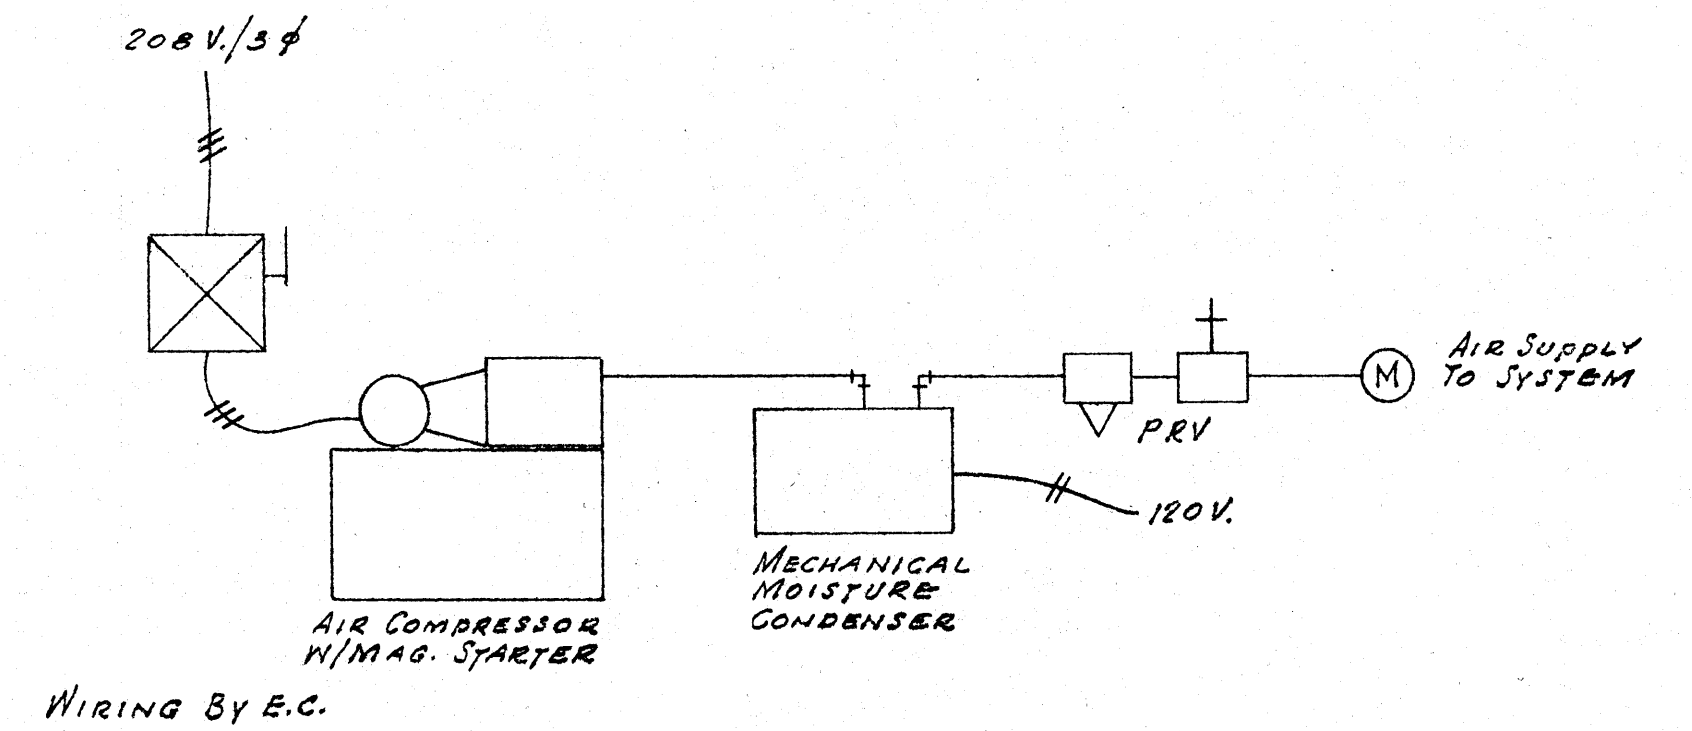

TEMPERATURE CONTROL AIR SUPPLY

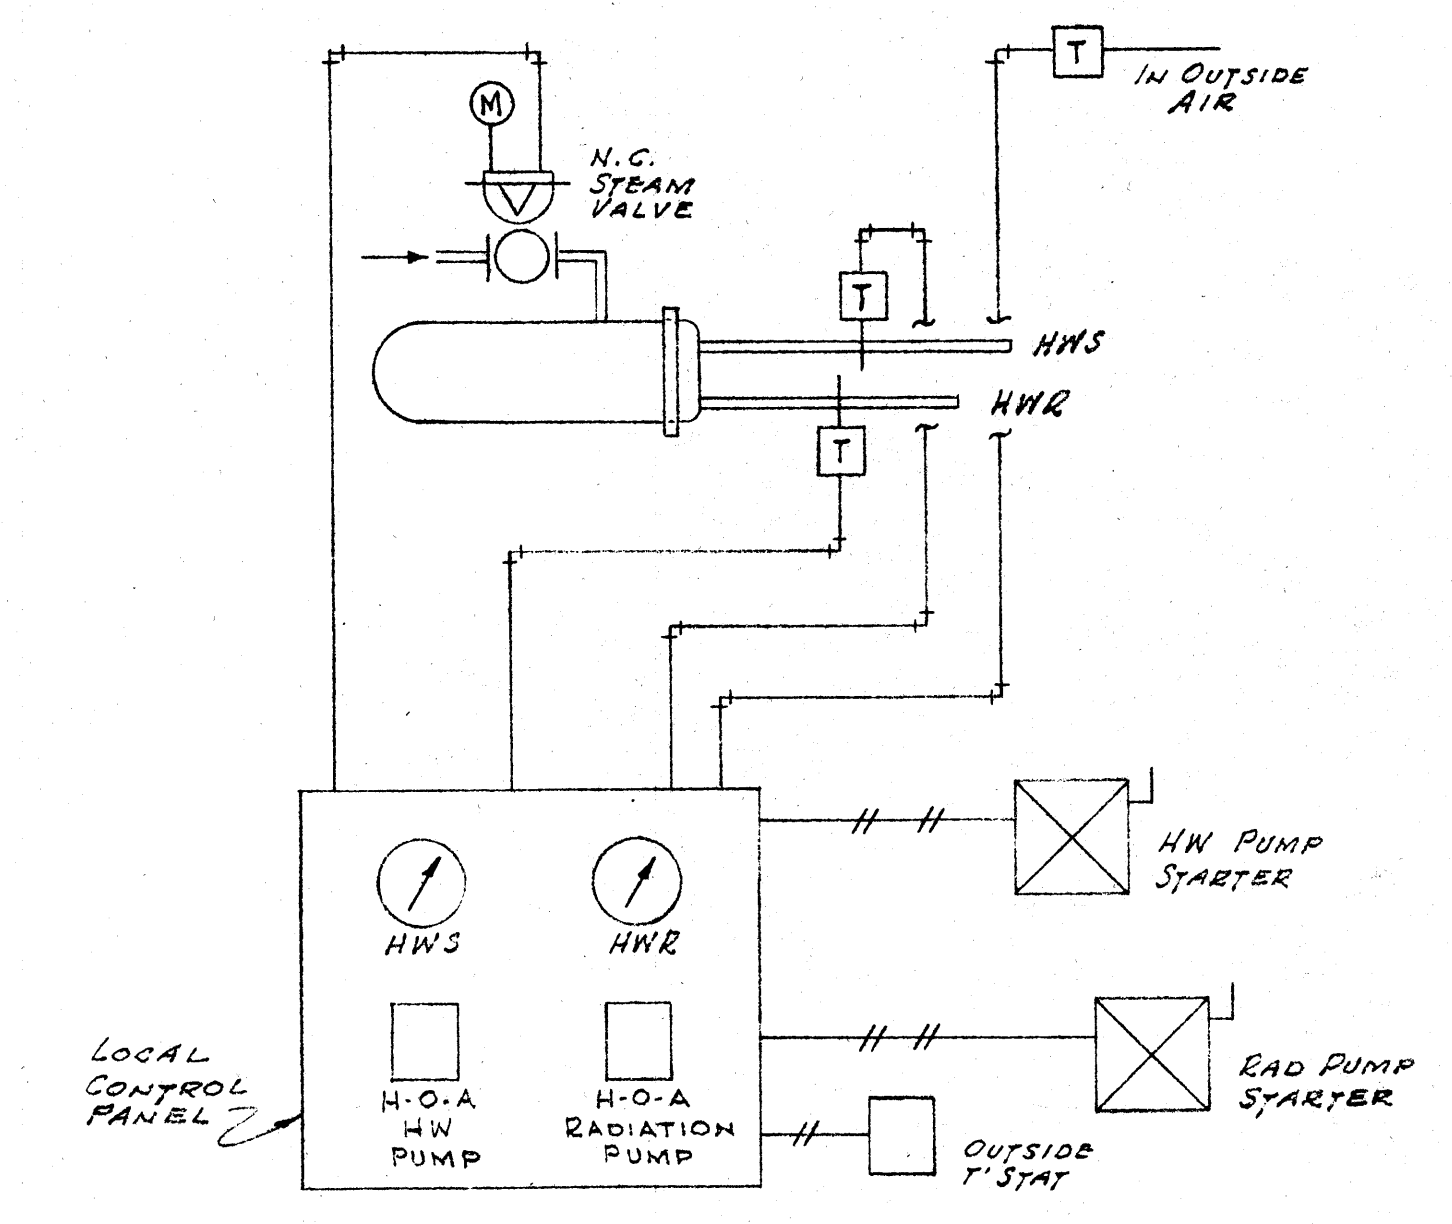

HOT WATER CONVERTOR & RADIATION PUMP

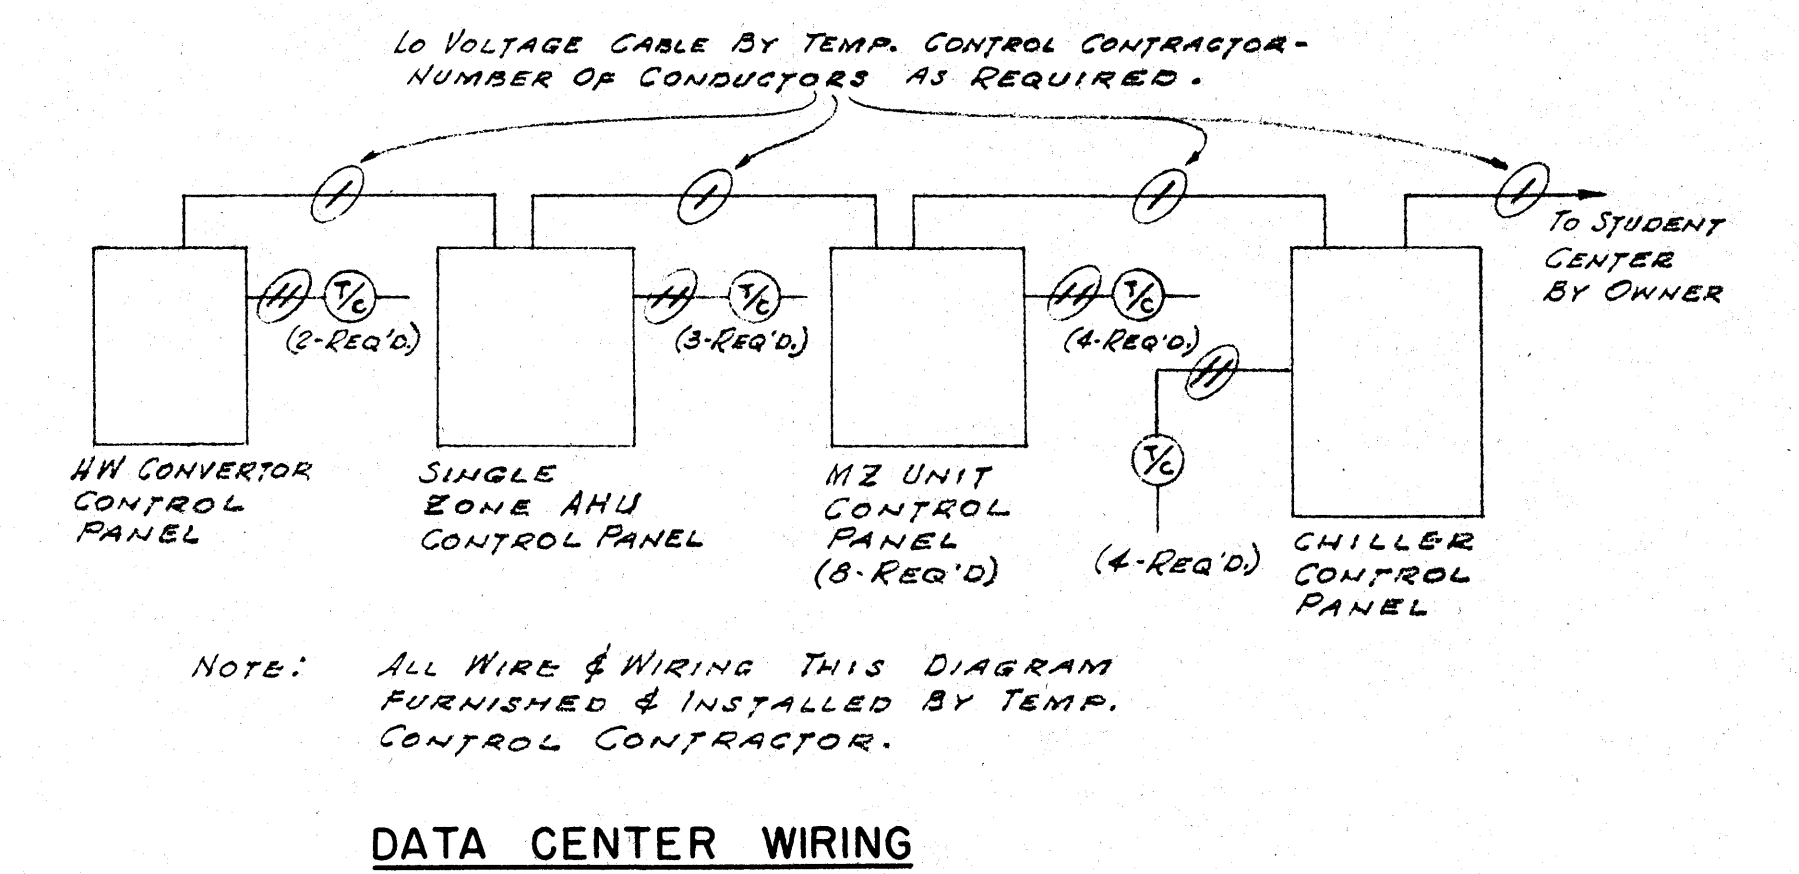


DATA CENTER WIRING

LEGEND

- PNEUMATIC TUBING
- WIRING BY E.C.
- WIRING BY TEMP. CONTROL CONTRACTOR
- THERMOCOUPLE
- TAMPER-PROOF NON-ADJUSTABLE TEMP. TRANSMITTER
- PNEU. DAMPER MOTOR WITH POSITIONER (SEE SPECS)
- PNEU. VALVE MOTOR WITH POSITIONER.

TEMPERATURE CONTROL DIAGRAMS

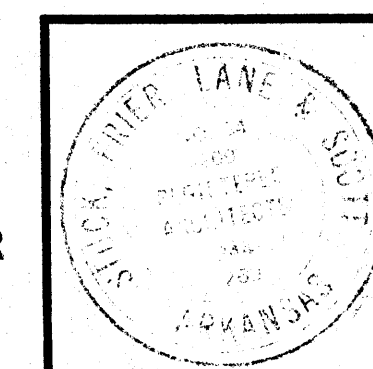


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2-21-66
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RP, JQ, JT
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RENOVATIONS TO
WILSON HALL
ARKANSAS STATE COLLEGE
JONESBORO, ARKANSAS
STUCK, FRIER, LANE & SCOTT, INC., ARCHITECTS
601 SOUTHWEST DRIVE • JONESBORO, ARKANSAS

SHEET NUMBER
M-9
COMMISSION NUMBER
45800

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MEMPHIS, TENNESSEE


NOTE:
INSULATE EXTERIOR W/1"
P.C. (IN ADDITION TO
1" INSUL. COVER W/ GLASS
FIBER WEATHER PROOF W/
ASPHALTUM. SLOPE W/1"

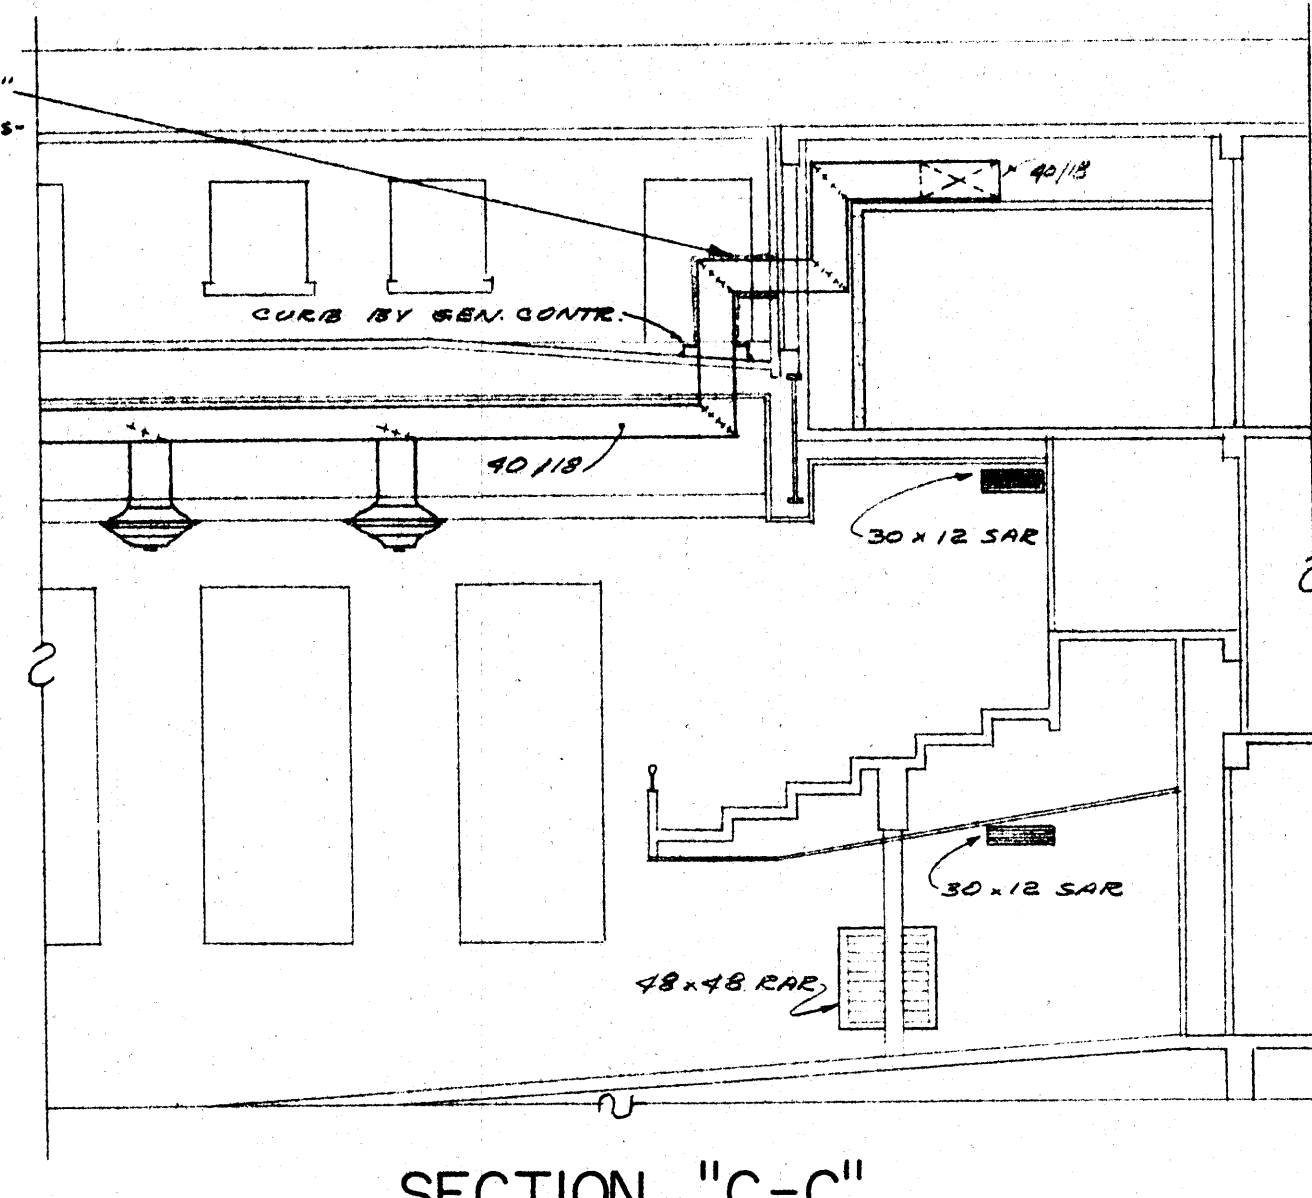


SECTION "C-C"
SCALE 1/8" = 1'-0"

NOTE:
UNDER ALTERNATE BID SUBFEED C.T.
S-36 SHALL CONNECT TO EXISTING
STAGE & AUDITORIUM LIGHTING
PANEL (E00A). FEEDER SHALL
BE OF TYPE SPECIFIED IN BASE BID.

NOTE:
UNDER AUDITORIUM ALTERNATE
BID ALL LIGHTING & POWER
IN AUDITORIUM & STAGE SHALL
BE KEPT IN SERVICE.

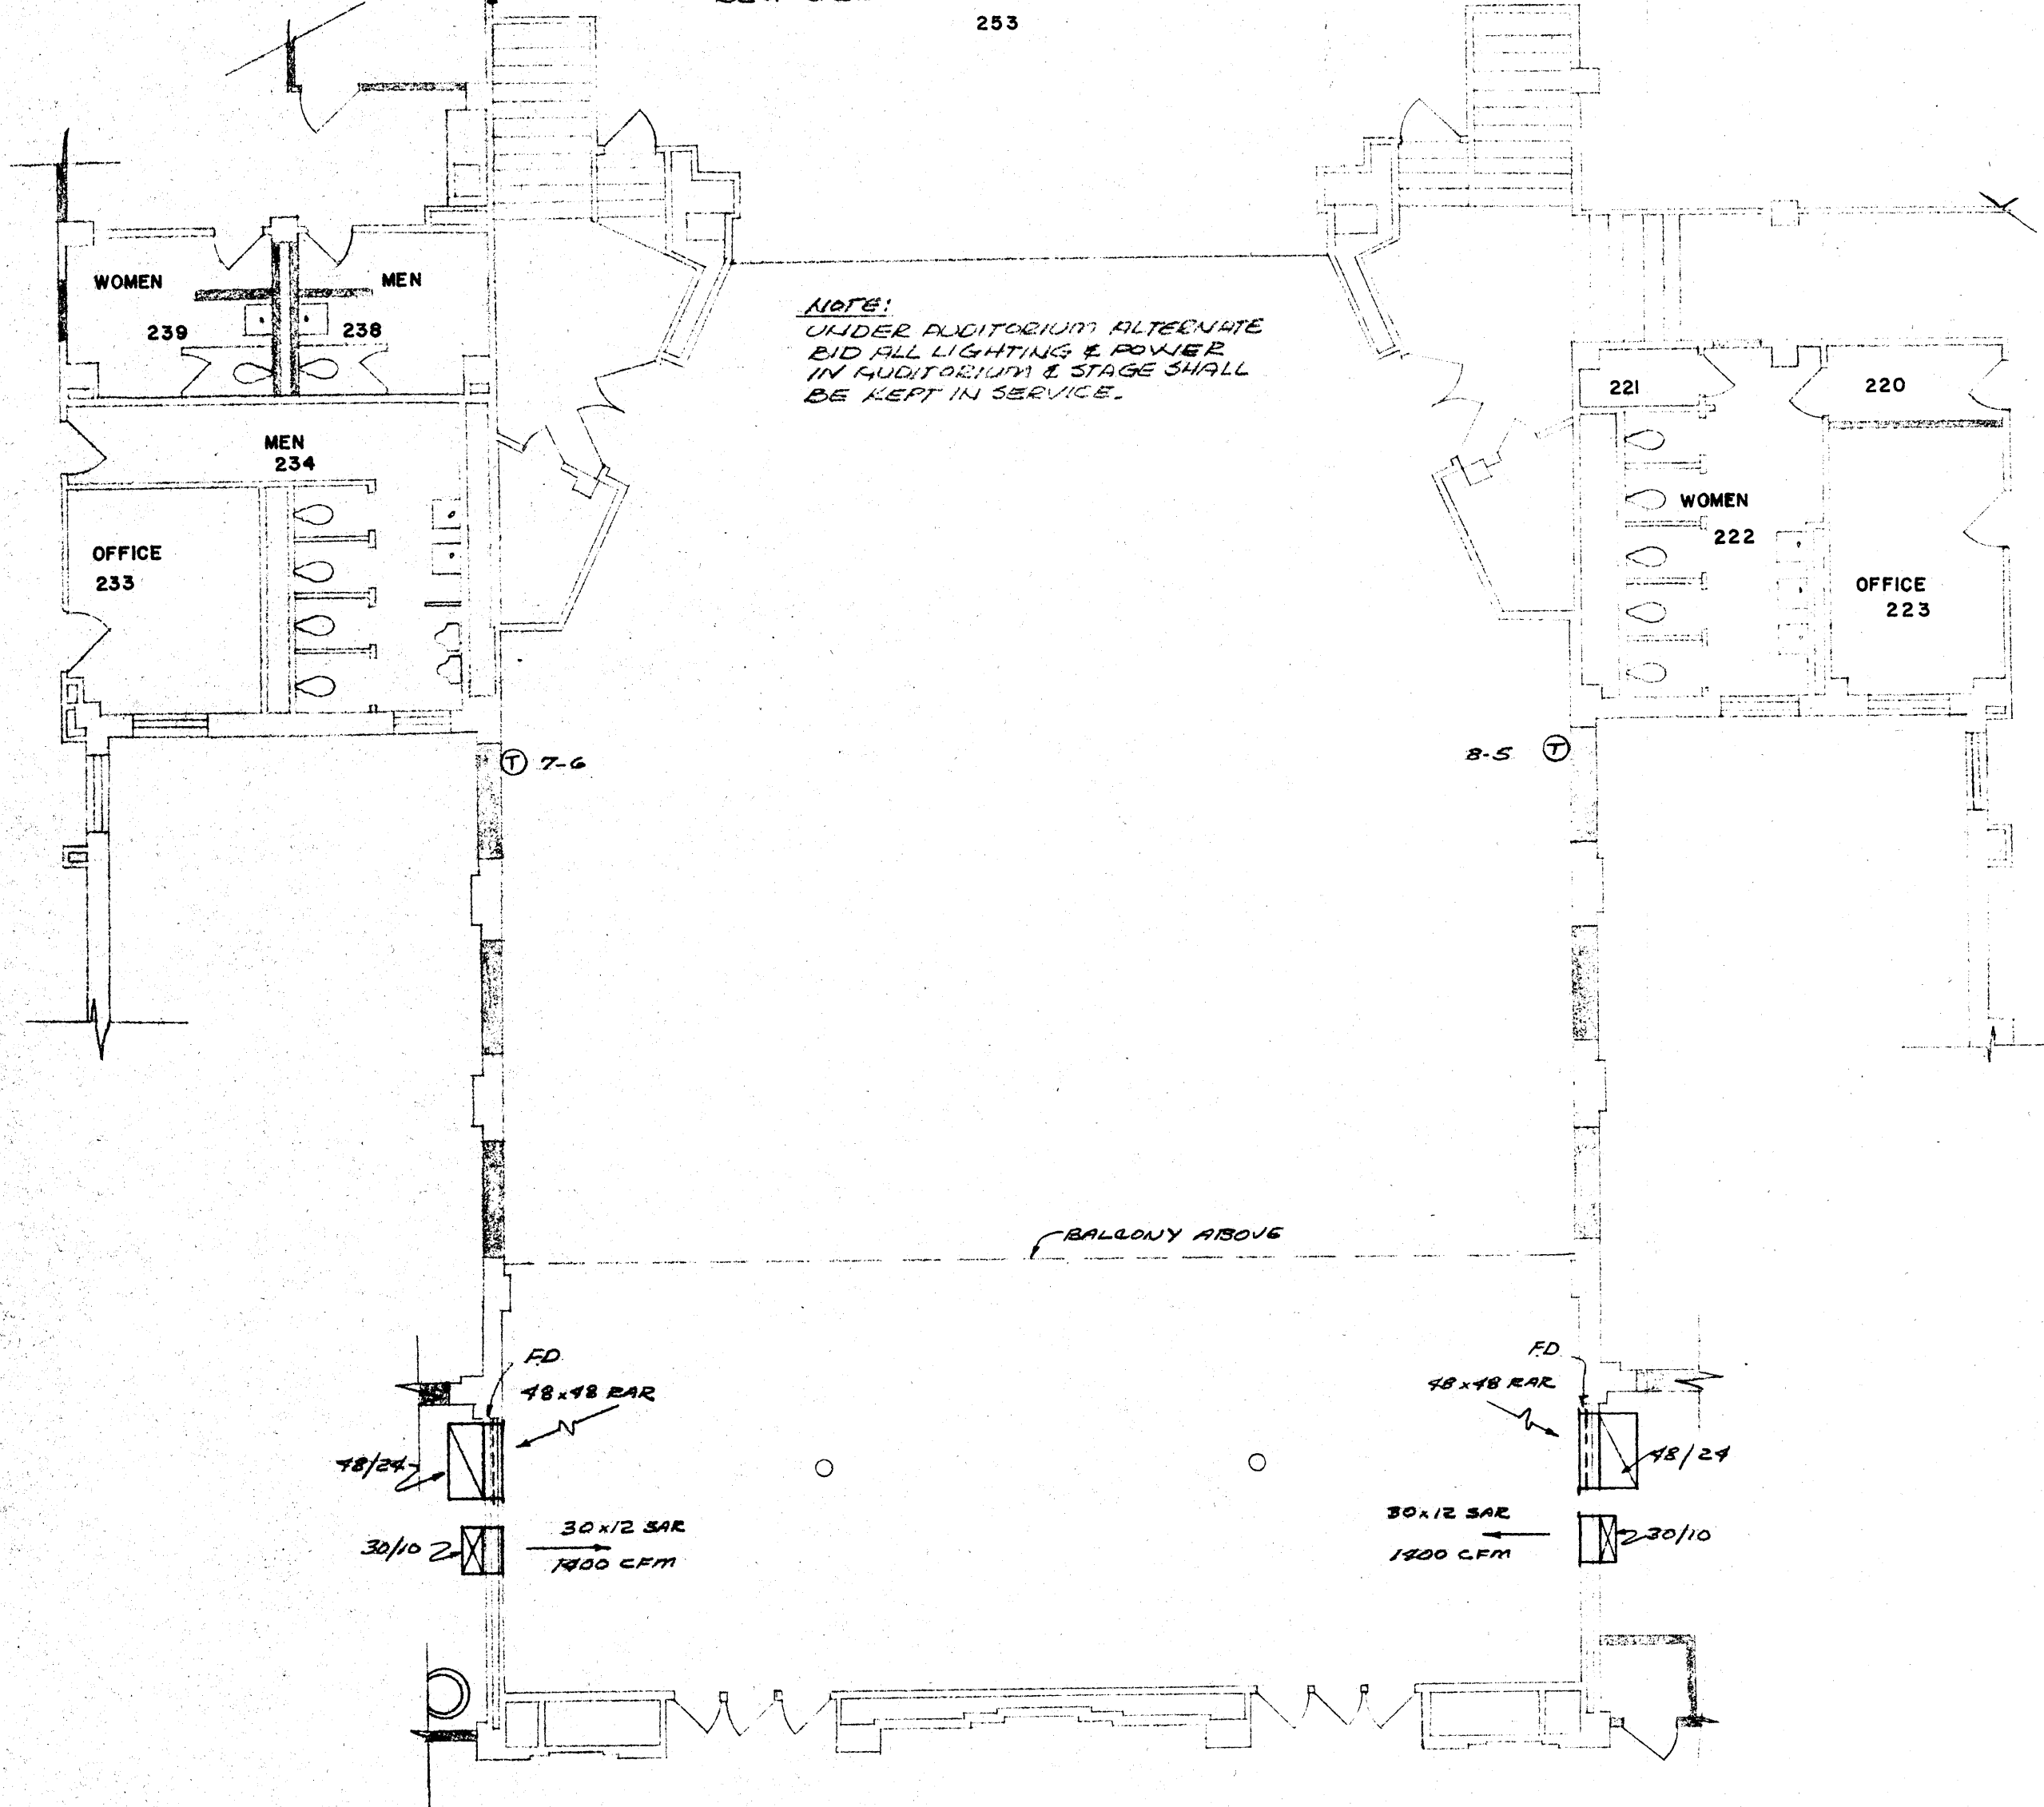

SECOND FLOOR PLAN AUDITORIUM - ALTERNATE SCALE 1/8" = 1'-0"

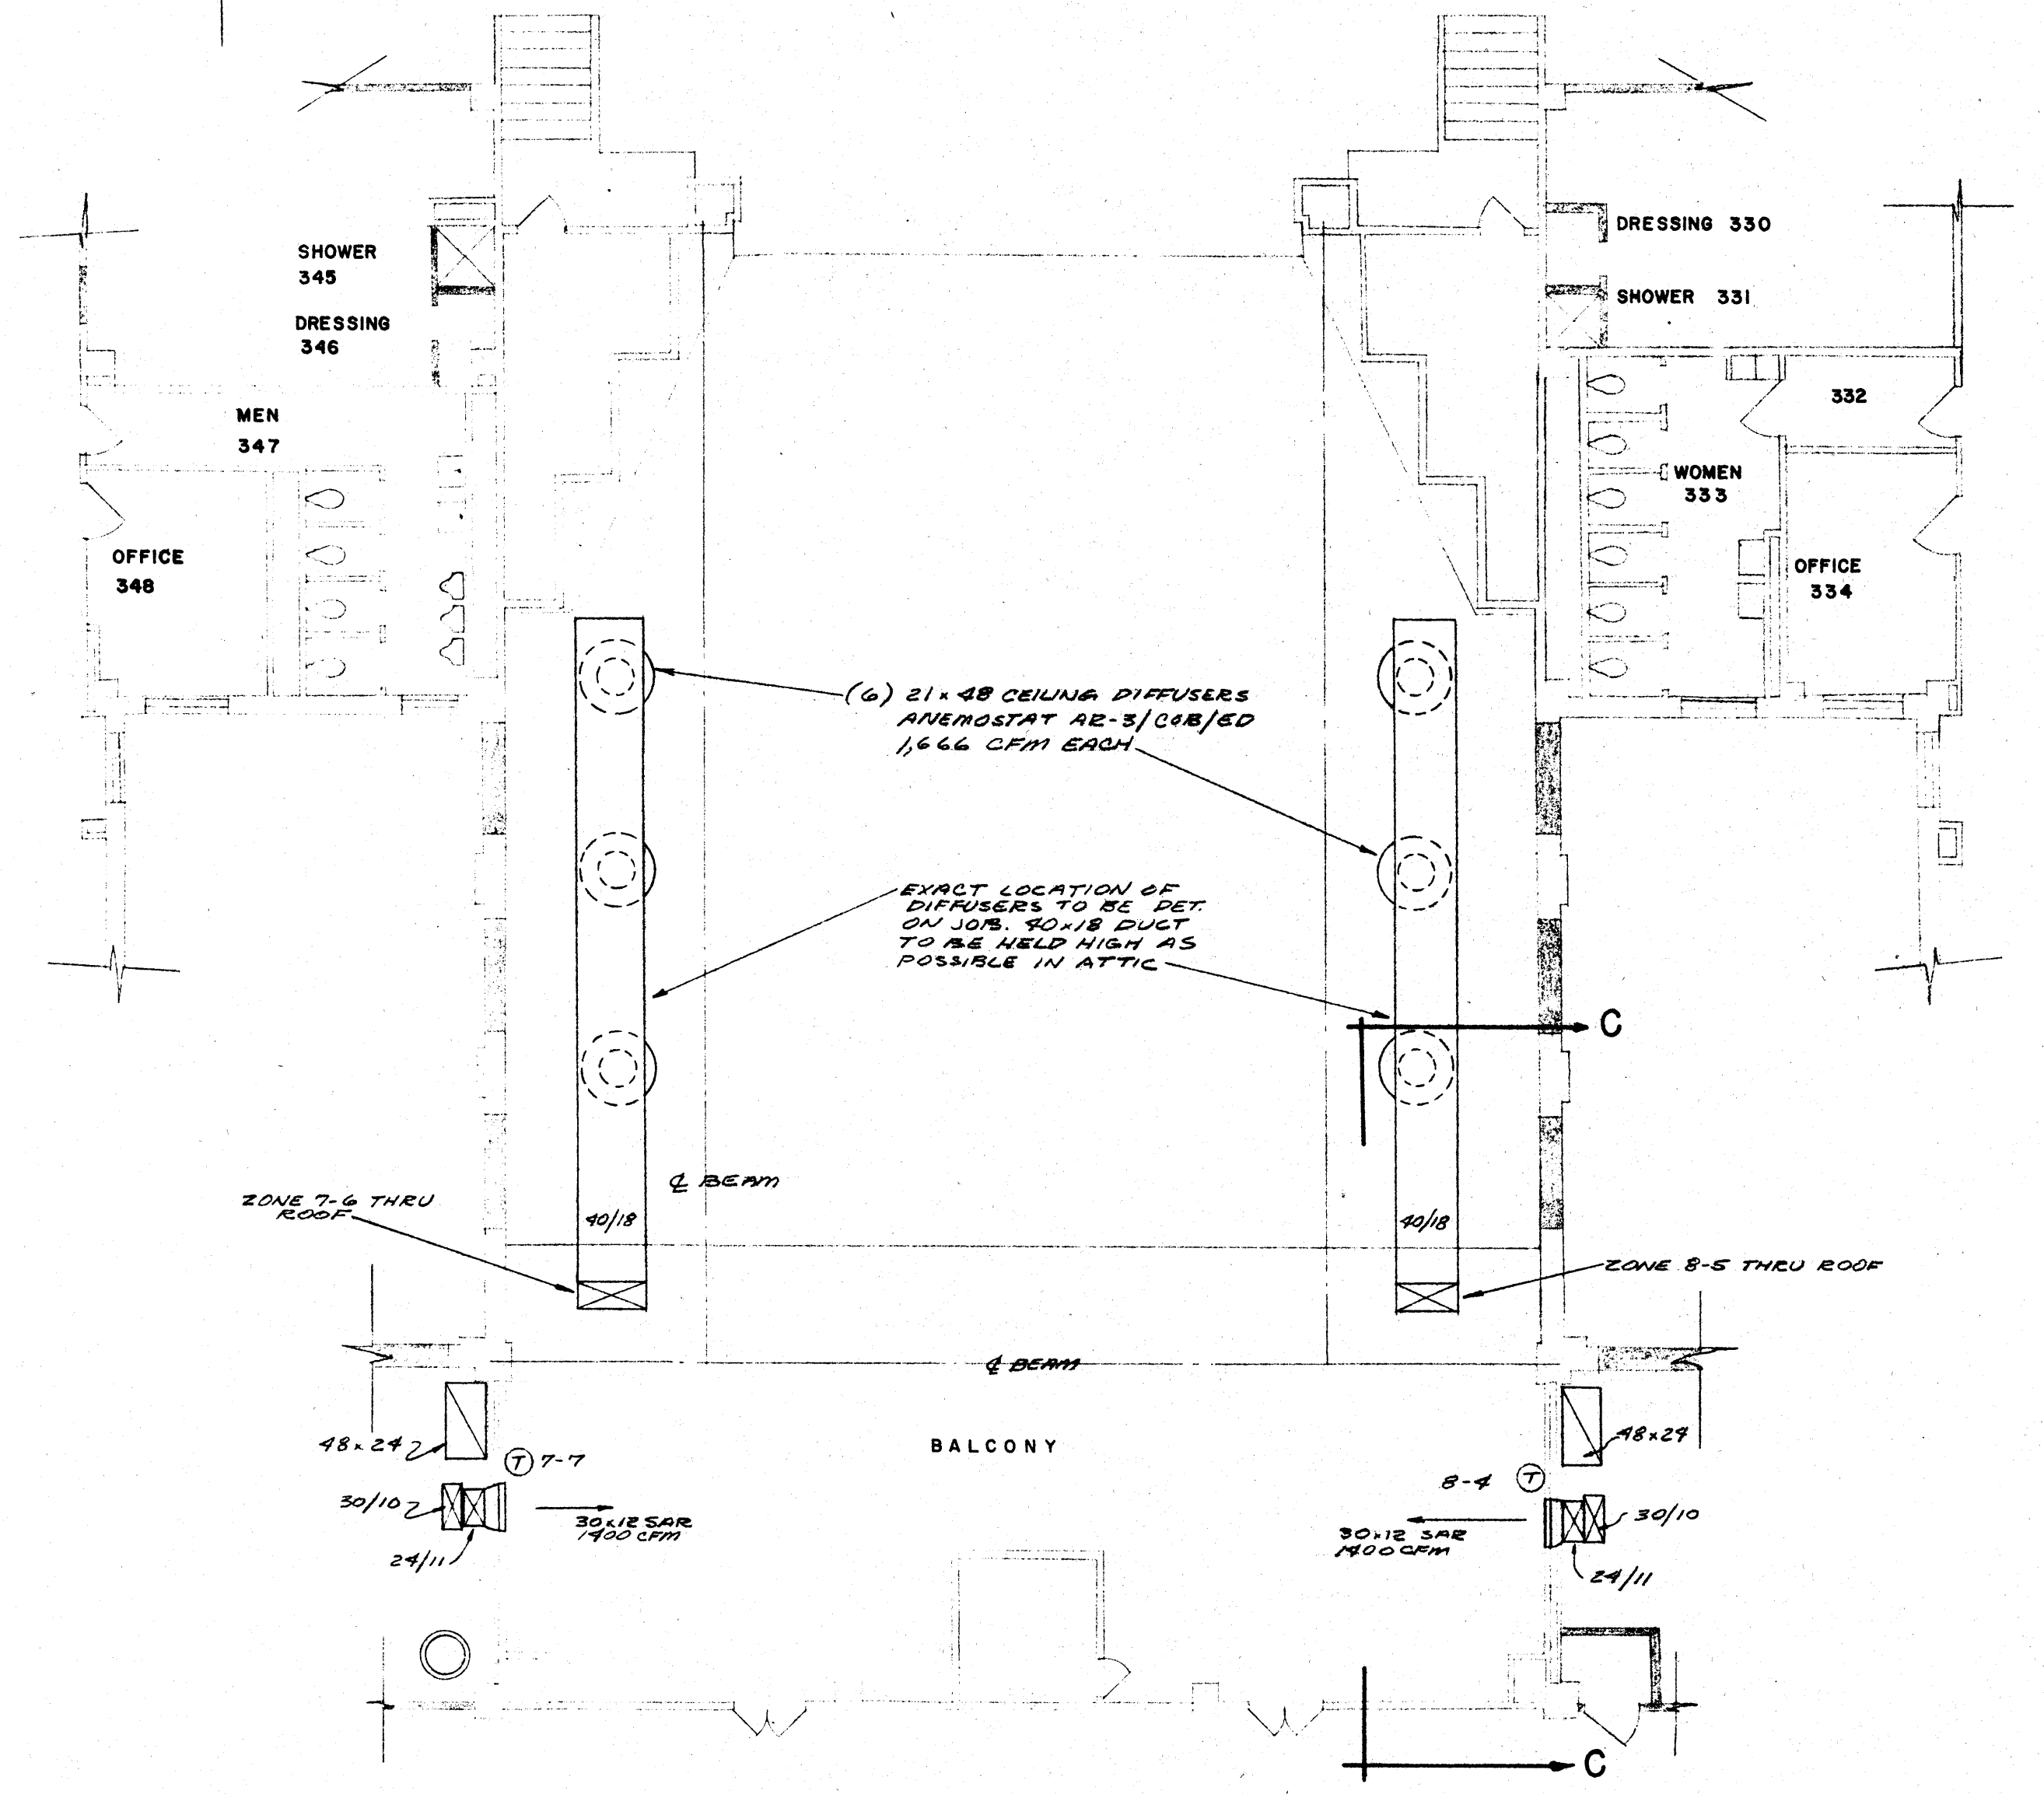


THIRD FLOOR PLAN AUDITORIUM - ALTERNATE SCALE 1/8" = 1'-0"




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RENOVATIONS TO
WILSON HALL
ARKANSAS STATE COLLEGE
JONESBORO, ARKANSAS

STUCK, FRIER, LANE & SCOTT, INC., ARCHITECTS
801 SOUTHWEST DR., JONESBORO, ARK.

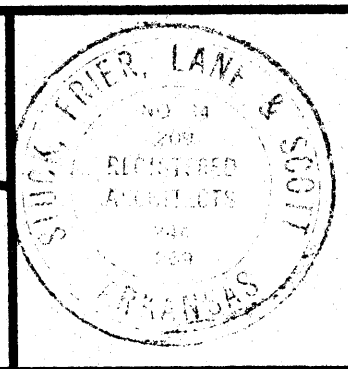

DATE 2-21-66	SHEET NUMBER M-10
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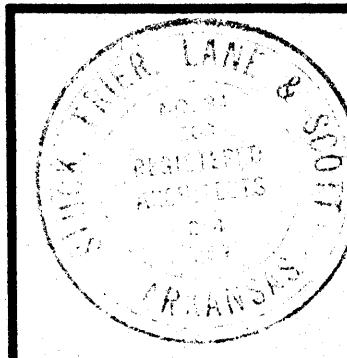
NOTE:
LIGHTING FOR STAIRS
STAIRWELLS IS SHOWN ON
SECOND FL. PLAN.

FIRST FLOOR PLAN-ELECTRICAL SCALE 1/8" = 1'-0"

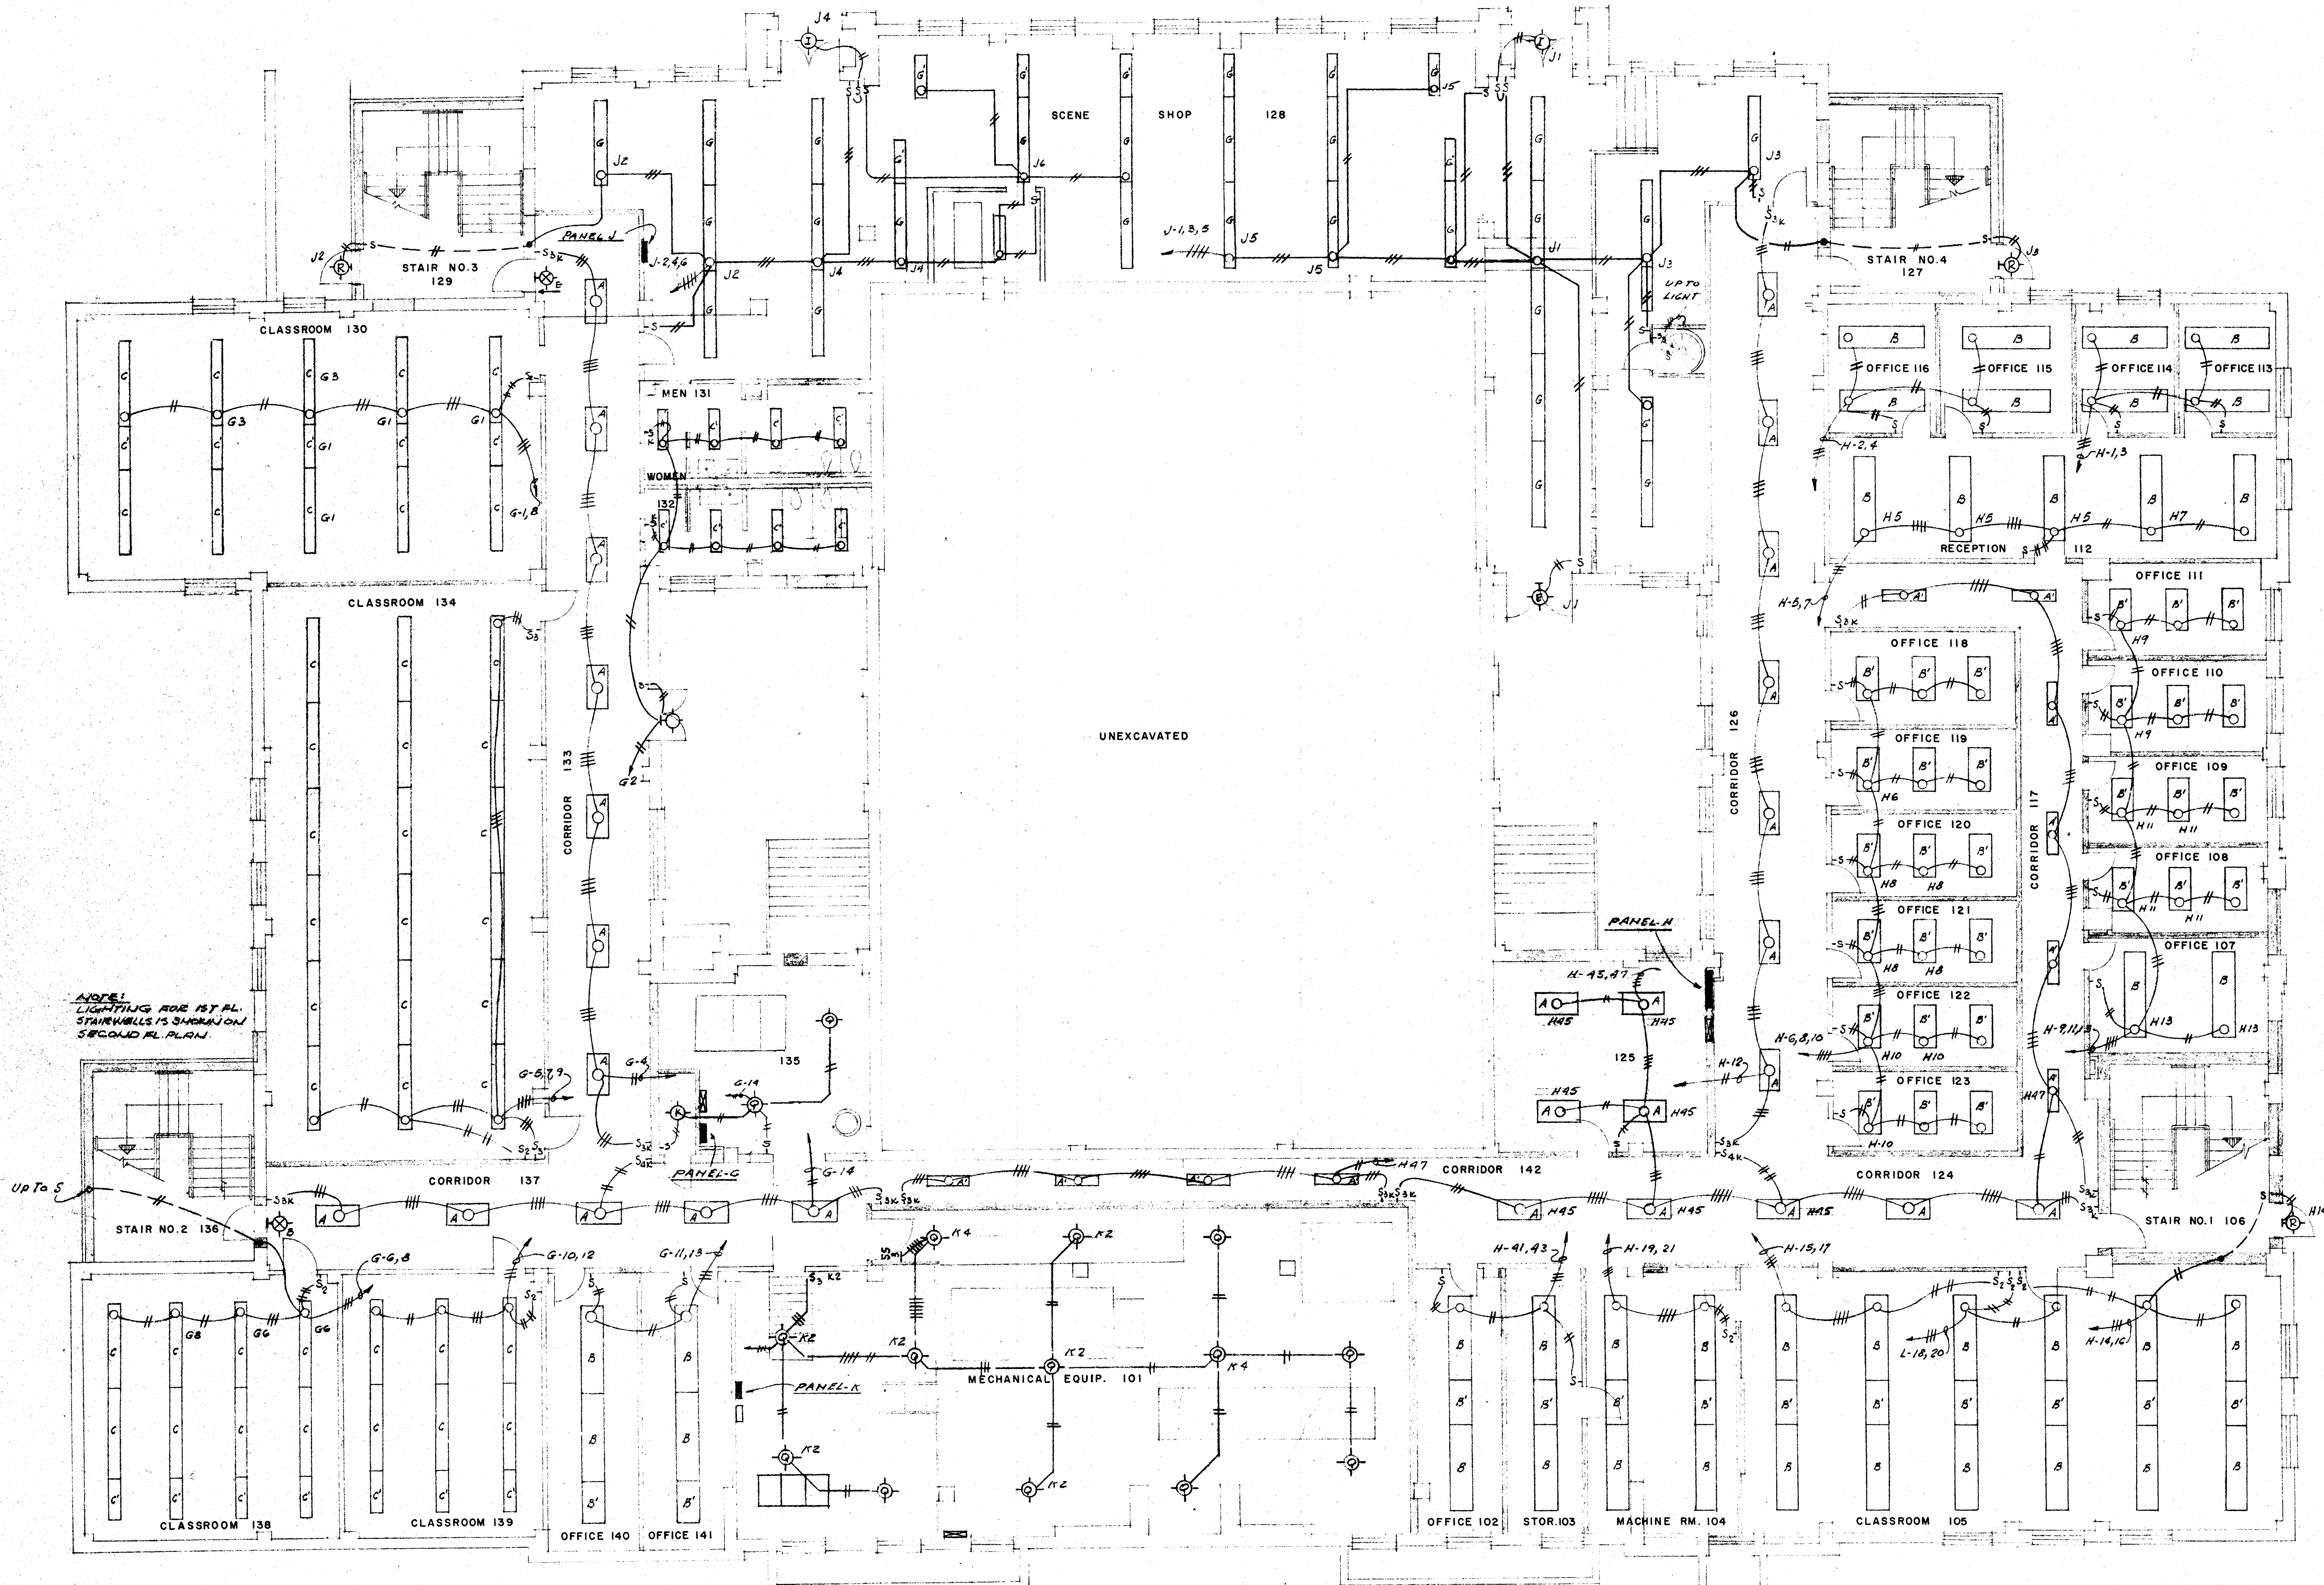LIGHTING



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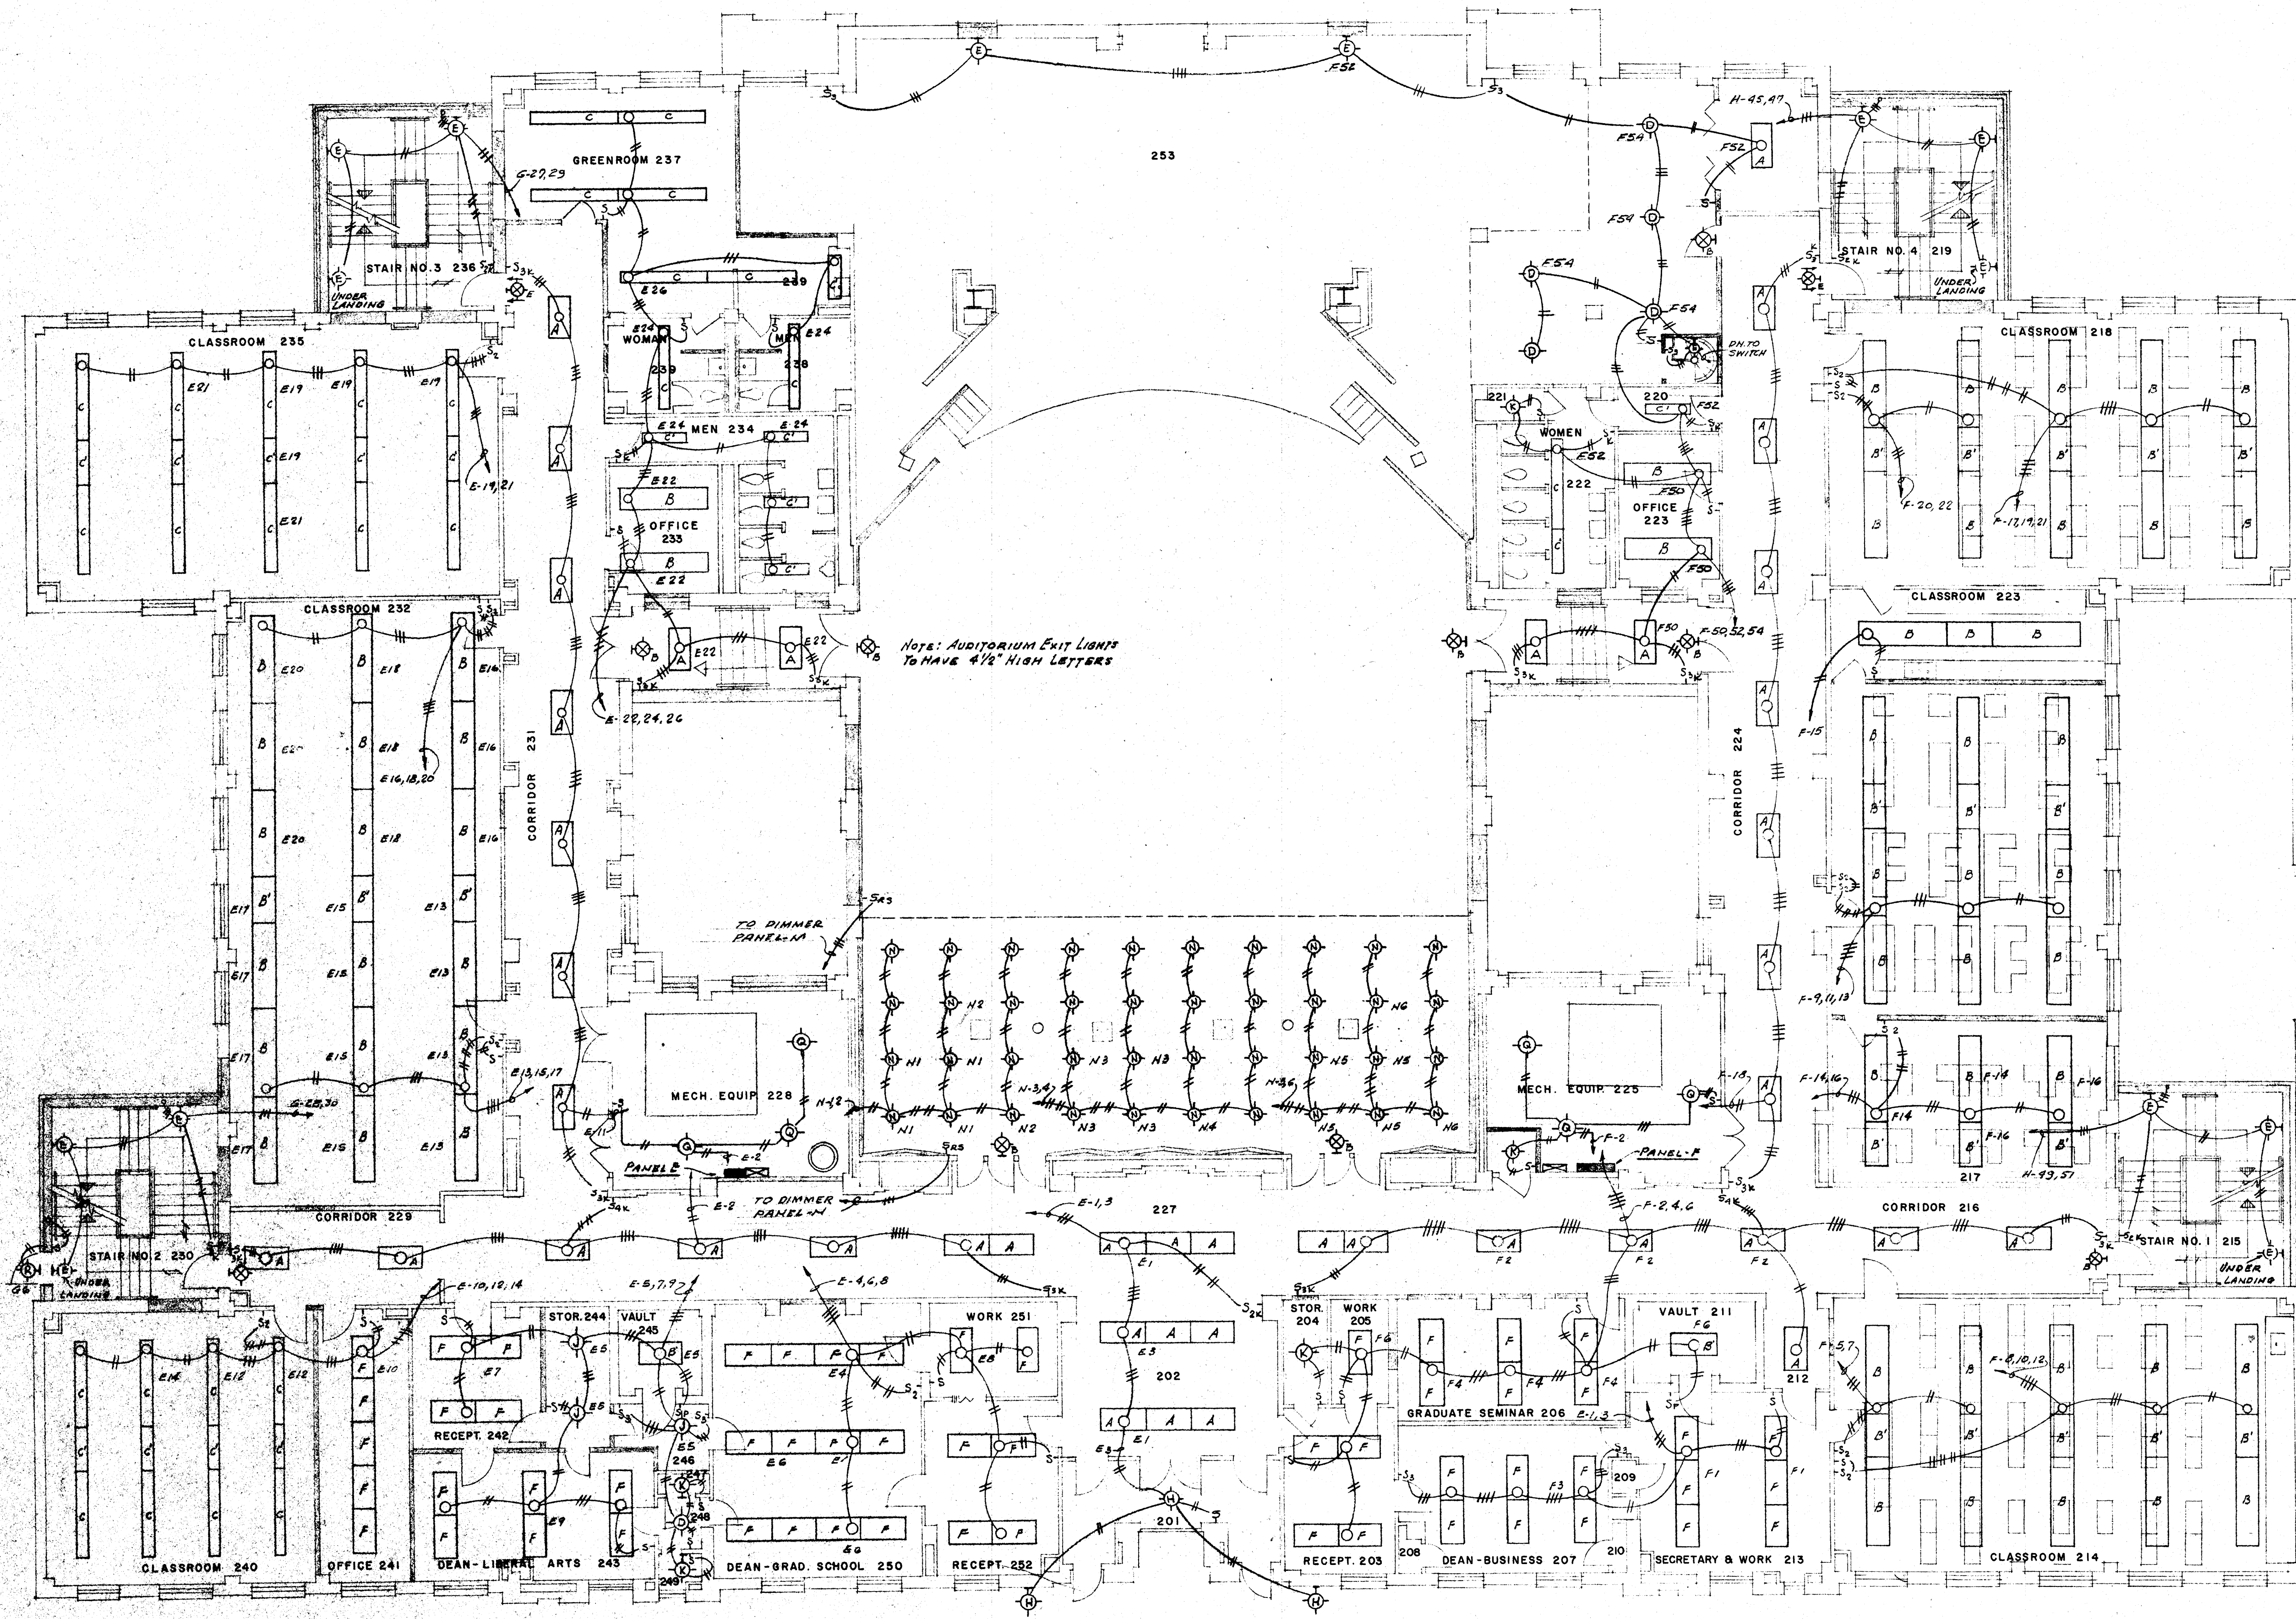


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RENOVATIONS TO
WILSON HALL
ARKANSAS STATE COLLEGE
JONESBORO, ARKANSAS

STUCK, FRIER, LANE & SCOTT, INC., ARCHITECTS
601 SOUTHWEST DRIVE • JONESBORO, ARKANSAS

SHEET NUMBER
M-11
COMMISSION NUMBER
45866



NOTE: AUDITORIUM EXIT LIGHTS TO HAVE 4 1/2" HIGH LETTERS

SECOND FLOOR PLAN-ELECTRICAL SCALE 1/8" = 1'-0"

LIGHTING





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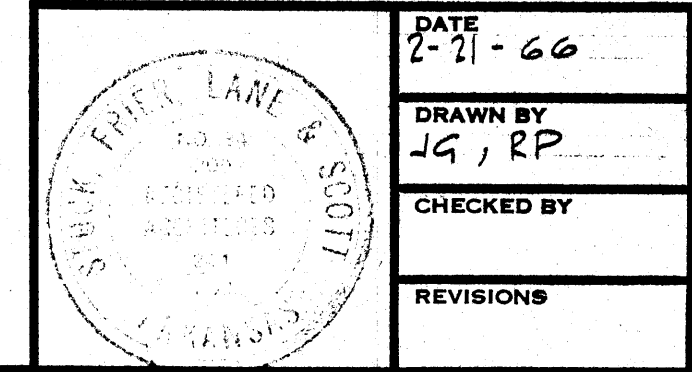
RENOVATIONS TO
WILSON HALL
JONESBORO, ARKANSAS
STUCK, FRIER, LANE & SCOTT, INC., ARCHITECTS
601 SOUTHWEST DRIVE • JONESBORO, ARKANSAS

SHEET NUMBER
M-12
COMMISSION NUMBER
43866




TYPICAL FIXTURE HANGER AT TEE BAR
SCALE: 1/2" = 1"

THIRD FLOOR PLAN-ELECTRICAL SCALE 1/8" = 1'-0"
LIGHTING

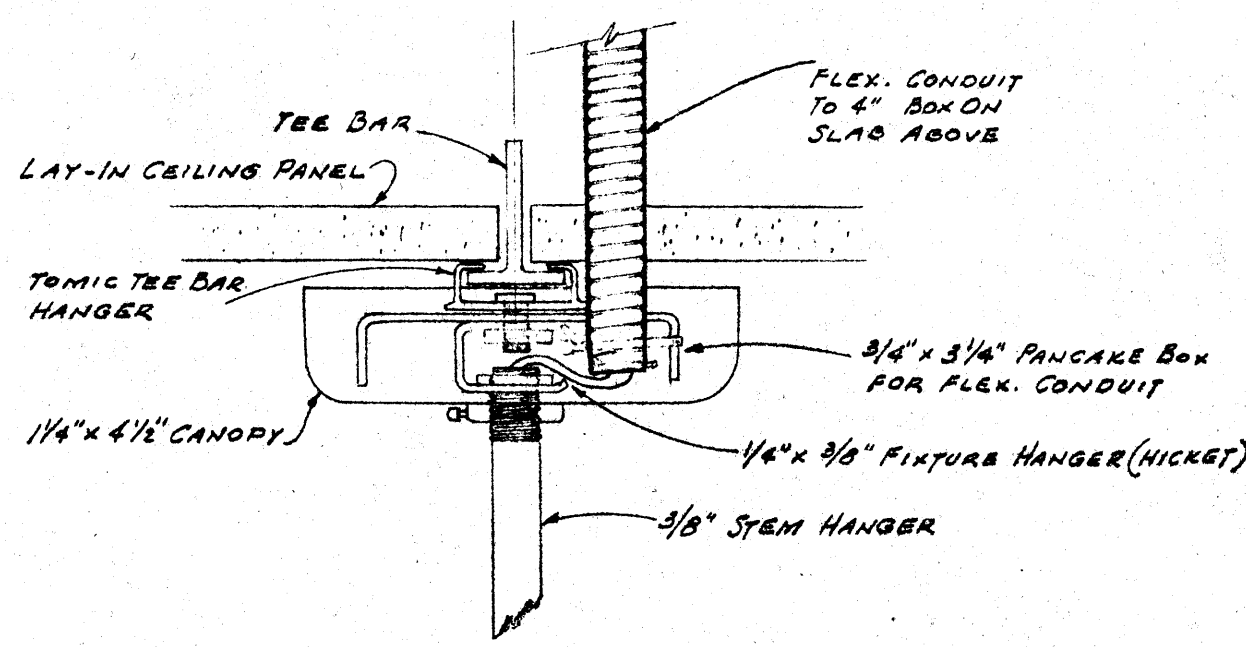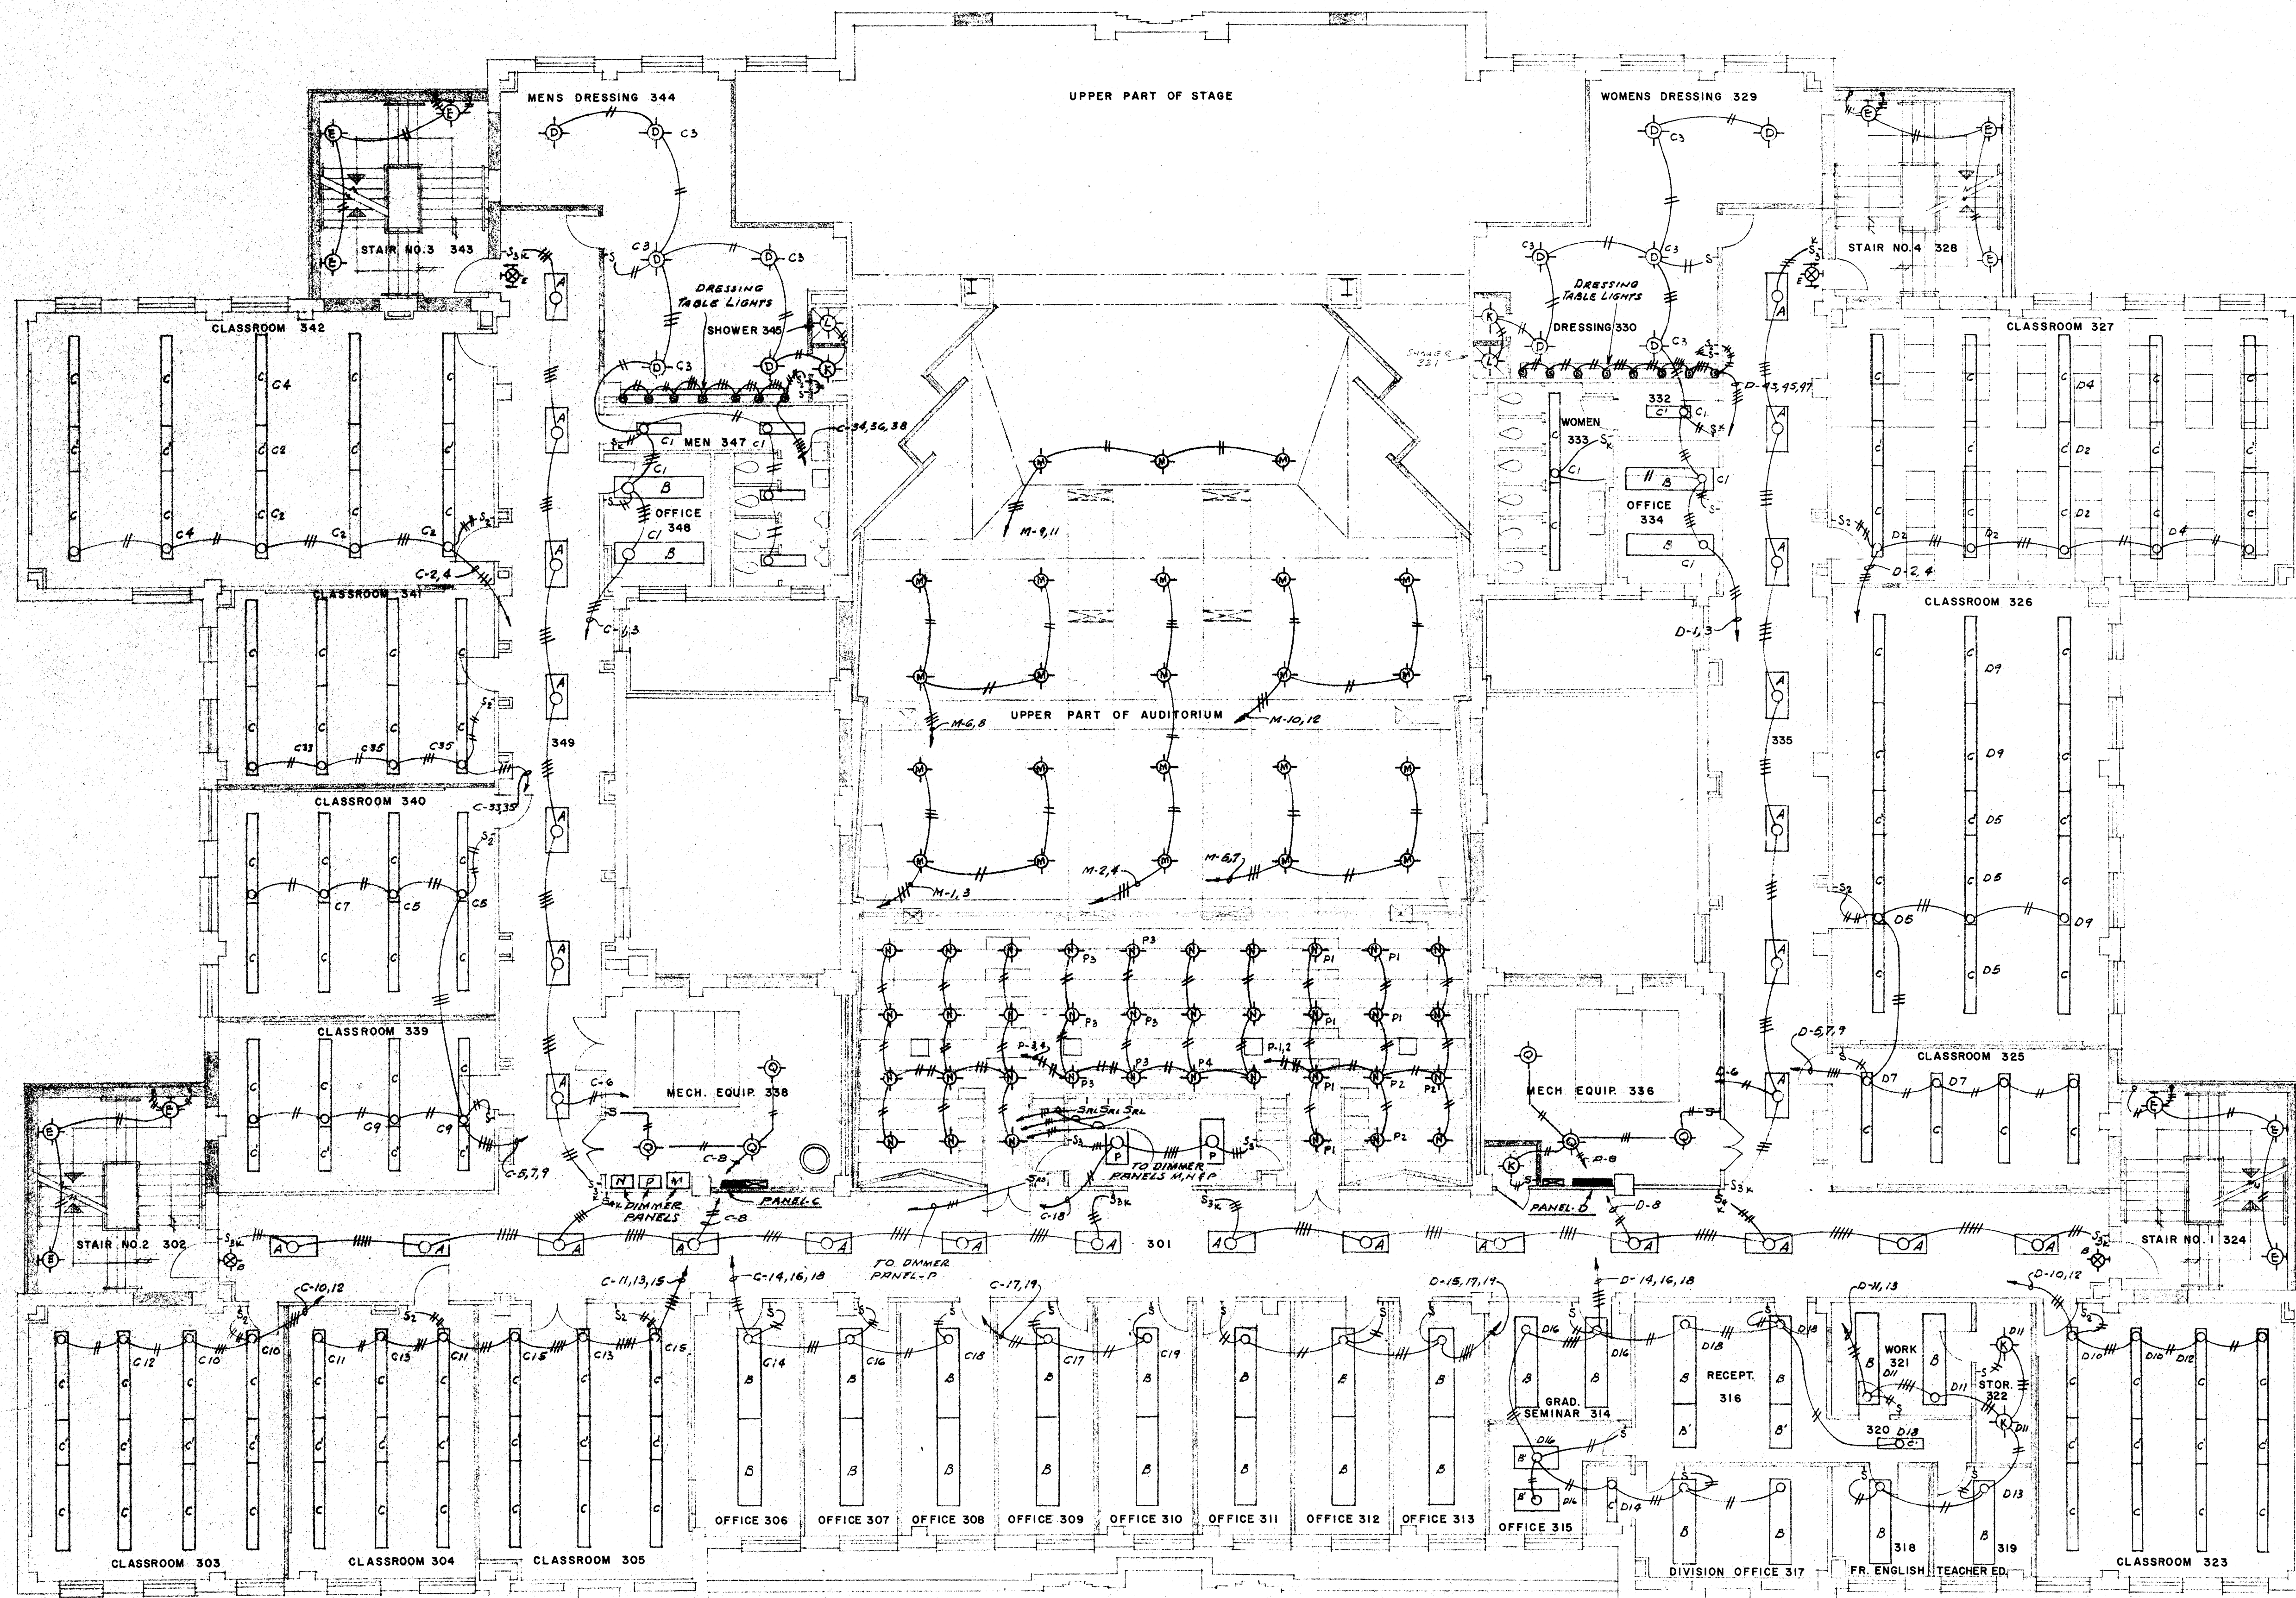

DATE 2-21-66	RENOVATIONS TO WILSON HALL ARKANSAS STATE COLLEGE JONESBORO, ARKANSAS	SHEET NUMBER M-13
DRAWN BY JG, RP	STUCK, FRIER, LANE & SCOTT, INC., ARCHITECTS 601 SOUTHWEST DRIVE • JONESBORO, ARKANSAS	COMMISSION NUMBER 43866
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REVISIONS		

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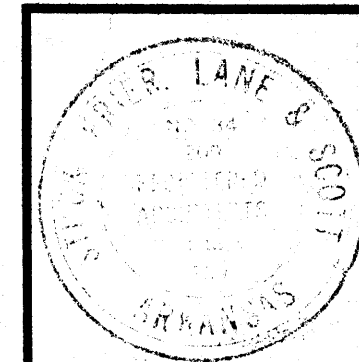


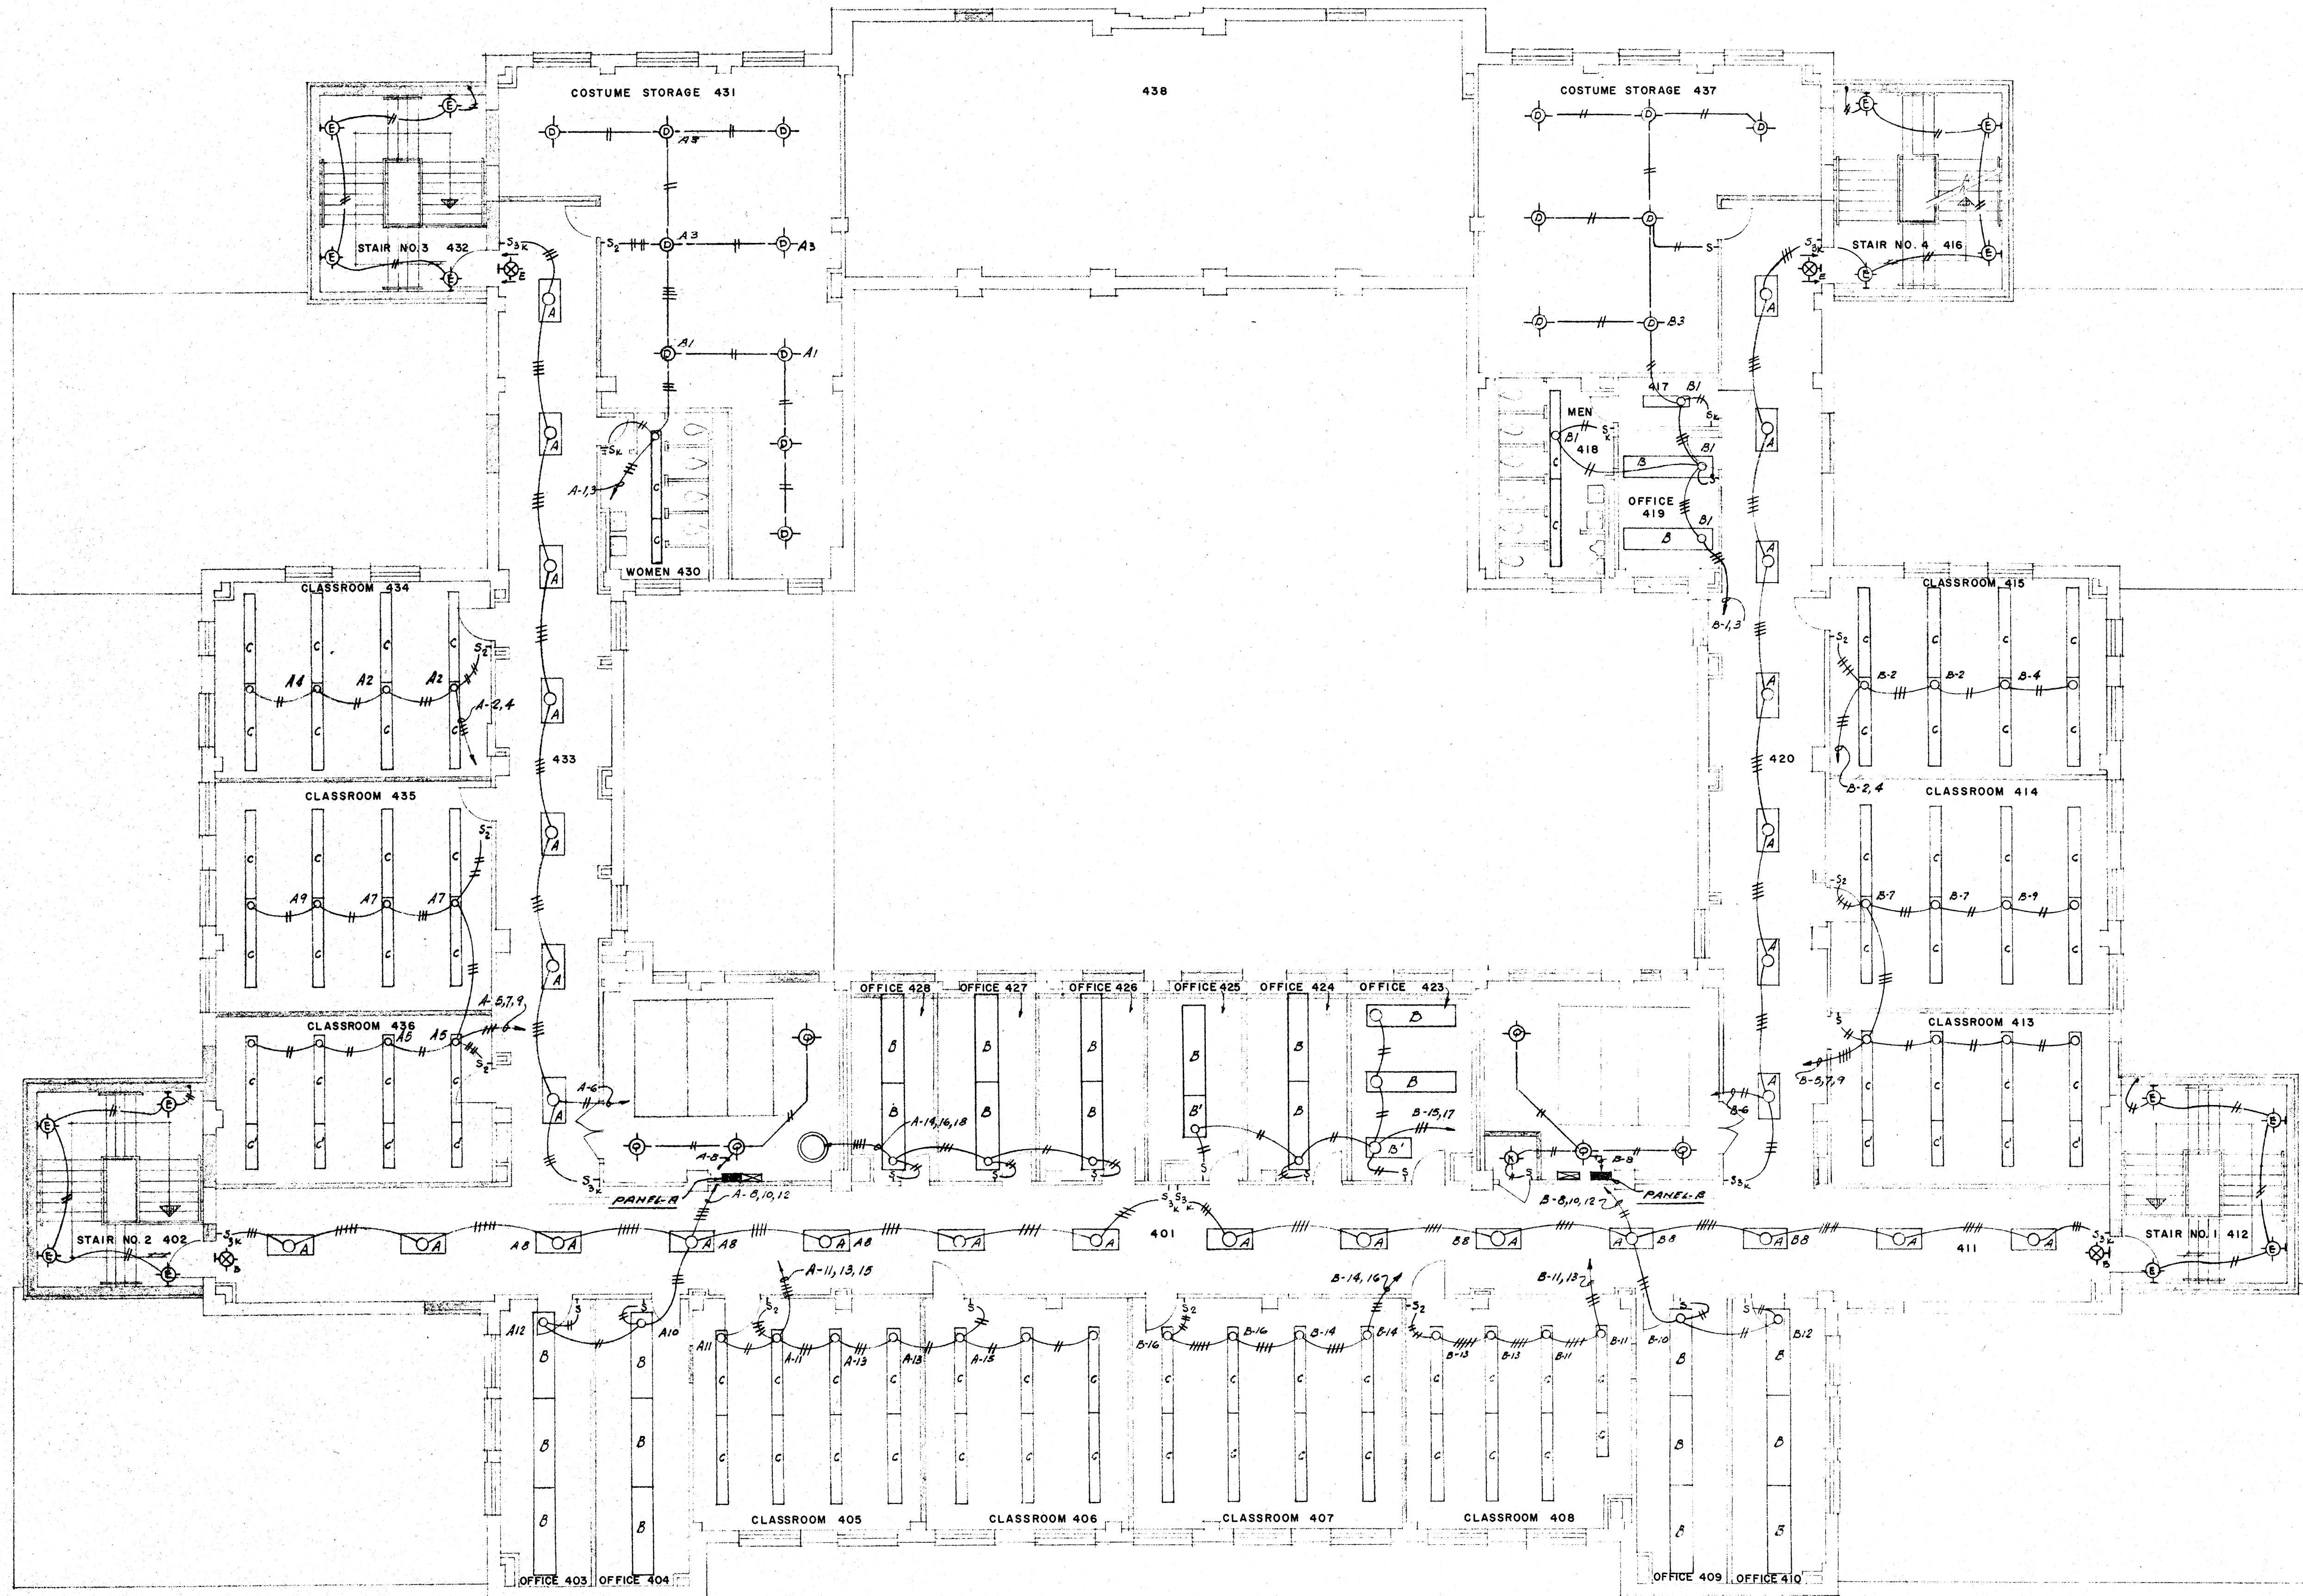FOURTH FLOOR PLAN-ELECTRICAL SCALE 1/8" = 1'-0"

LIGHTING



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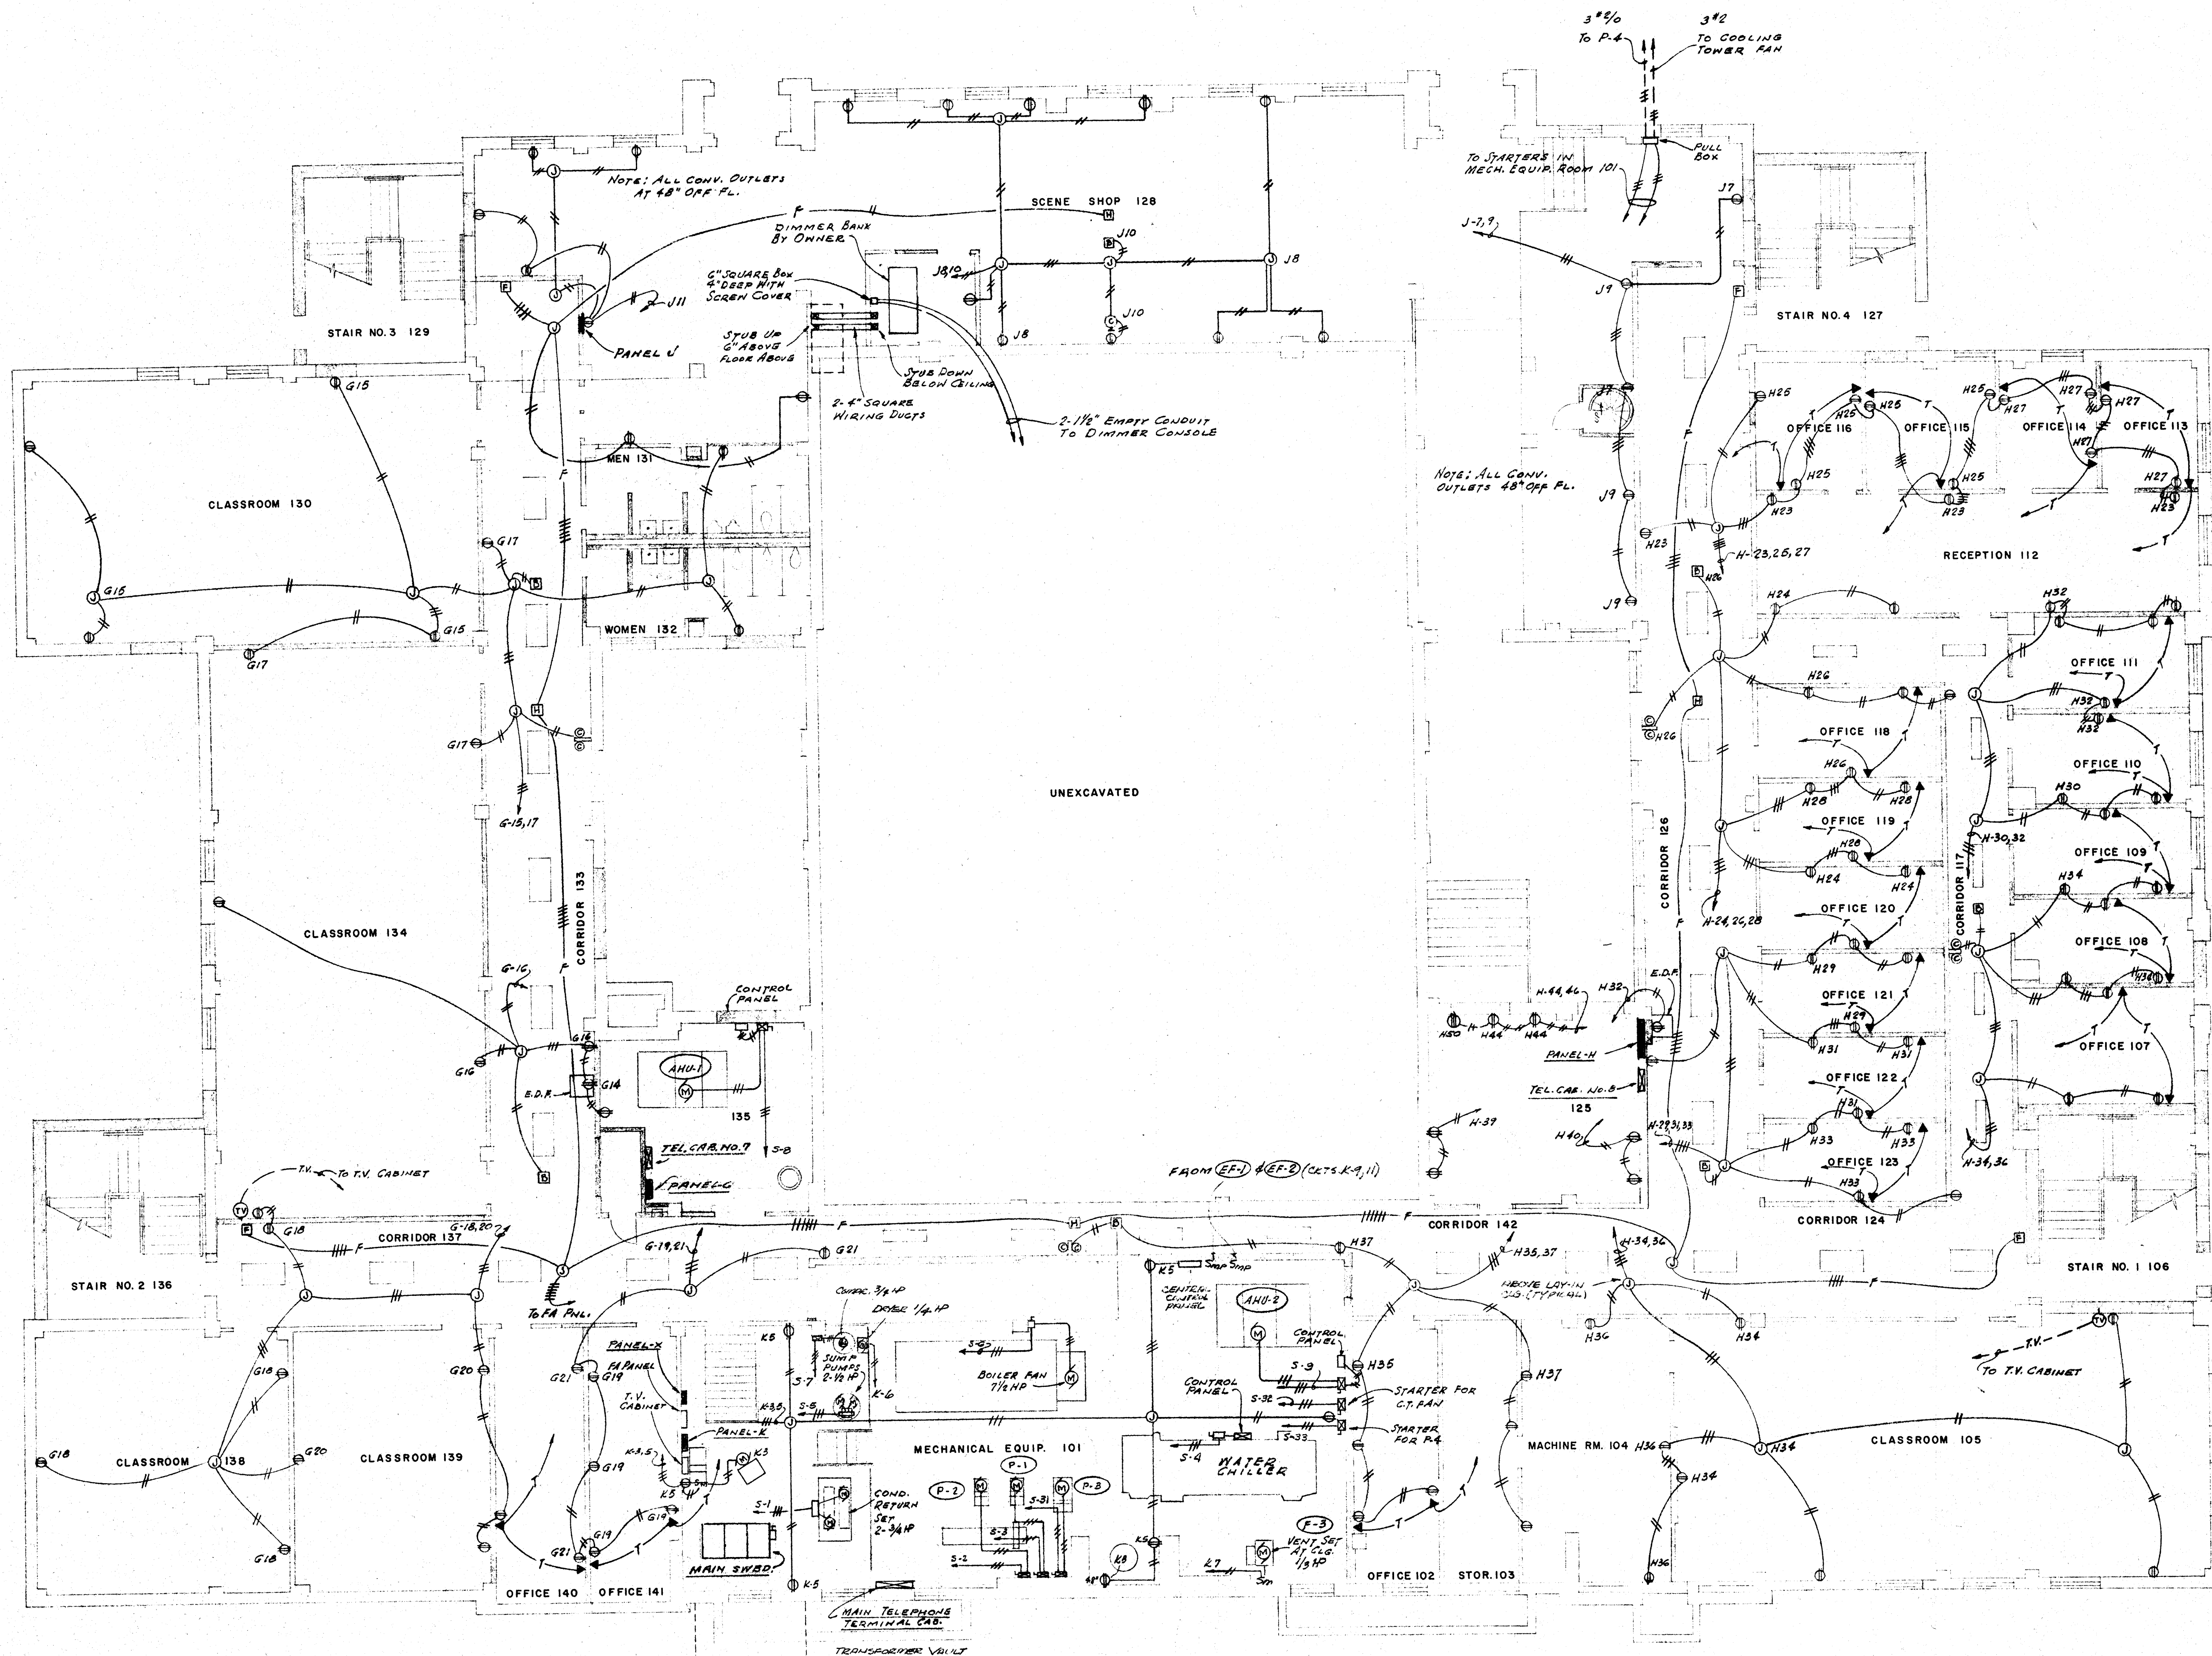


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RENOVATIONS TO
VILSON HALL
ARKANSAS STATE COLLEGE
JONESBORO, ARKANSAS

STUCK, FRIER, LANE & SCOTT, INC., ARCHITECTS
601 SOUTHWEST DRIVE • JONESBORO, ARKANSAS

SHEET NUMBER
M-14
COMMISSION NUMBER
45806



FIRST FLOOR PLAN-ELECTRICAL SCALE 1/8" = 1'-0"
 POWER




DATE 2-21-66
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RENOVATIONS TO
 WILSON HALL
 ARKANSAS STATE COLLEGE
 JONESBORO, ARKANSAS
STUCK, FRIER, LANE & SCOTT, INC., ARCHITECTS
 601 SOUTHWEST DRIVE • JONESBORO, ARKANSAS


SHEET NUMBER
M-15
 COMMISSION NUMBER
 43066

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SECOND FLOOR PLAN-ELECTRICAL SCALE 1/8" = 1'-0"

POWER

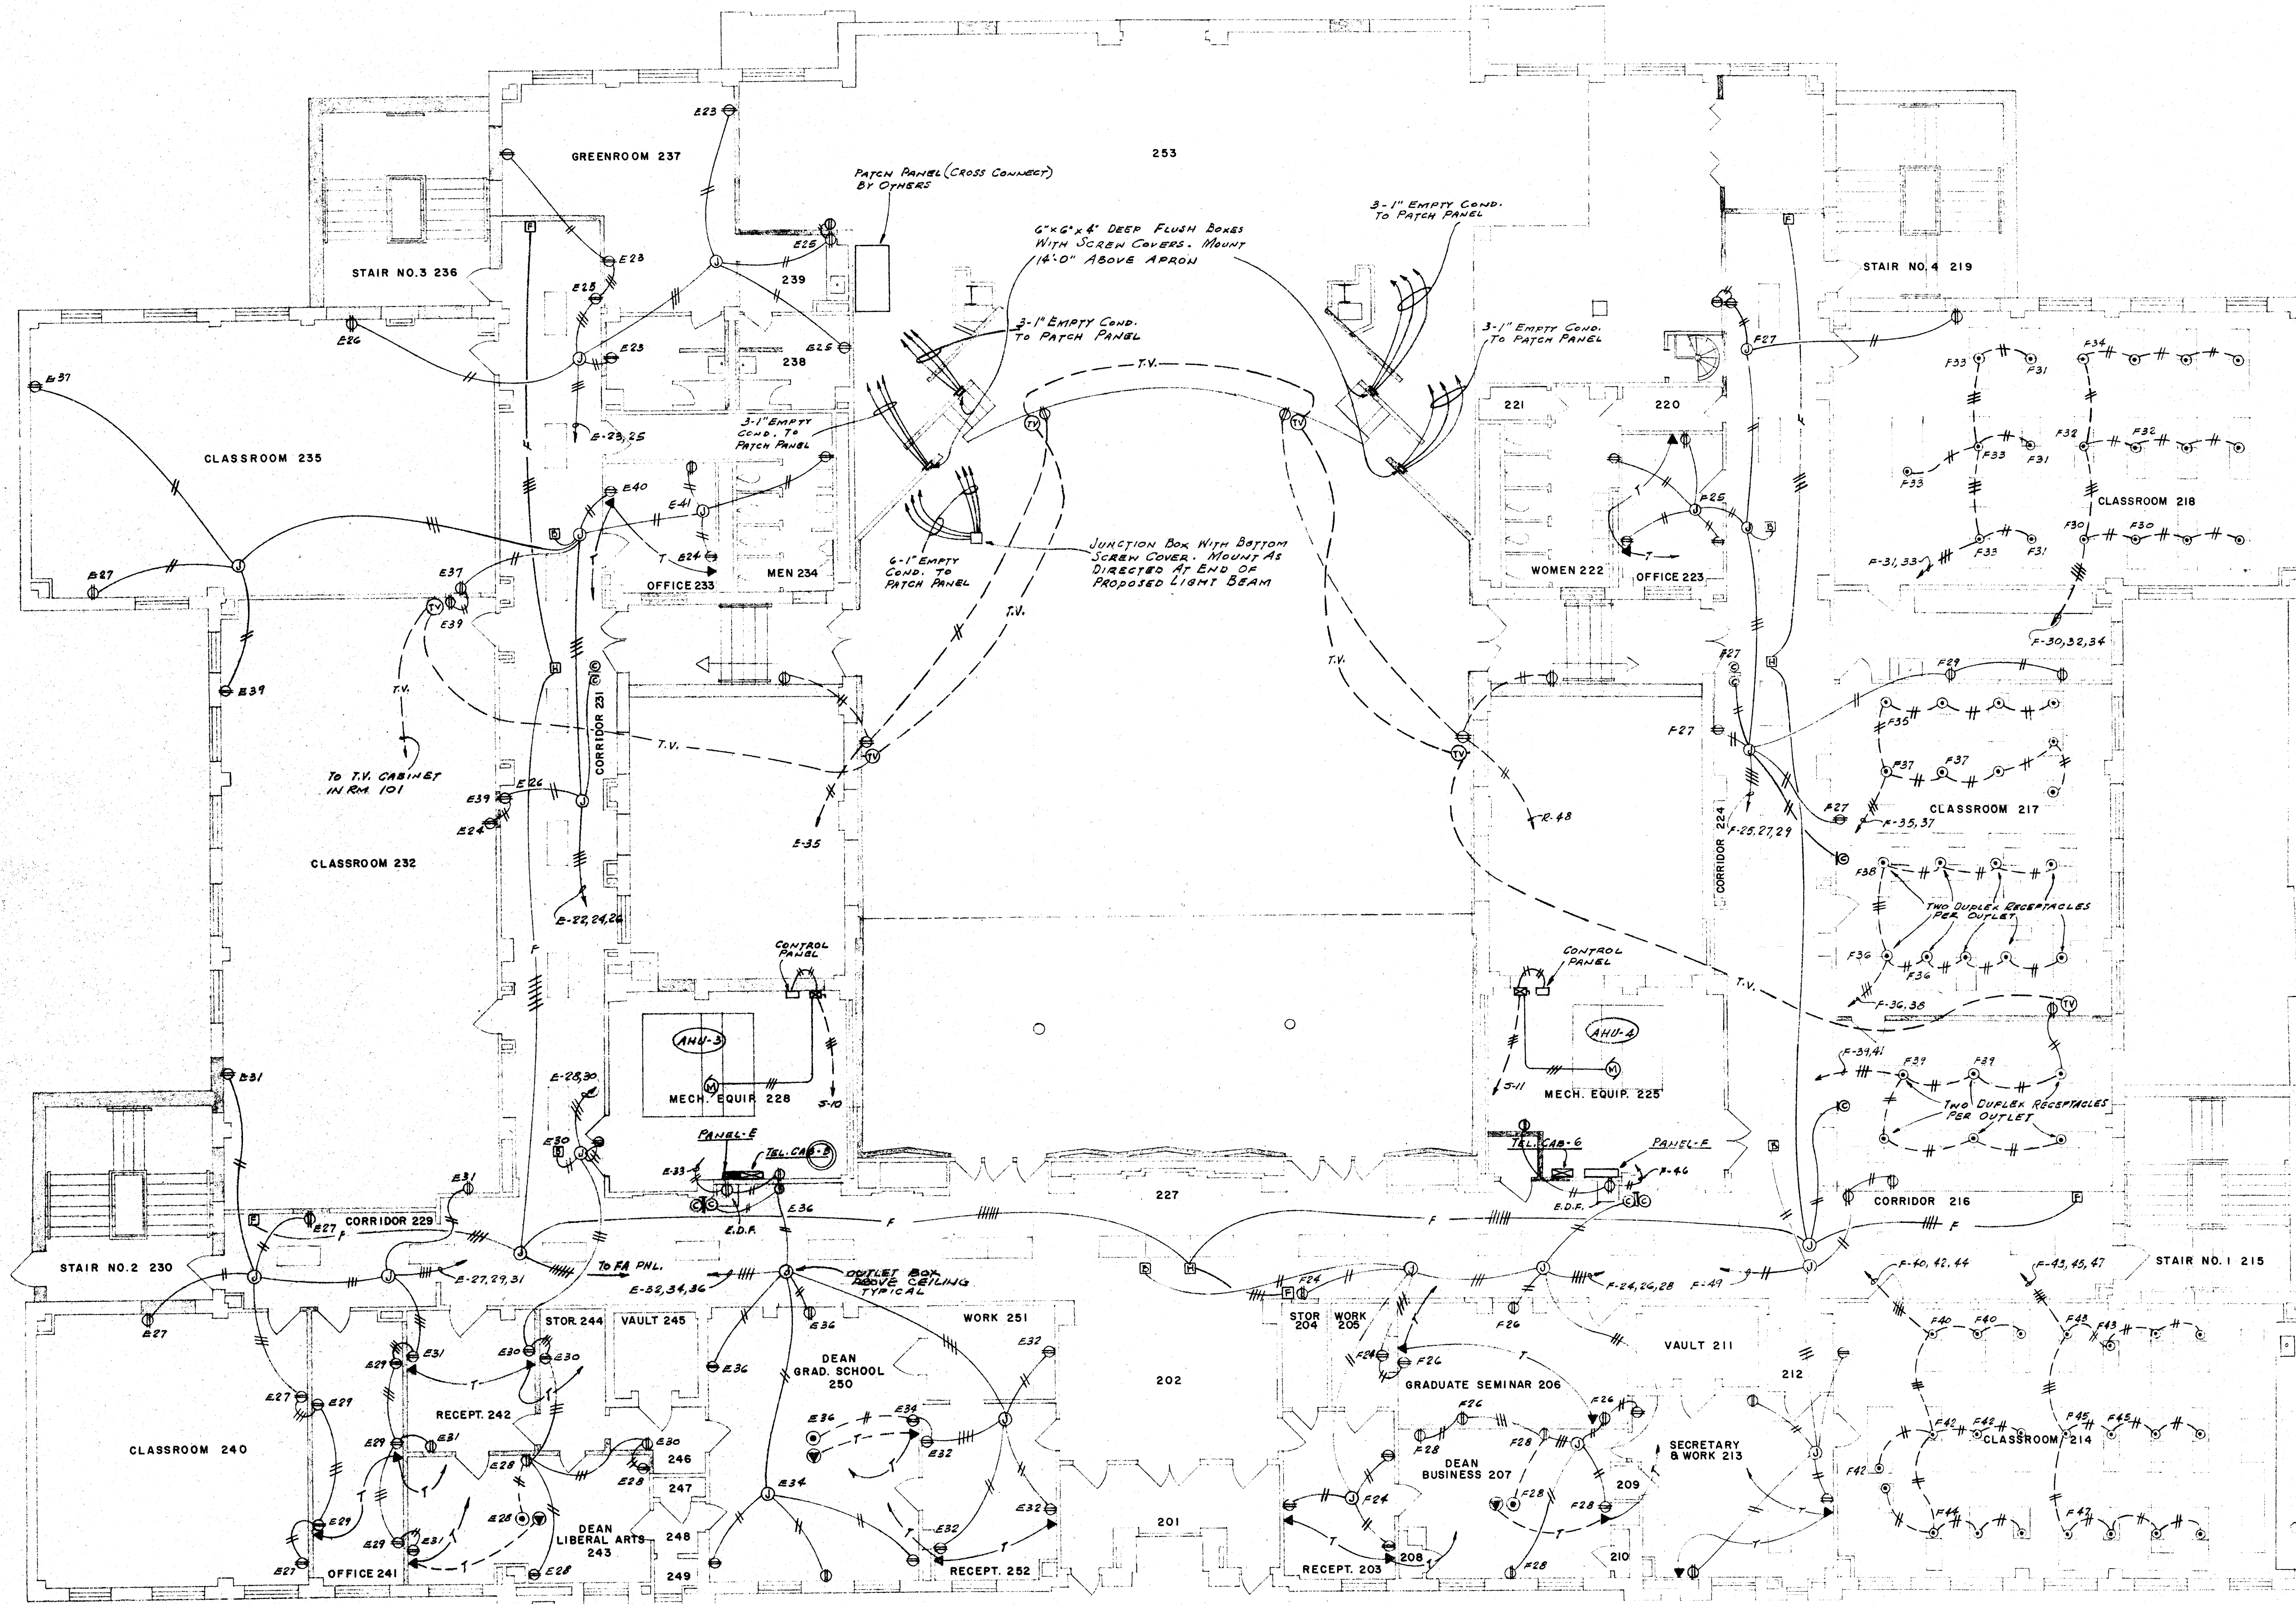


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RENOVATIONS TO
WILSON HALL
ARKANSAS STATE COLLEGE
JONESBORO, ARKANSAS

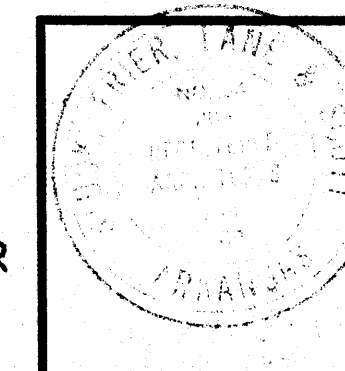STUCK, FRIER, LANE & SCOTT, INC., ARCHITECTS
601 SOUTHWEST DRIVE • JONESBORO, ARKANSAS

SHEET NUMBER
M-16
COMMISSION NUMBER
43006




Notes:
 (1) SOUND SYSTEM CONDUIT IN ROOM 327 SHALL BE 3/4" AND ALL RUNS INDICATED FROM STUDENT DESKS SHALL TERMINATE AT THE CONSOLE DESK. ENDS OF RUNS SHALL BE STUBBED UP 22" ABOVE FLOOR AT STUDENT DESK AND AT CONSOLE DESK. THOSE AT STUDENT DESK SHALL TERMINATE WITH A JUNCTION BOX.
 (2) POWER CONNECTIONS TO STUDENT DESKS AND TO CONSOLE DESK SHALL BE WITH SINGLE 3/4" CONDUIT STUBBED UP 22" ABOVE FLOOR. THOSE AT STUDENT DESKS SHALL TERMINATE WITH A JUNCTION BOX. SEE LEGEND (M-24) FOR TYPE FLOOR OUTLET!

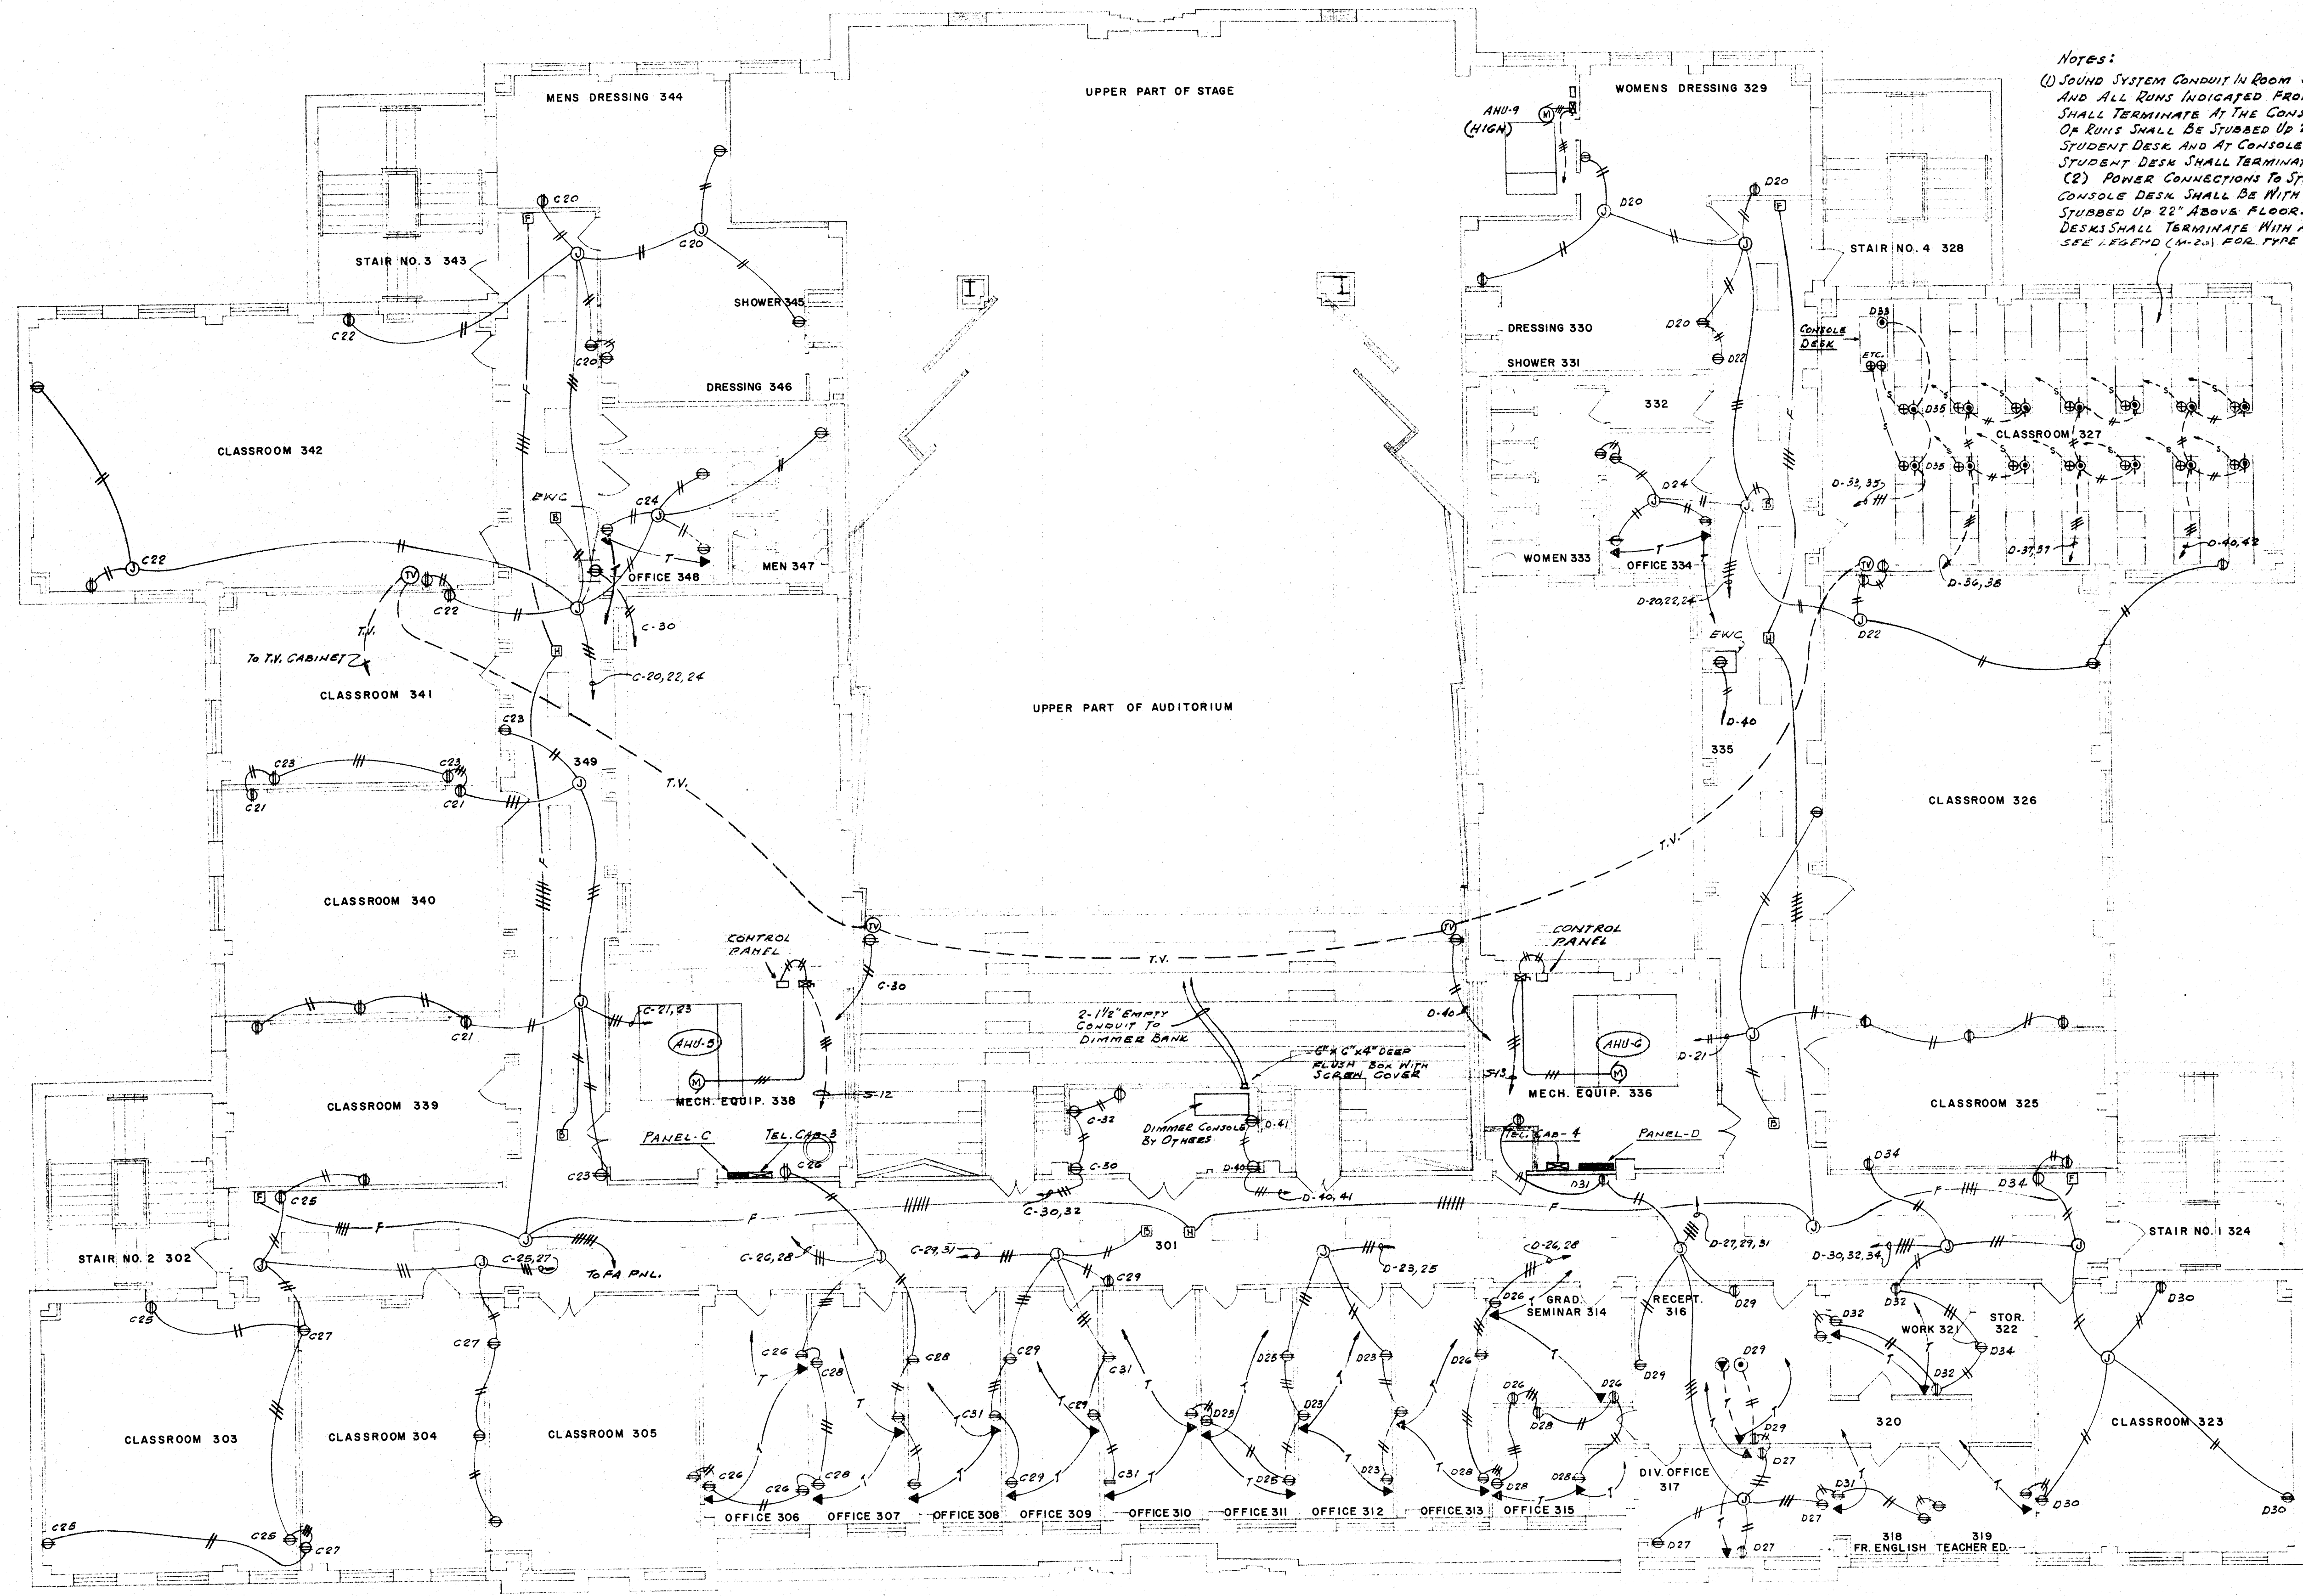THIRD FLOOR PLAN-ELECTRICAL SCALE 1/8" = 1'-0"

POWER



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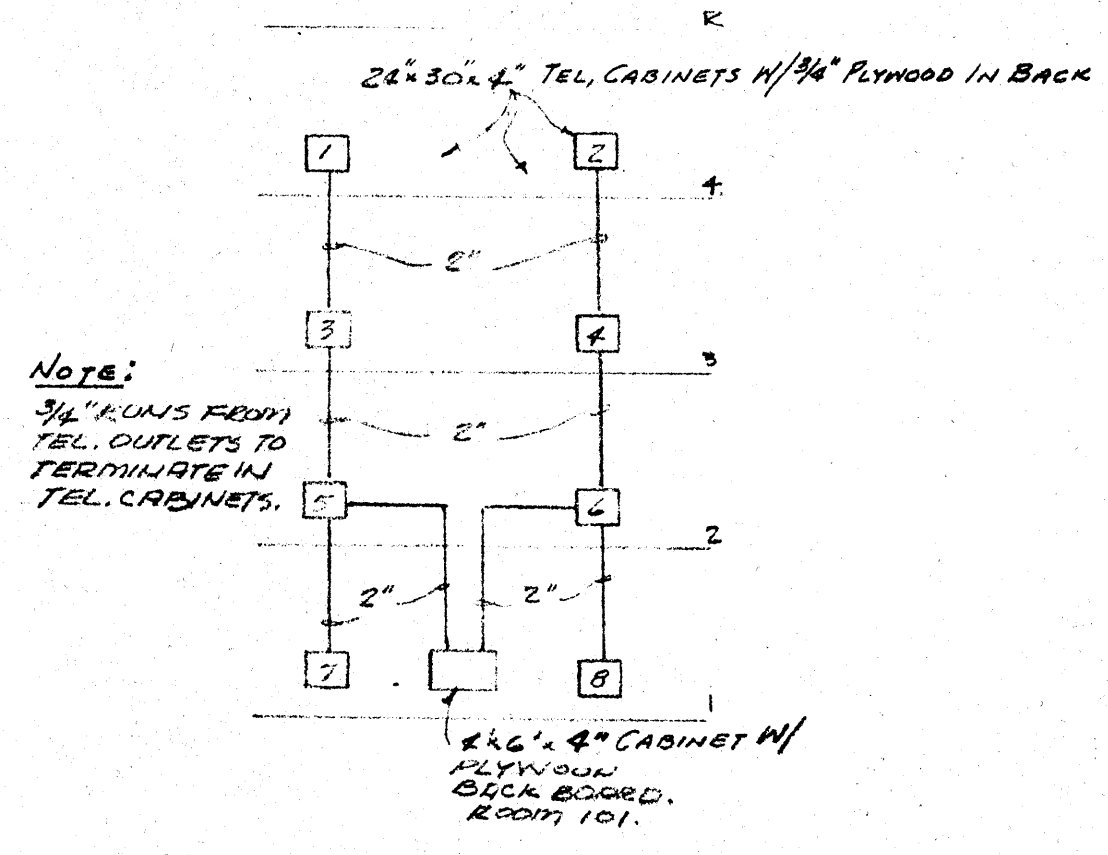
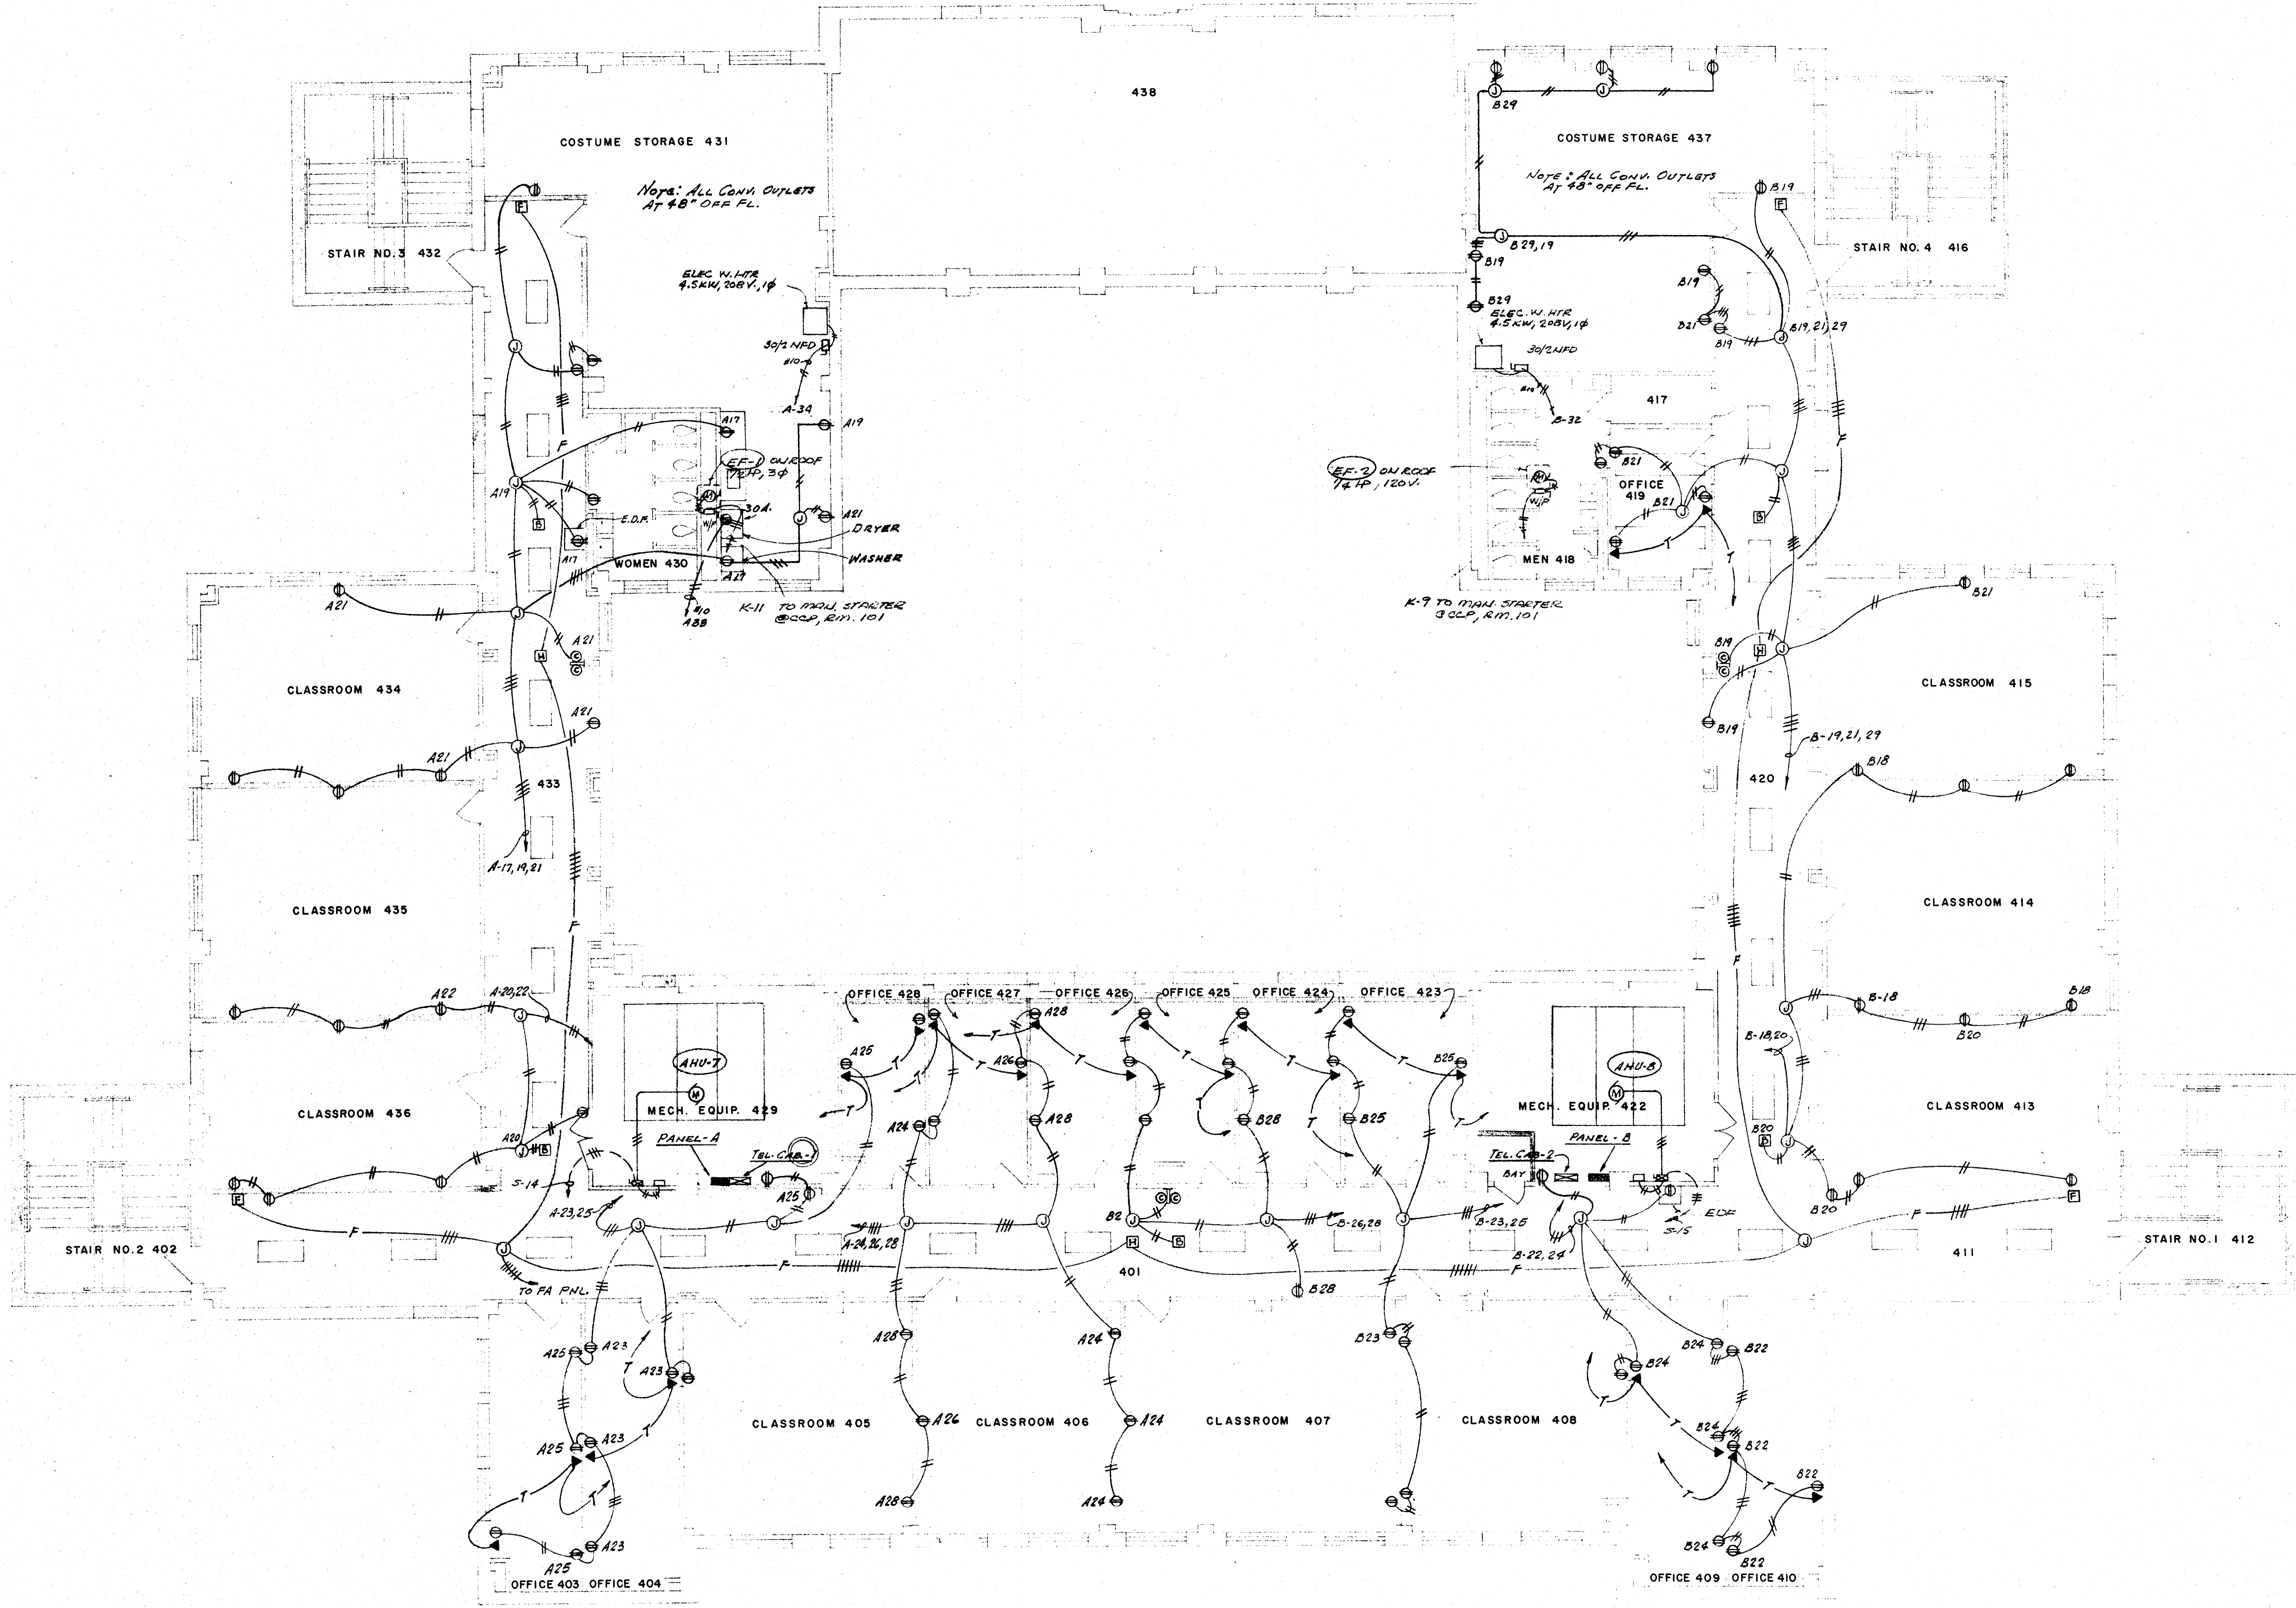

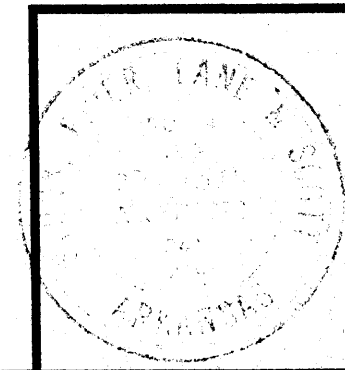
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RENOVATIONS TO
 WILSON HALL
 ARKANSAS STATE COLLEGE
 JONESBORO, ARKANSAS

STUCK, FRIER, LANE & SCOTT, INC., ARCHITECTS
 601 SOUTHWEST DRIVE • JONESBORO, ARKANSAS

SHEET NUMBER
M-17
 COMMISSION NUMBER
 43866



FOURTH FLOOR PLAN-ELECTRICAL SCALE 1/8" = 1'-0"

POWER







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MEMPHIS, TENNESSEE

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RENOVATIONS TO
WILSON HALL
ARKANSAS STATE COLLEGE
JONESBORO, ARKANSAS

STUCK, FRIER, LANE & SCOTT, INC., ARCHITECTS
601 SOUTHWEST DRIVE • JONESBORO, ARKANSAS

SHEET NUMBER
M-18
COMMISSION NUMBER
43866

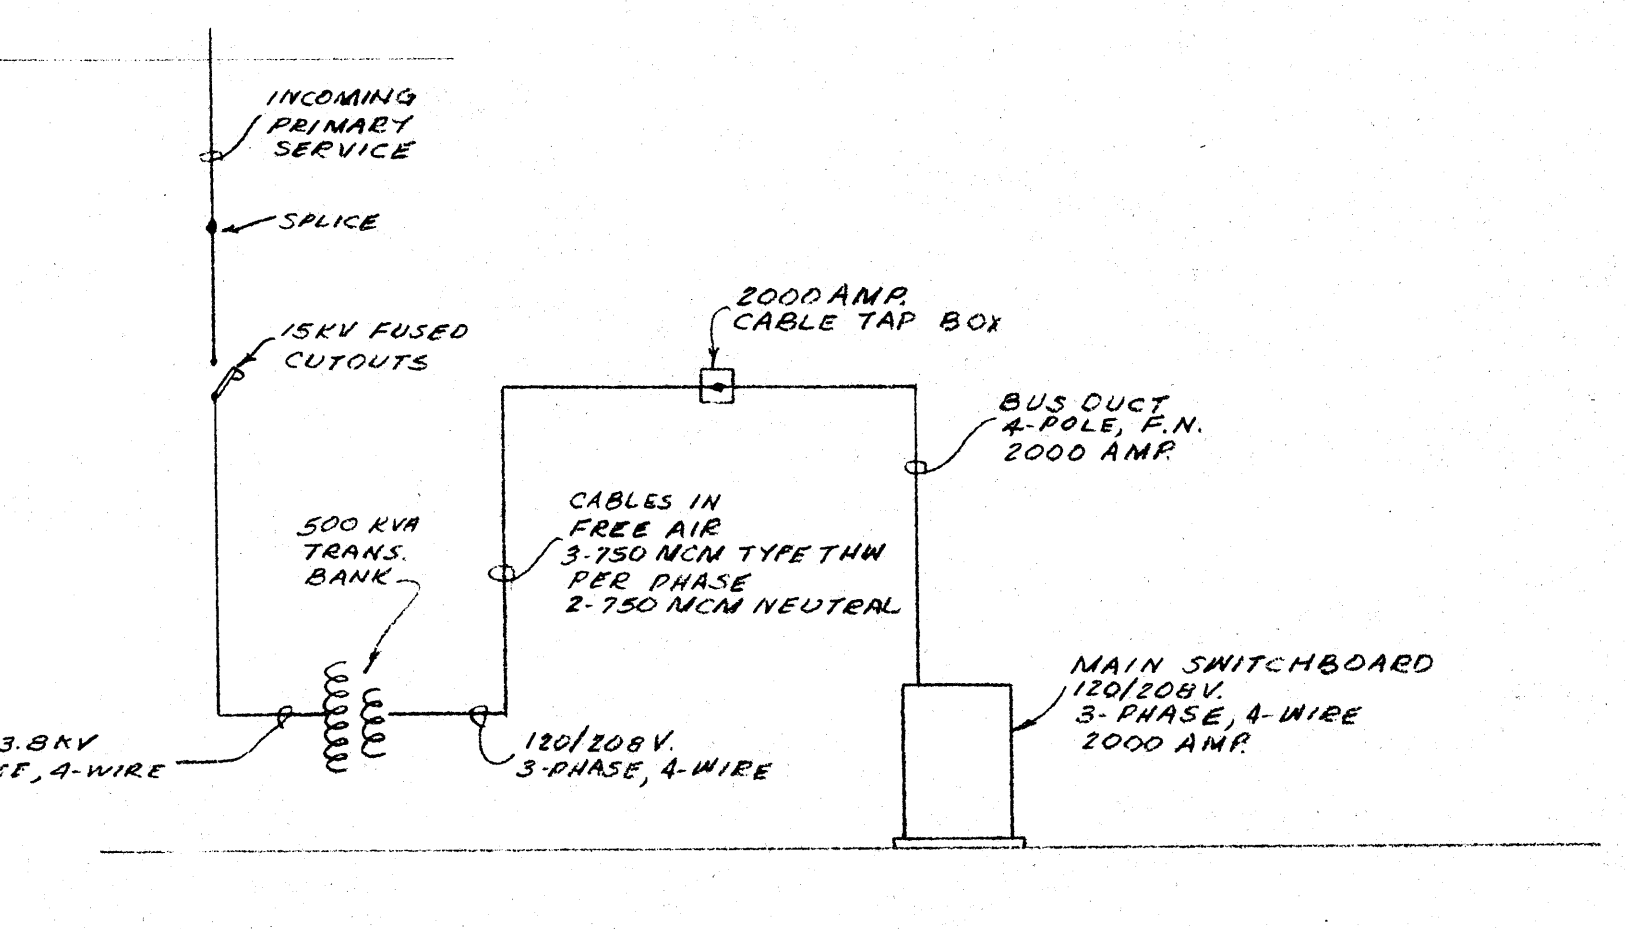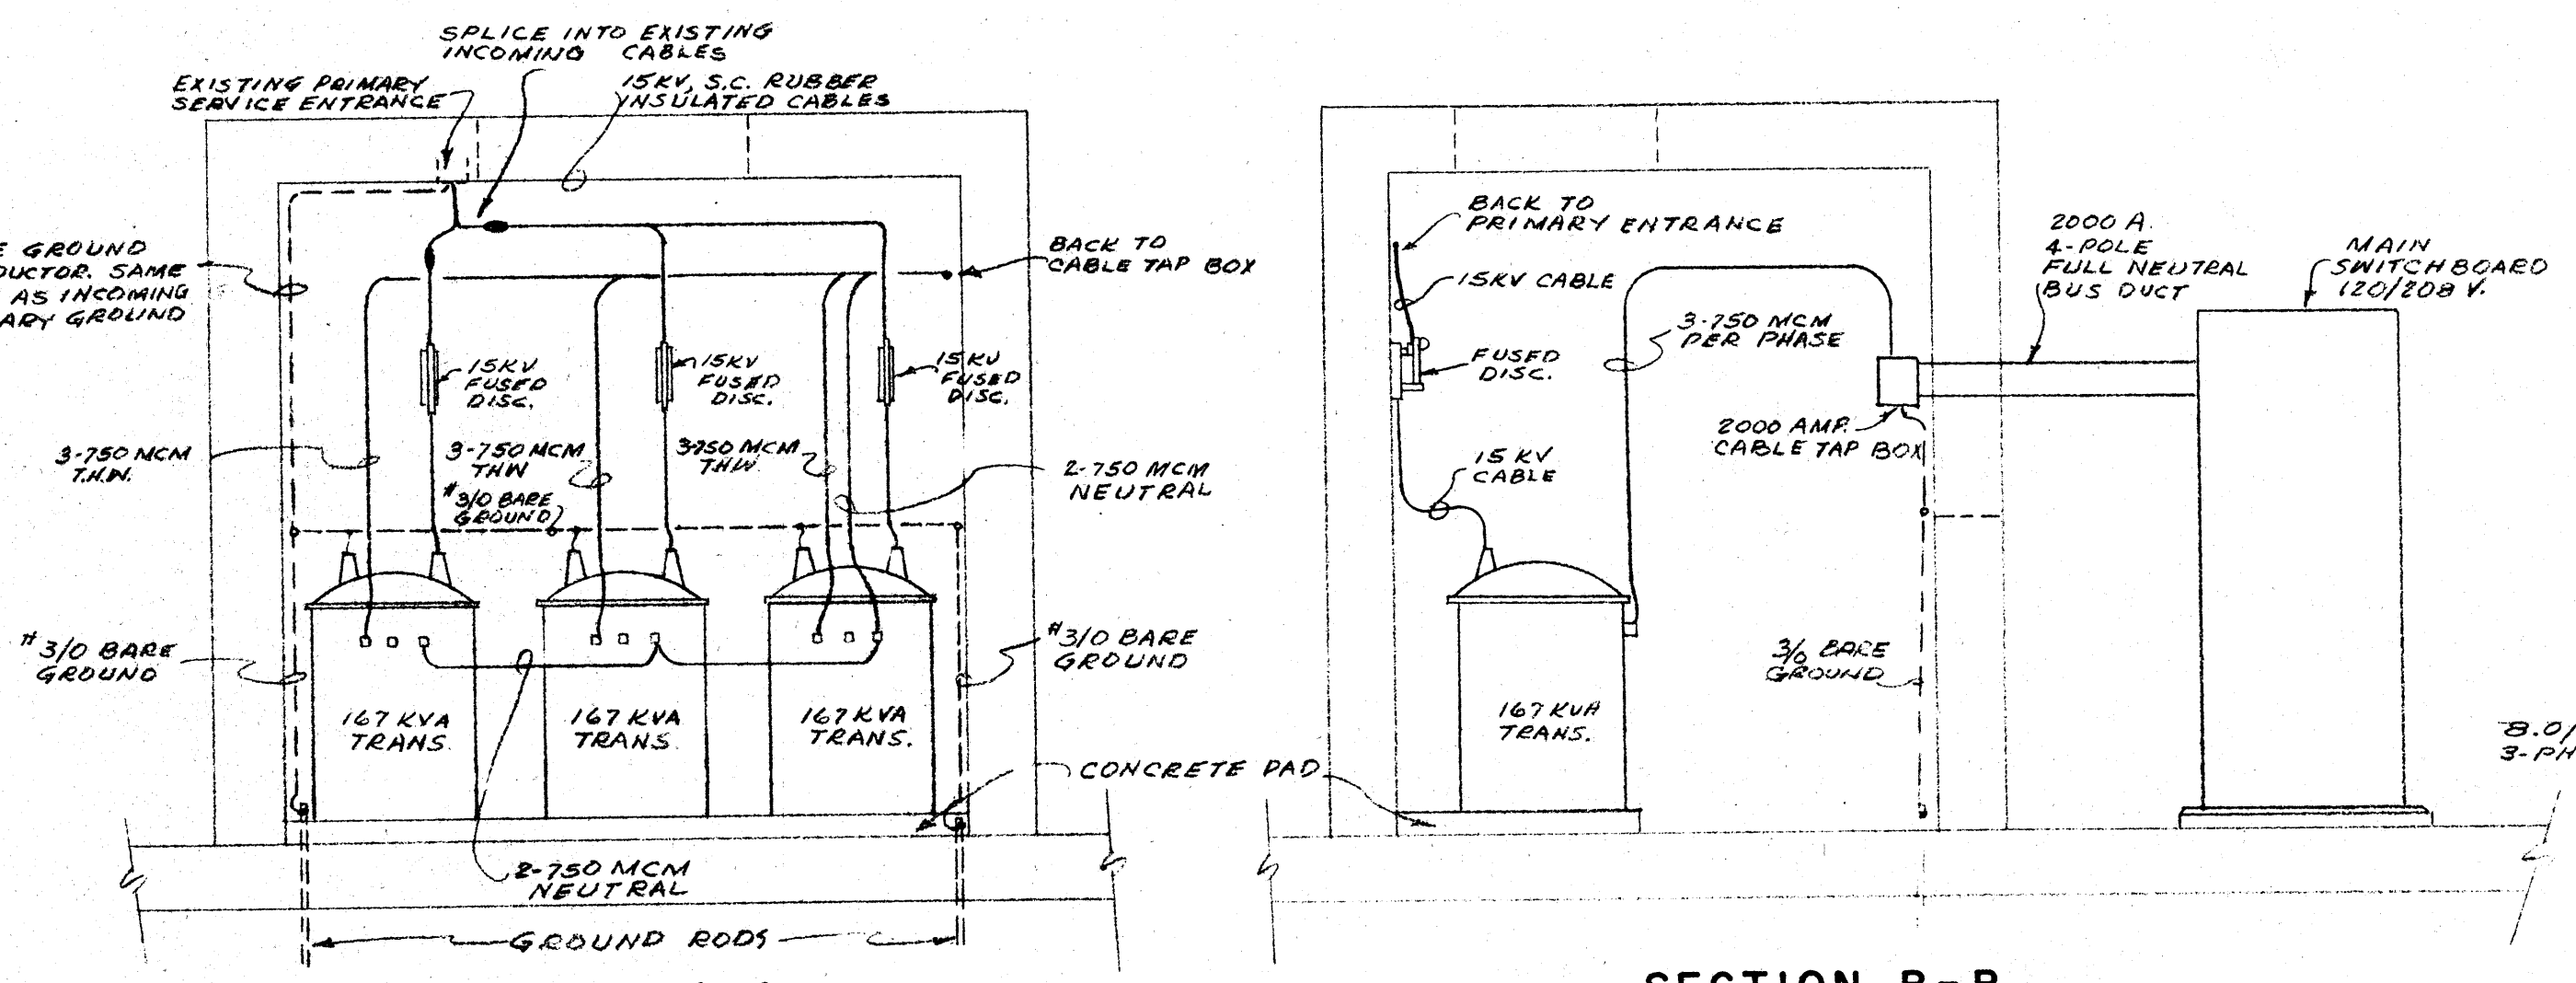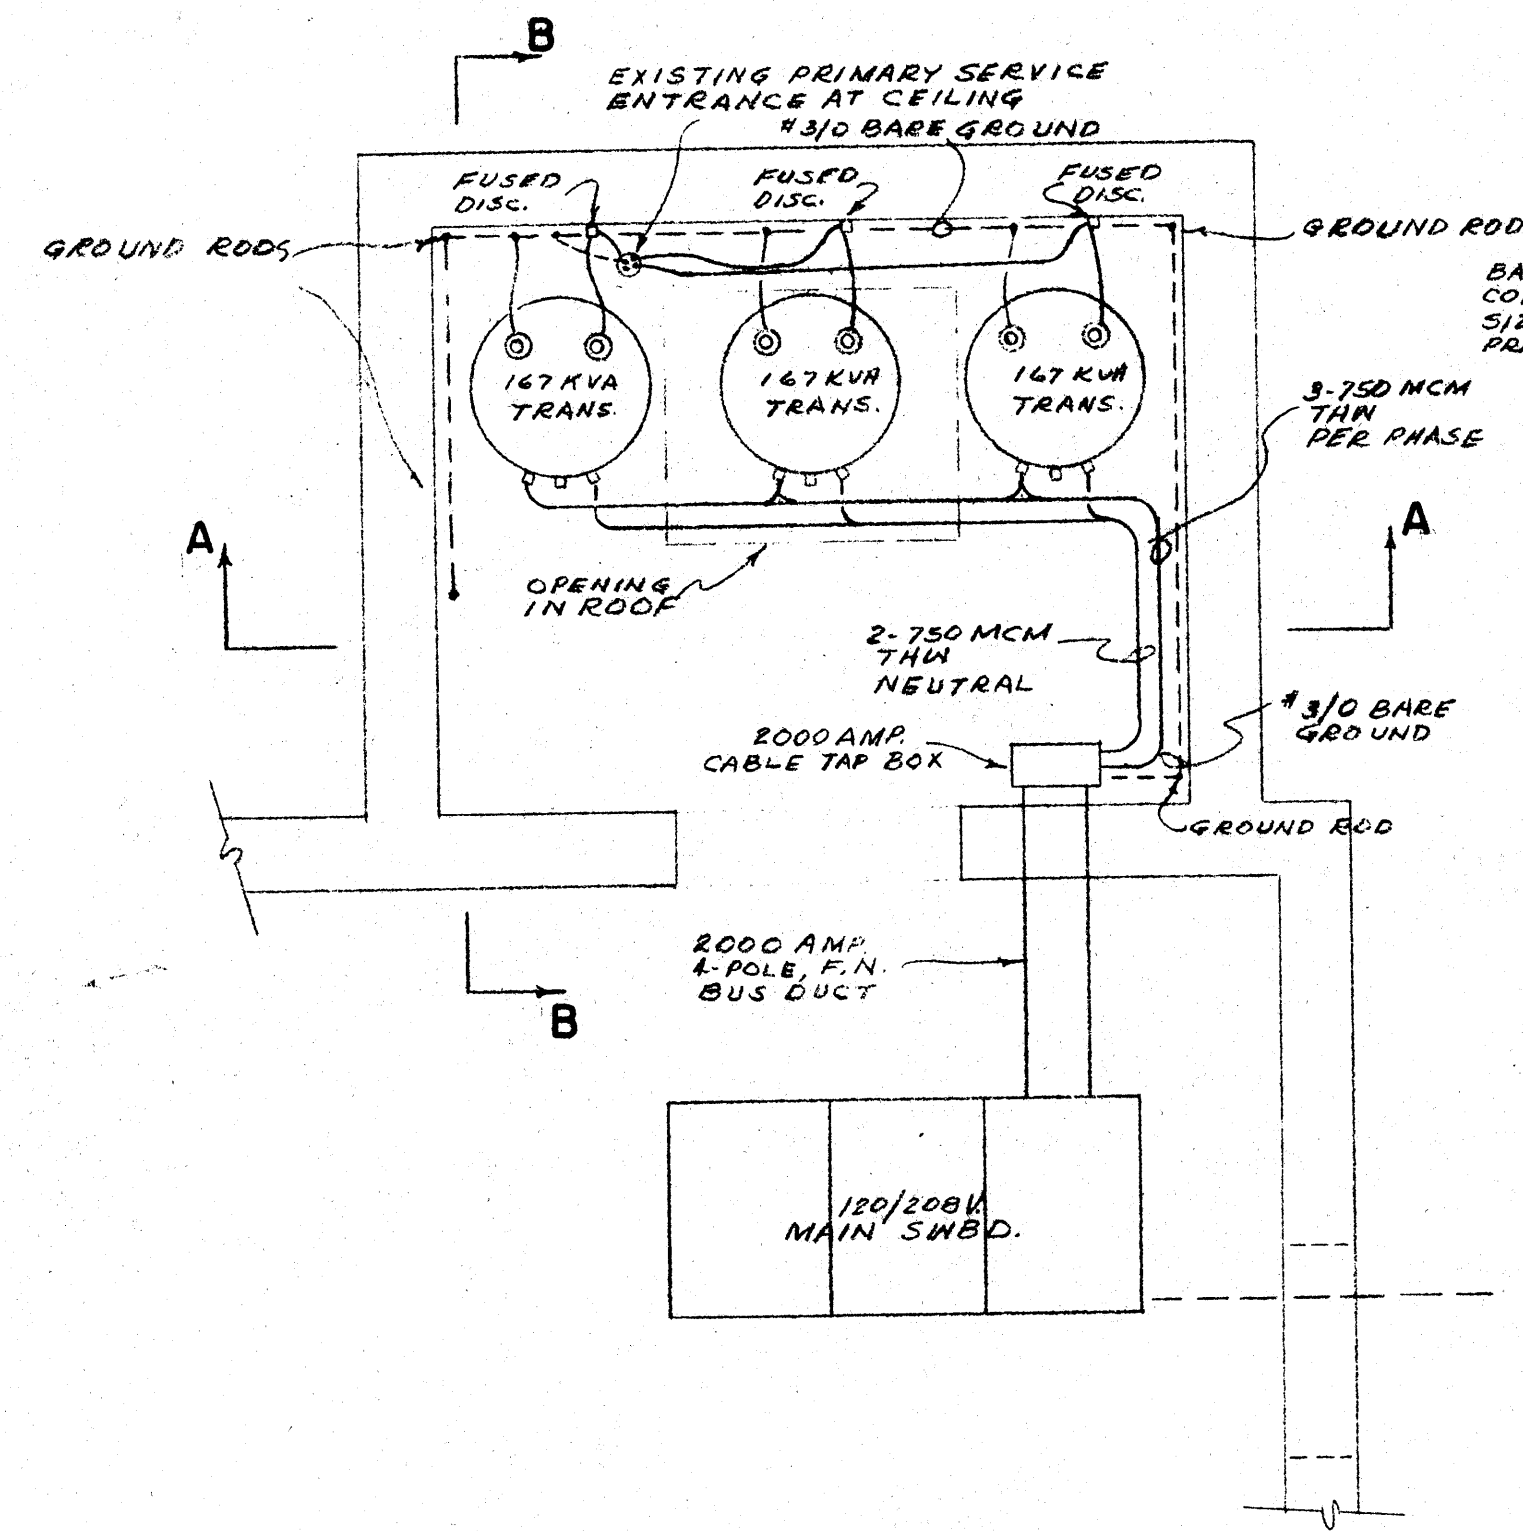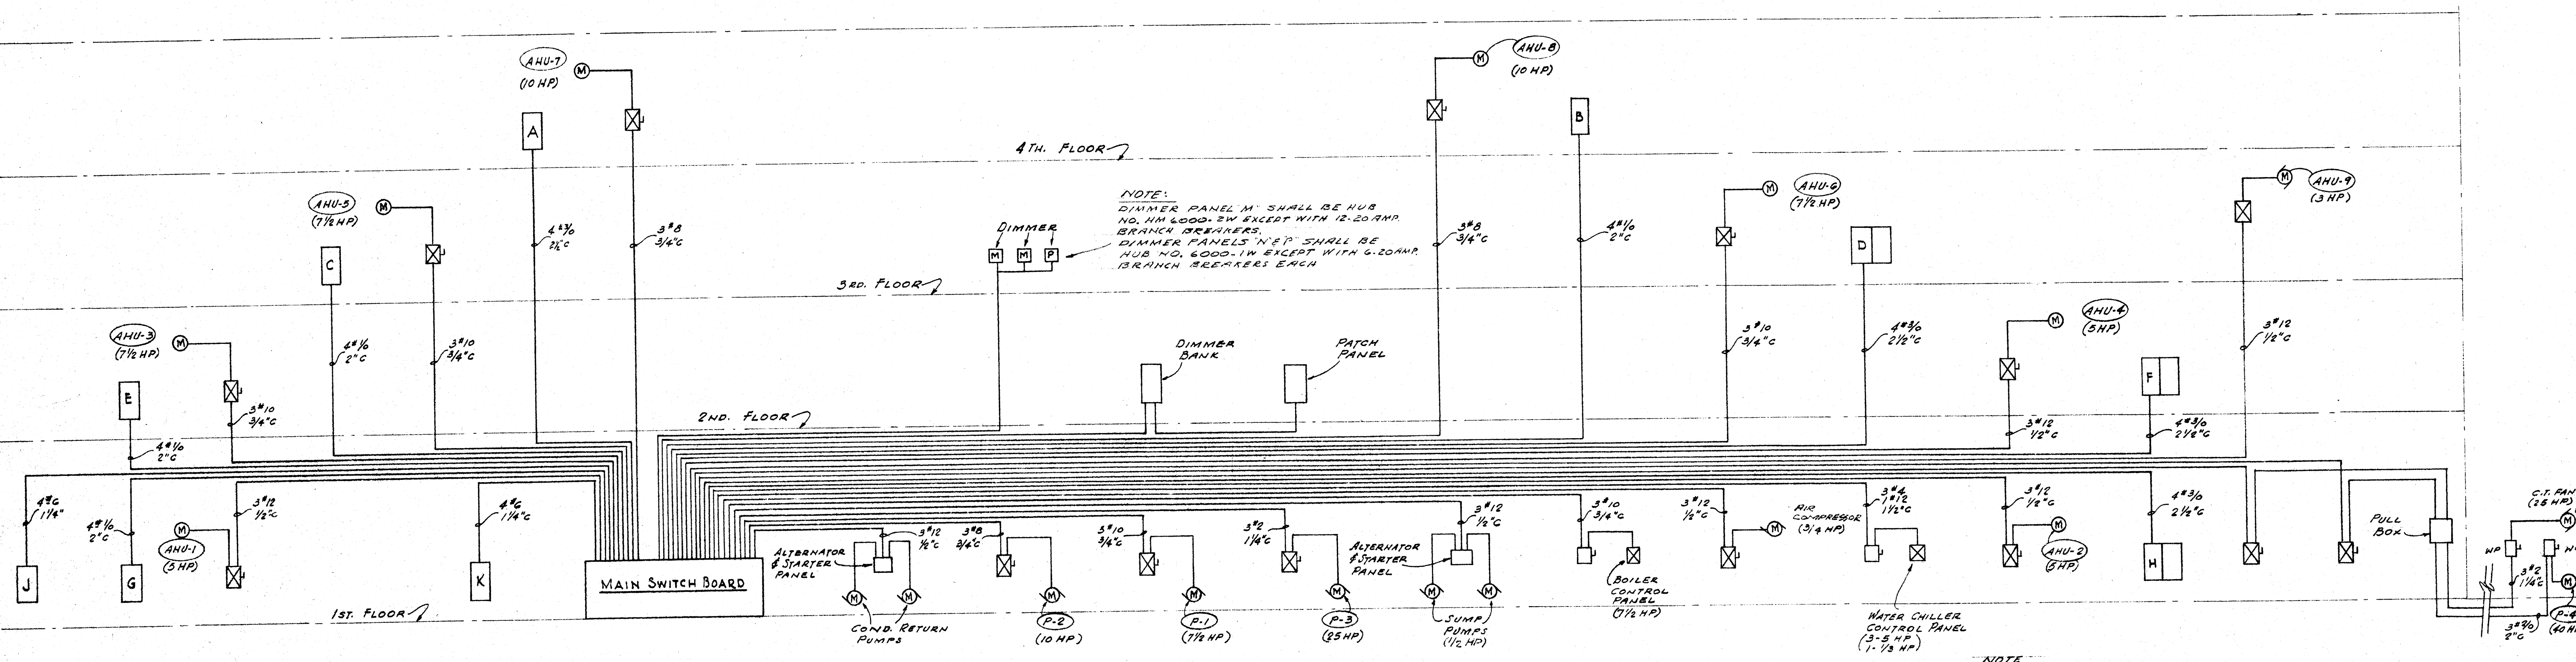


PLAN OF TRANSFORMER VAULT AND MAIN SWITCHBOARD
SCALE 3/8" = 1'-0"

SECTION A-A
SCALE 3/8" = 1'-0"

SECTION B-B
SCALE 3/8" = 1'-0"

SCHEMATIC DIAGRAM OF MAIN SERVICE
NO SCALE

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MEMPHIS, TENNESSEE

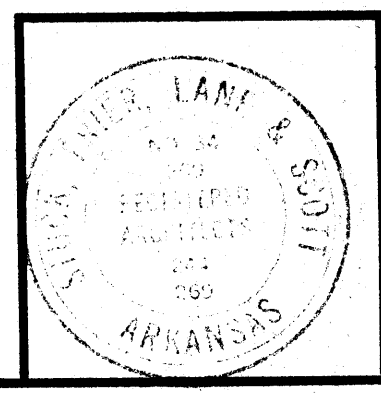

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RENOVATIONS TO
WILSON HALL
ARKANSAS STATE COLLEGE
JONESBORO, ARKANSAS


STUCK, FRIER, LANE & SCOTT, INC., ARCHITECTS
601 SOUTHWEST DRIVE • JONESBORO, ARKANSAS

SHEET NUMBER
M-19
COMMISSION NUMBER
43800

LIGHTING FIXTURE SCHEDULE					
FIXTURE DESIG.	TYPE	LAMPS	FINISH	MOUNTING	SPECIFICATIONS
B	FLUORESCENT	8-40W T-12, RS, CW	BAKED WHITE ENAMEL	12" SINGLE STEM HANGERS	96" LOWERED FIXTURE WITH STEEL SIDE PANELS LITHONIA NO. BT CL 240 M
B'	FLUORESCENT	4-40W T-12, RS, CW	BAKED WHITE ENAMEL	12" SINGLE STEM HANGERS	48" LOWERED FIXTURE WITH STEEL SIDE PANELS LITHONIA NO. CL 440 M
C	FLUORESCENT	4-40W T-12, RS, CW	BAKED WHITE ENAMEL	12" SINGLE STEM HANGERS	96" LOWERED FIXTURE WITH STEEL SIDE PANELS LITHONIA NO. BT CL 240 M
C'	FLUORESCENT	2-40W T-12, RS, CW	BAKED WHITE ENAMEL	12" SINGLE STEM HANGERS	48" LOWERED FIXTURE WITH STEEL SIDE PANELS LITHONIA NO. CL 240 M
D	INCAND'T.	2-100W	SATIN ALUMINUM	CEILING	ROUND ENCLOSING GLASS GLOBE WITH OPAL SIDES & CLEAR PRISMATIC BOTTOM PERFECLITE NO. HH-42
E	INCAND'T.	1-150W	SATIN ALUMINUM	BRACKET 7'-4" ABOVE FLOOR	DIE-CAST FIXTURE WITH ENCLOSING OPAL GLASS SPHERICAL GLOBE PERFECLITE NO. VC-55
F	FLUORESCENT	4-40W T-12, RS, CW	BAKED WHITE ENAMEL	RECESSED IN CLG.	48" FIXTURE WITH ACRYLIC PYRAMIDAL LENS LITHONIA NO. 25 440-RH
G	FLUORESCENT	2-40W T-12, RS, CW	PORCELAIN ENAMEL	12" SINGLE STEM HANGERS	96" INDUSTRIAL FIXTURE WITH APERTURED PORCELAIN REFLECTORS LITHONIA NO. BT-AF-240-PQR
H	INCAND'T.	AS REQ'D.	---	---	EXISTING FIXTURE TO BE RECONNECTED IN PLACE
I	INCAND'T.	1-150W	SATIN ALUMINUM	CEILING	DIE-CAST FIXTURE WITH ENCLOSING OPAL GLASS SPHERICAL GLOBE PERFECLITE NO. VC-54
J	INCAND'T.	1-150W	BAKED WHITE ENAMEL	RECESSED IN CLG.	SQUARE FIXTURE WITH FULL ALUMINUM REFLECTOR AND HOLOPHANE CONTROLENS PERFECLITE NO. F-1000
K	INCAND'T.	1-100W	WHITE PORCELAIN	CLG. OR WALL AS SHOWN	PORCELAIN LAMPHOLDER BRYANT NO. 5228
L	INCAND'T.	1-100W	SATIN ALUMINUM	CEILING	DIE-CAST FIXTURE WITH ENCLOSING OPAL GLASS CYLINDER GLOBE, PERFECLITE NO. VC-50 WITH GASKET FOR WATERPROOFING
M	INCAND'T.	1-500W R-57	NO CLG. FLANGE	RECESSED IN CEILING	DOWNLIGHT WITH CONCENTRIC Baffles WITH NO CEILING FLANGE, DESIGNED FOR JUST IN IN SLOPING PLASTER CEILING & DESIGNED FOR TOP RELAMPING. HUB NO. 8943-F. NOTE THAT THE VARIOUS BAYS IN WHICH THESE FIXTURES ARE TO BE INSTALLED HAVE DIFFERENT DEGREES OF SLOPE.
N	INCAND'T.	1-500W R-40 SPOT	NO CLG. FLANGE	RECESSED IN CEILING	SAME AS TYPE "M" EXCEPT SMALLER SIZE DESIGNED FOR BOTTOM RELAMPING WITH STICK HUB NO. 8940-F
P	FLUORESCENT	4-40W T-12, RS, CW	BAKED WHITE ENAMEL	CEILING SURFACE	2' x 4' UNIT. WITH VERTICAL STEEL SIDE PANELS. DRY-BRITE 3X47-775.
A	FLUORESCENT	2-40W T-12, RS, CW	BAKED WHITE ENAMEL	RECESSED IN CLG.	48" FIXTURE WITH ACRYLIC PYRAMID LENS LITHONIA NO. 25 240-RH
Q	INCAND'T.	1-200W	WHITEN.	STEM, WADERS	STANDARD RLM REFLECTOR FOR CONDUIT MFG.
X ₀	FLUORESCENT	2-8W T-5	SATIN ALUM.	BACK TO WALL	EDGE LIGHTED EXIT SIGN, 6" HIGH LETTERS INDICUL-BEY 45-RV-OF.
X _E	FLUORESCENT	2-8W T-5	SATIN ALUM.	END TO WALL	EDGE LIGHTED EXIT SIGN, 6" HIGH LETTERS, DIRECTIONAL ARROWS WHERE INDICATED 45E-OF.
R	MERCURY	1-100W H9	SATIN ALUM.	WALL	CAST ALUM. W/HOOD. MCPHILSEN NO. 7-14
S	INCAND'T.	4-100W	PORCELAIN	SEE A-20	PORCELAIN CABLETTE, P&S NO. 1700 W/M/MC


SCHEDULE OF BREAKERS IN MAIN SWITCHBOARD				
BREAKER DESIG.	NO. POLES	FRAME SIZE	TRIP RATING	LOAD SERVED & REMARKS
1	3	100A	20A	COND. SET, 2-34 HP
2	3	100A	70A	P-2, 10 HP
3	3	100A	50A	D-1, 7 1/2 HP
4	3	100A	50A	WATER CHILLER, 3 SHP FUSHP
5	3	100A	15A	SUMP PUMP, 2 1/2 HP
6	3	100A	50A	BOILER FAN, 7 1/2 HP
7	3	100A	15A	COMP. 3/4 HP
8	3	100A	30A	AHU-1, 5 HP
9	3	100A	30A	AHU-2, 5 HP
10	3	100A	50A	AHU-3, 7 1/2 HP
11	3	100A	30A	AHU-4, 5 HP
12	3	100A	50A	AHU-5, 7 1/2 HP
13	3	100A	50A	AHU-6, 7 1/2 HP
14	3	100A	70A	AHU-7, 10 HP
15	3	100A	70A	AHU-8, 10 HP
16	3	100A	20A	AHU-9, 3 HP
17	3	225A	175A	PANEL A
18	3	100A	100A	PANEL B
19	3	100A	100A	PANEL C
20	3	100A	50A	PANEL D
21	3	100A	50A	PANEL E
22, 23, 24	3	100A	---	PROVISIONS ONLY FOR FUTURE BREAKERS
25	3	225A	125A	PANEL F
26	3	225A	175A	PANEL G
27	3	225A	125A	PANEL H
28	3	225A	175A	PANEL I
29	3	225A	175A	PANEL J
30	3	225A	125A	DINNER PANELS M, N, P
31	3	225A	150A	F-3, 25 HP
32	3	225A	150A	C.T. FAN, 25 HP
33	3	225A	225A	F-4, 40 HP
34, 35	3	225A	---	PROVISION ONLY FOR FUTURE BREAKERS
36	3	200A	500A	STAGE DIMMER L
37	3	2000A	2000A	MAIN BREAKER

PANELBOARD SCHEDULE									
PANEL DESIG.	MOUNTING	SYSTEM	MAINS	BRANCH CIRCUIT BREAKERS					
				NO.	POLES	TRIP	CONNECTED LOAD & CIRCUIT NO'S.		
A	SURFACE	120/208V. 3-PHASE 4-WIRE	225A M.L.O.	17	1	15A	LTG. CKTS. 1-16, 18		
				15	1	20A	MISC. POWER CKTS. 17, 19-26, 28 SPARE CKTS. 27, 29-32		
B	SURFACE	120/208V. 3-PHASE 4-WIRE	100A M.L.O.	2	2	20A 30A	WATER HTR. Ckt 34, DRYER Ckt. 33		
				19	1	15A	LTG. CKTS. 1-16, 20		
C	SURFACE	120/208V. 3-PHASE 4-WIRE	225A M.L.O.	14	1	20A	MISC. POWER CKTS. 19, 20-26, 27, 28 SPARE CKTS. 29-31, 33, 34		
				1	2	20A	WATER HTR. Ckt. 32		
D	2-SECTION PANEL	120/208V. 3-PHASE 4-WIRE	225A M.L.O.	24	1	15A	LTG. CKTS. 1-19, 35, 36, 38		
				18	1	20A	MISC. POWER CKTS. 20-32 SPARE CKTS. 37, 39-42		
E	SURFACE	120/208V. 3-PHASE 4-WIRE	225A M.L.O.	24	1	15A	LTG. CKTS. 1-22, 24, 26		
				18	1	20A	MISC. POWER CKTS. 23, 25, 27-31, 39, 41 SPARE CKTS. 35, 40, 42		
F	2-SECTION PANEL	120/208V. 3-PHASE 4-WIRE	225A M.L.O.	25	1	15A	LTG. CKTS. 1-22, 50, 52, 54		
				31	1	20A	MISC. POWER CKTS. 24-49 SPARE CKTS. 23, 51, 53, 55, 56		
G	SURFACE	120/208V. 3-PHASE 4-WIRE	100A M.L.O.	17	1	15A	LTG. CKTS. 1-13, 27-30		
				13	1	20A	MISC. POWER CKTS. 14-21 SPARE CKTS. 22-26		
H	FLUSH	120/208V. 3-PHASE 4-WIRE	225A M.L.O.	28	1	15A	LTG. CKTS. 1-21, 41, 43, 45, 47, 49, 51, 52		
				28	1	20A	MISC. POWER CKTS. 29-40, 44 SPARE CKTS. 22, 42, 44, 48		
J	SURFACE	120/208V. 3-PHASE 4-WIRE	100A M.L.O.	1	2	20A	208V. RECEPT. 50		
				10	1	20A	MISC. POWER CKTS. 7-11 SPARE CKTS. 12-16		
K	SURFACE	120/208V. 3-PHASE 4-WIRE	100A M.L.O.	2	1	15A	LTG. CKTS. 1-6		
				11	1	20A	MISC. POWER CKTS. 3, 5, 6, 7, 9 SPARE CKTS. 1, 8, 10, 12, 13, 14		
DINNER PANEL M	SURFACE	120/208V. 1-PHASE 3-WIRE	50A MAIN BRK.	12	1	20A	LTG. CKTS. 1-12		
				6	1	20A	LTG. CKTS. 1-6		
DINNER PANEL N	SURFACE	120V. 1-PHASE 3-WIRE	50A MAIN BRK.	6	1	20A	LTG. CKTS. 1-6		
				6	1	20A	LTG. CKTS. 1-6		
DINNER PANEL P	SURFACE	120/208V. 1-PHASE 3-WIRE	100A M.L.O.	2	1	15A	ALL EXIT LIGHTING & ONE SPARE		
				1	2	30A	P.A. PANEL		

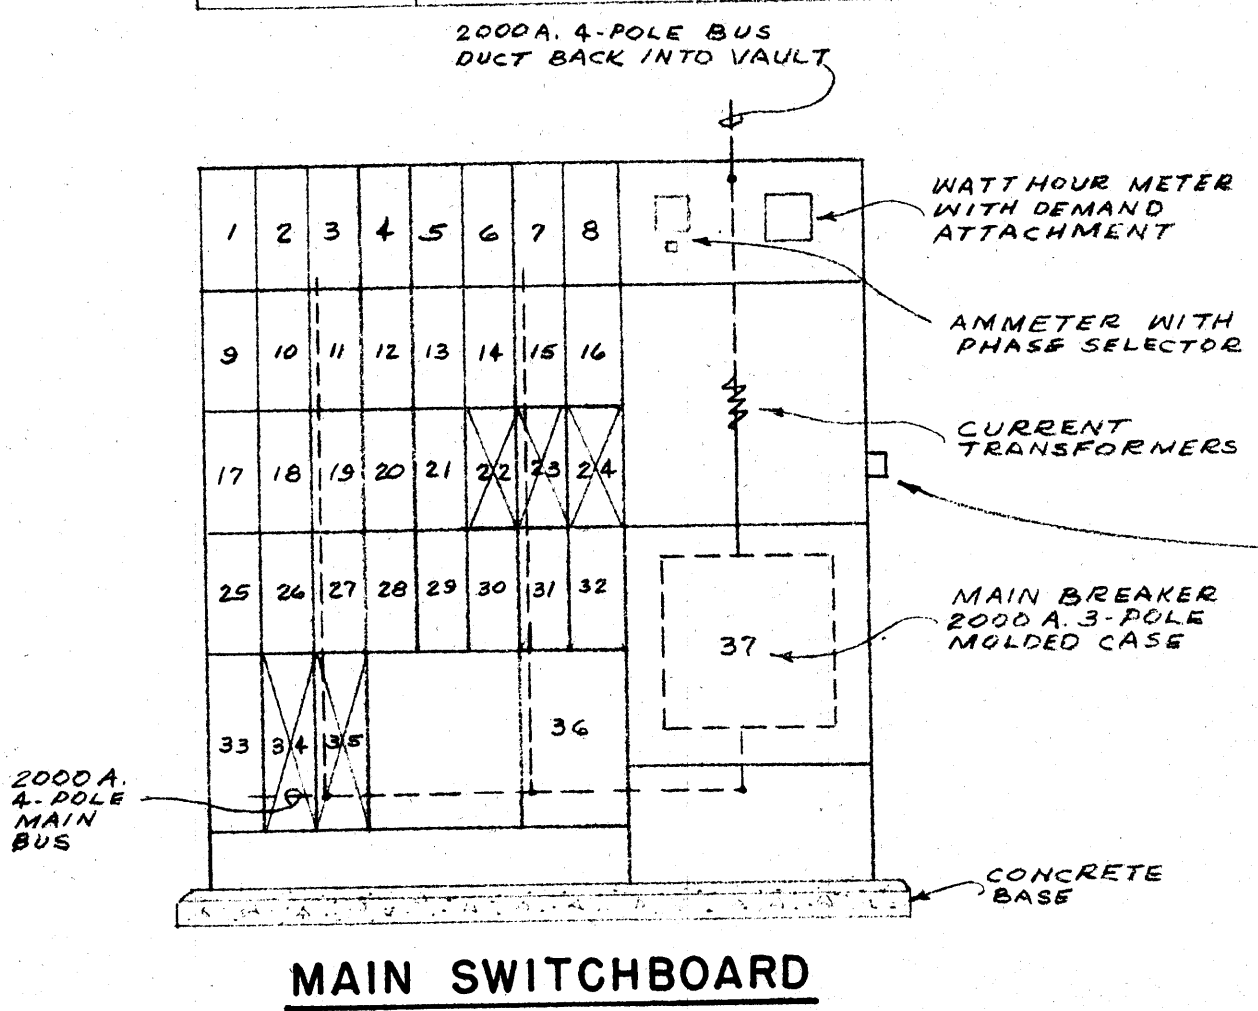

NOTE:
INSTALL 30A, 2 POLE FUSED DISC. ON SIDE OF SWBD. AND CONNECT AHEAD OF MAIN BRK. CONNECT ALL EXIT LIGHTS & FIRE ALARM PANEL TO (4) Ckt. PANEL MOUNTED ADJACENT TO THIS DISCONNECT. PAINT DISC. & PANEL RED & STENCIL "EXIT LIGHTING & FIRE ALARM" ON DISC.

ELECTRICAL LEGEND	
○	FLUORESCENT LIGHTING FIXTURE
⊙	INCANDESCENT LIGHTING FIXTURE
⊕	INCANDESCENT LIGHTING FIXTURE, BRACKET MOUNTED
⊗	EXIT LIGHT
1-S (SK)	WALL SWITCH, SPST (KEY OPERATED)
1-S ₂ (SK)	WALL SWITCH, DPST (" " " ")
1-S ₃ (SK)	WALL SWITCH, 3-WAY (" " " ")
1-S ₄ (SK)	WALL SWITCH, 4-WAY (" " " ")
⊖	DUPLEX RECEPTACLE
⊕	208 VOLT RECEPTACLE
⊙	FLOOR RECEPTACLE, RUSSELL & STOLL TYPE AF02 FLOOR EXTENSION WITH NO. 3052G FLOOR FITTING. INSTALL 4" SQUARE OUTLET BOX BELOW FLOOR, ADJACENT TO EXTENSION THROUGH FLOOR. USE GREENFIELD CONNECTION BETWEEN FLOOR EXTENSION & OUTLET BOX. WHERE DOUBLE DUPLEX RECEPTACLES ARE INDICATED, USE NO. 2645G FLOOR FITTING.
⊕	STUB-UP FROM FLOOR IN LANGUAGE LAB, ROOM 327, WITH SAME DEVICES AS FOR FLOOR RECEPTACLE, SYMBOL ⊕, EXCEPT USE 3/4" X 2" CONDUIT RISER IN LIEU OF FLOOR FITTING.
⊕	FLOOR TELEPHONE OUTLET. SAME AS FLOOR RECEPTACLE EXCEPT USE NO. 3058 FLOOR FITTING.
▽	WALL TELEPHONE OUTLET
⊕	CONNECTION TO MOTOR
1-SM	MANUAL STARTER
⊖	DISCONNECT SWITCH
⊖	MAGNETIC STARTER
⊖	COMBINATION MAGNETIC STARTER & DISCONNECT SWITCH.
⊖	FIRE ALARM BREAK GLASS STATION
⊖	FIRE ALARM HORN - RECESSED TYPE, IN CEILING.
⊖	PERIOD BELL
⊖	SINGLE DIAL CLOCK
⊖	DOUBLE DIAL CLOCK
—	CONDUIT CONCEALED ABOVE FURRED CEILING
—	CONDUIT UNDER FLOOR & ABOVE FURRED CEILING BELOW
—	EXPOSED CONDUIT
— T —	TELEPHONE CONDUIT; MINIMUM 3/4" W/ PULL WIRE
— F —	FIRE ALARM CONDUIT
— TV —	TELEVISION CONDUIT; ALL 3/4", 4 1/8" SQ. BOX 1 1/2 GANG BLANK PLATE
⊕	CONDUIT JUNCTION BOX
1-SK	REMOTE RAISE-LOWER SWITCHES FOR MOTORIZED DIMMERS.

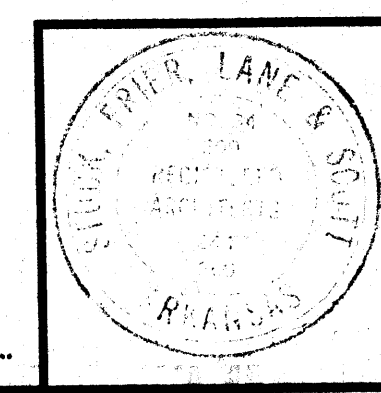


DATE: 2-21-66
DRAWN BY: RL
CHECKED BY:
REVISIONS:

RENOVATIONS TO
WILSON HALL
ARKANSAS STATE COLLEGE
JONESBORO, ARKANSAS
STUCK, FRIER, LANE & SCOTT, INC., ARCHITECTS
601 SOUTHWEST DRIVE • JONESBORO, ARKANSAS


SHEET NUMBER
M-20
COMMISSION NUMBER
4366

Office of GRIFFITH C. BURR
CONSULTING ENGINEERS
MEMPHIS, TENNESSEE

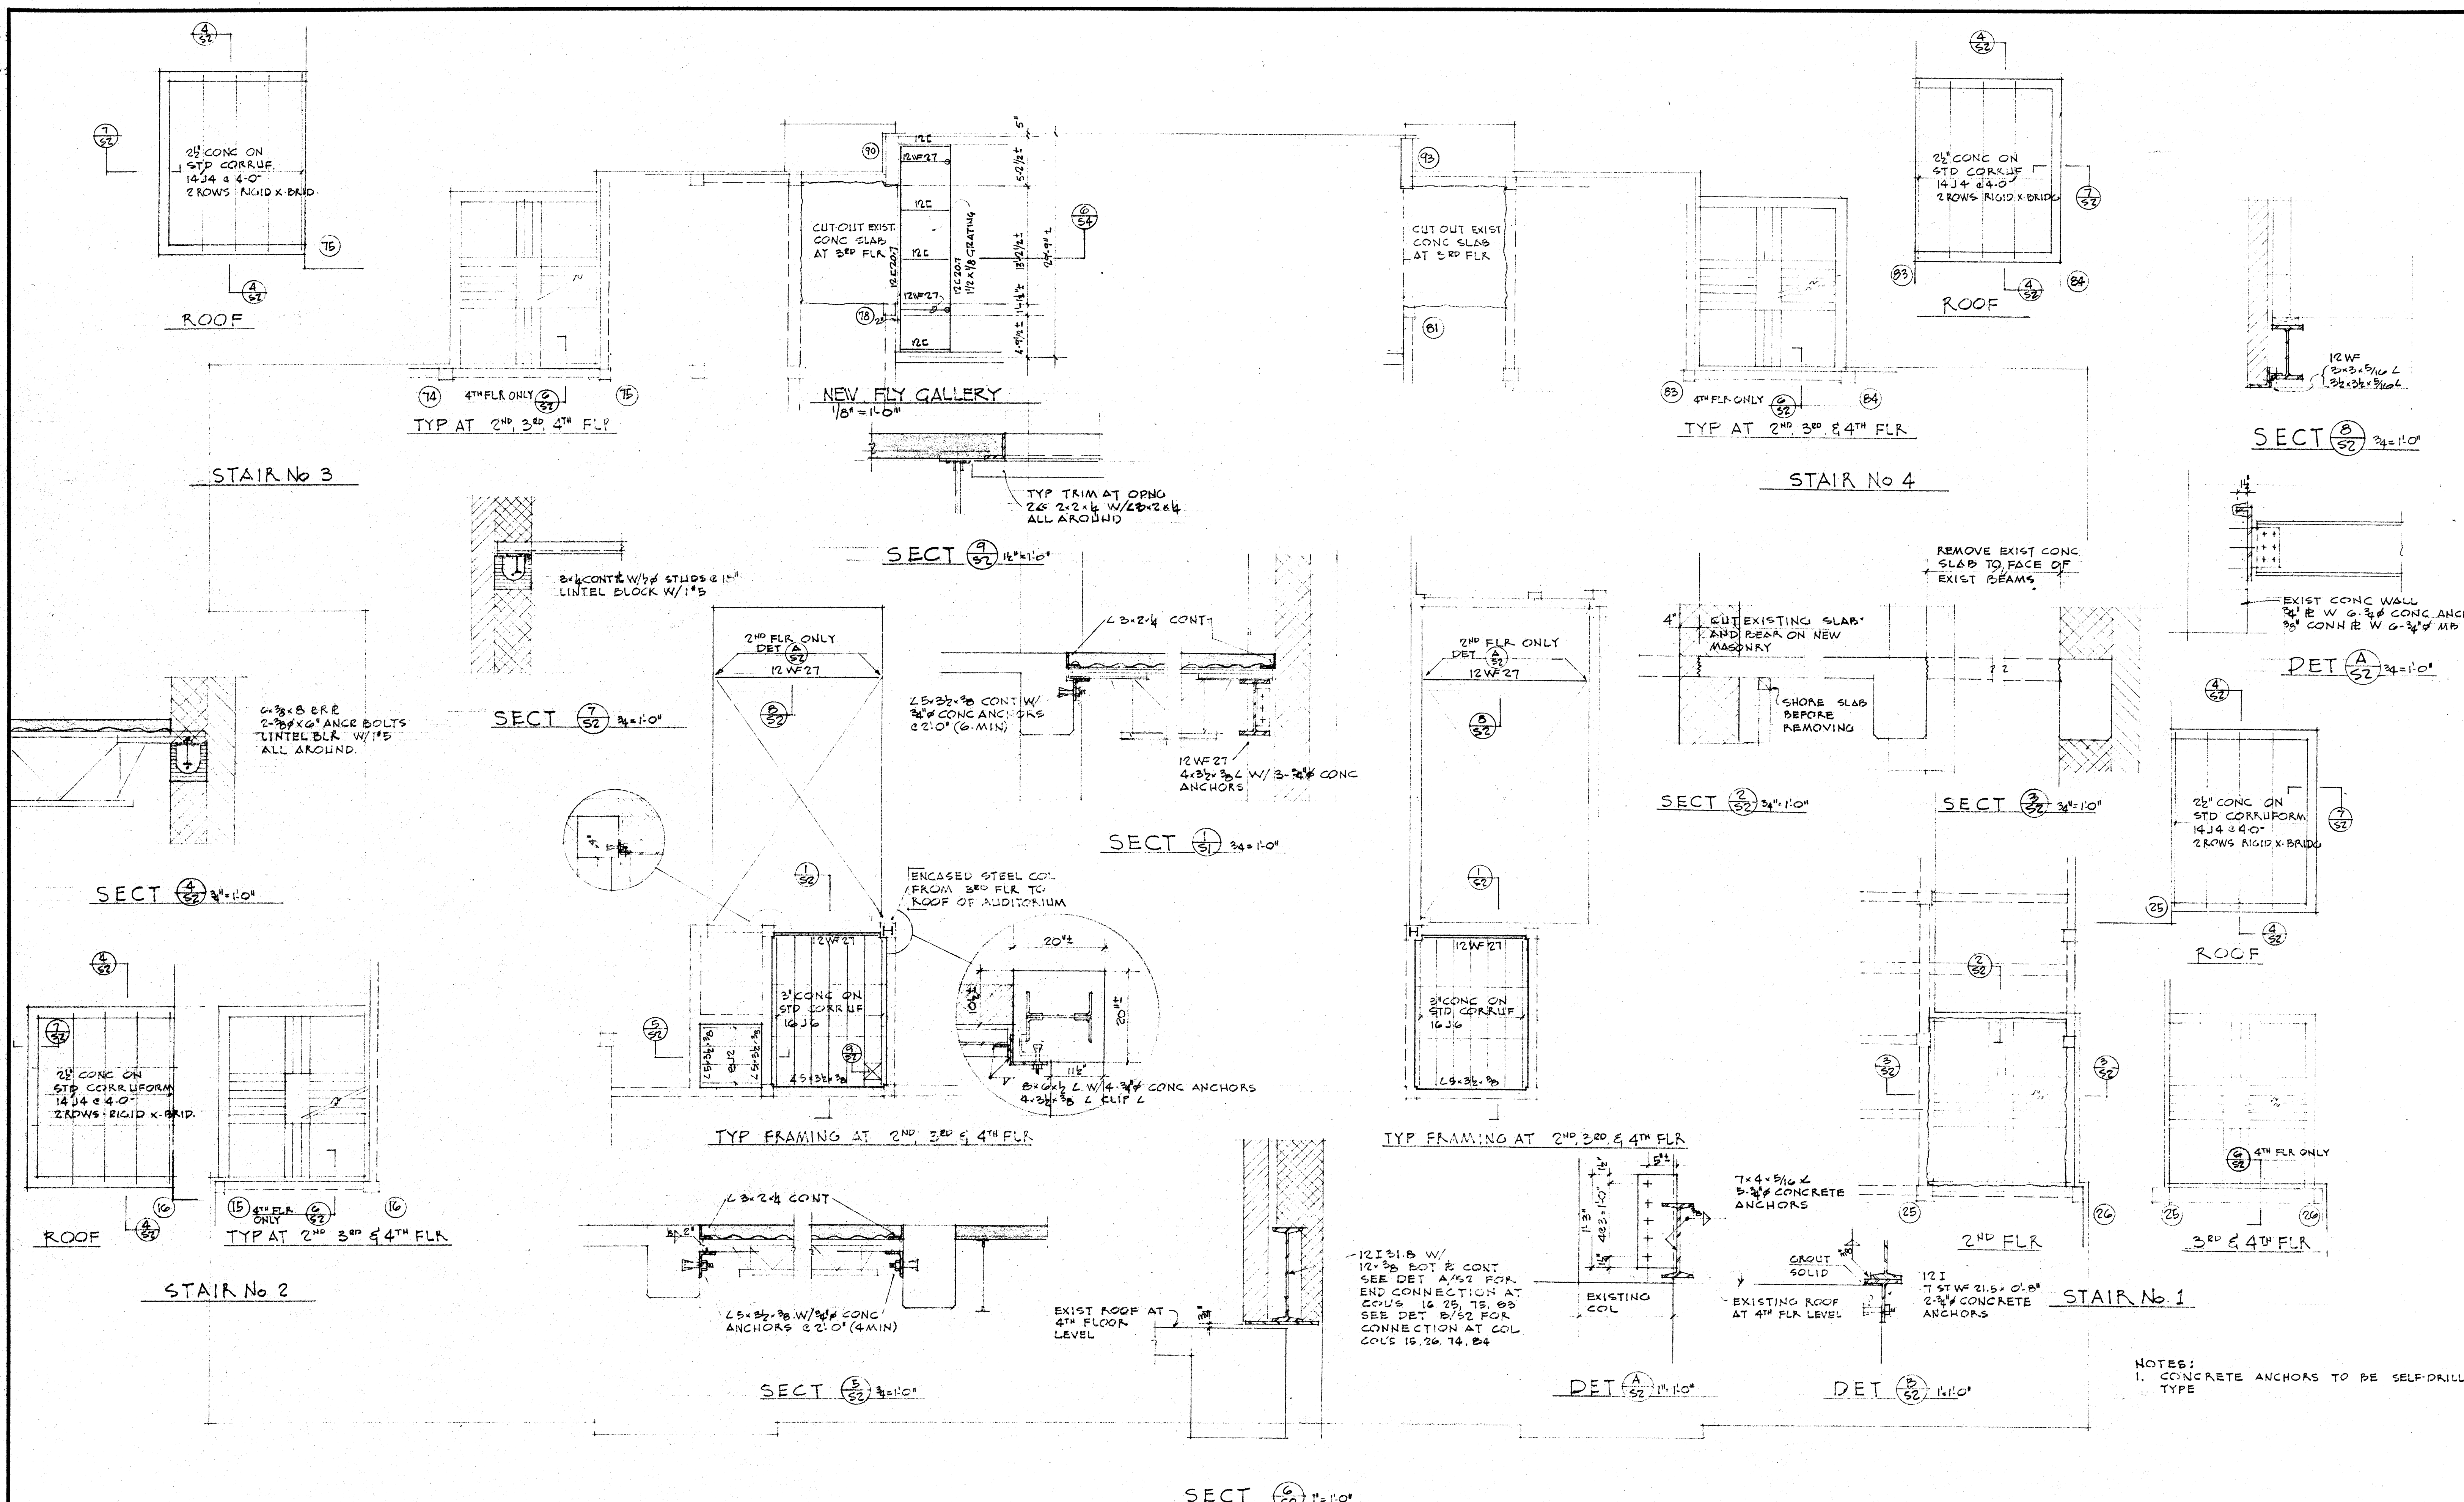


NOTES:
 1. CONCRETE ANCHORS TO BE SELF-DRILL TYPE

	DATE 2.21.66	RENOVATIONS TO WILSON HALL ARKANSAS STATE COLLEGE JONESBORO, ARKANSAS	SHEET NUMBER S-2
	DRAWN BY	STUCK, FRIER, LANE & SCOTT, INC., ARCHITECTS	COMMISSION NUMBER 43366
	CHECKED BY	601 SOUTHWEST DRIVE • JONESBORO, ARKANSAS	
	REVISIONS		

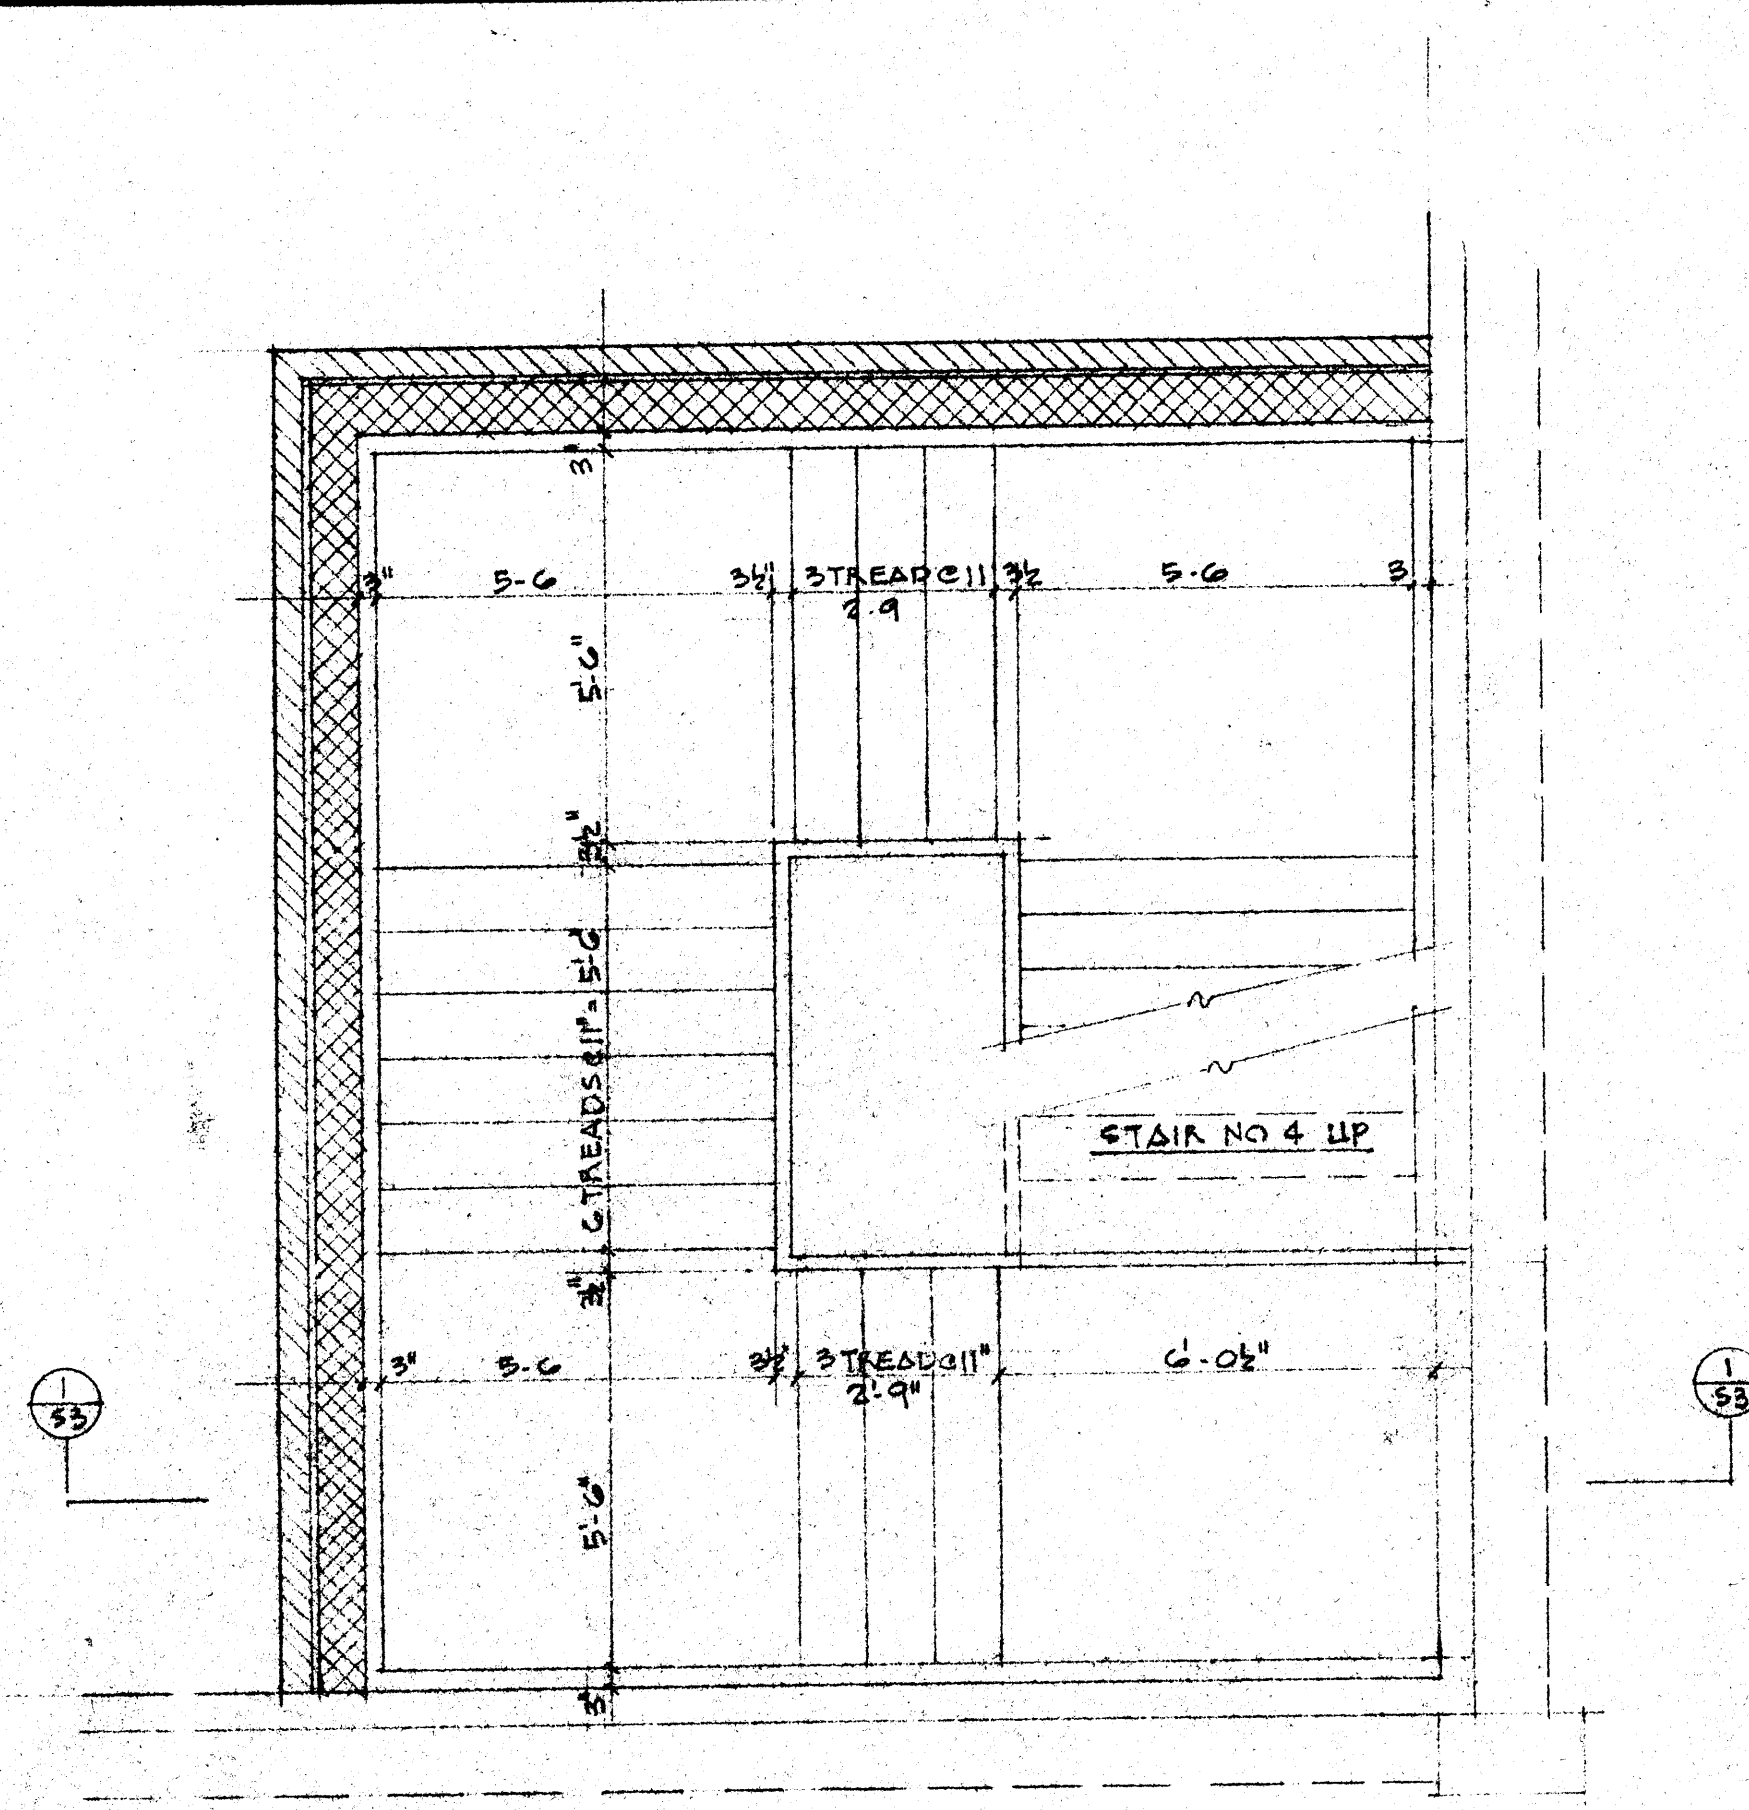


4TH FLOOR STAIR #2 E 3
STAIR #1 E 4 OPPOSITE HAND

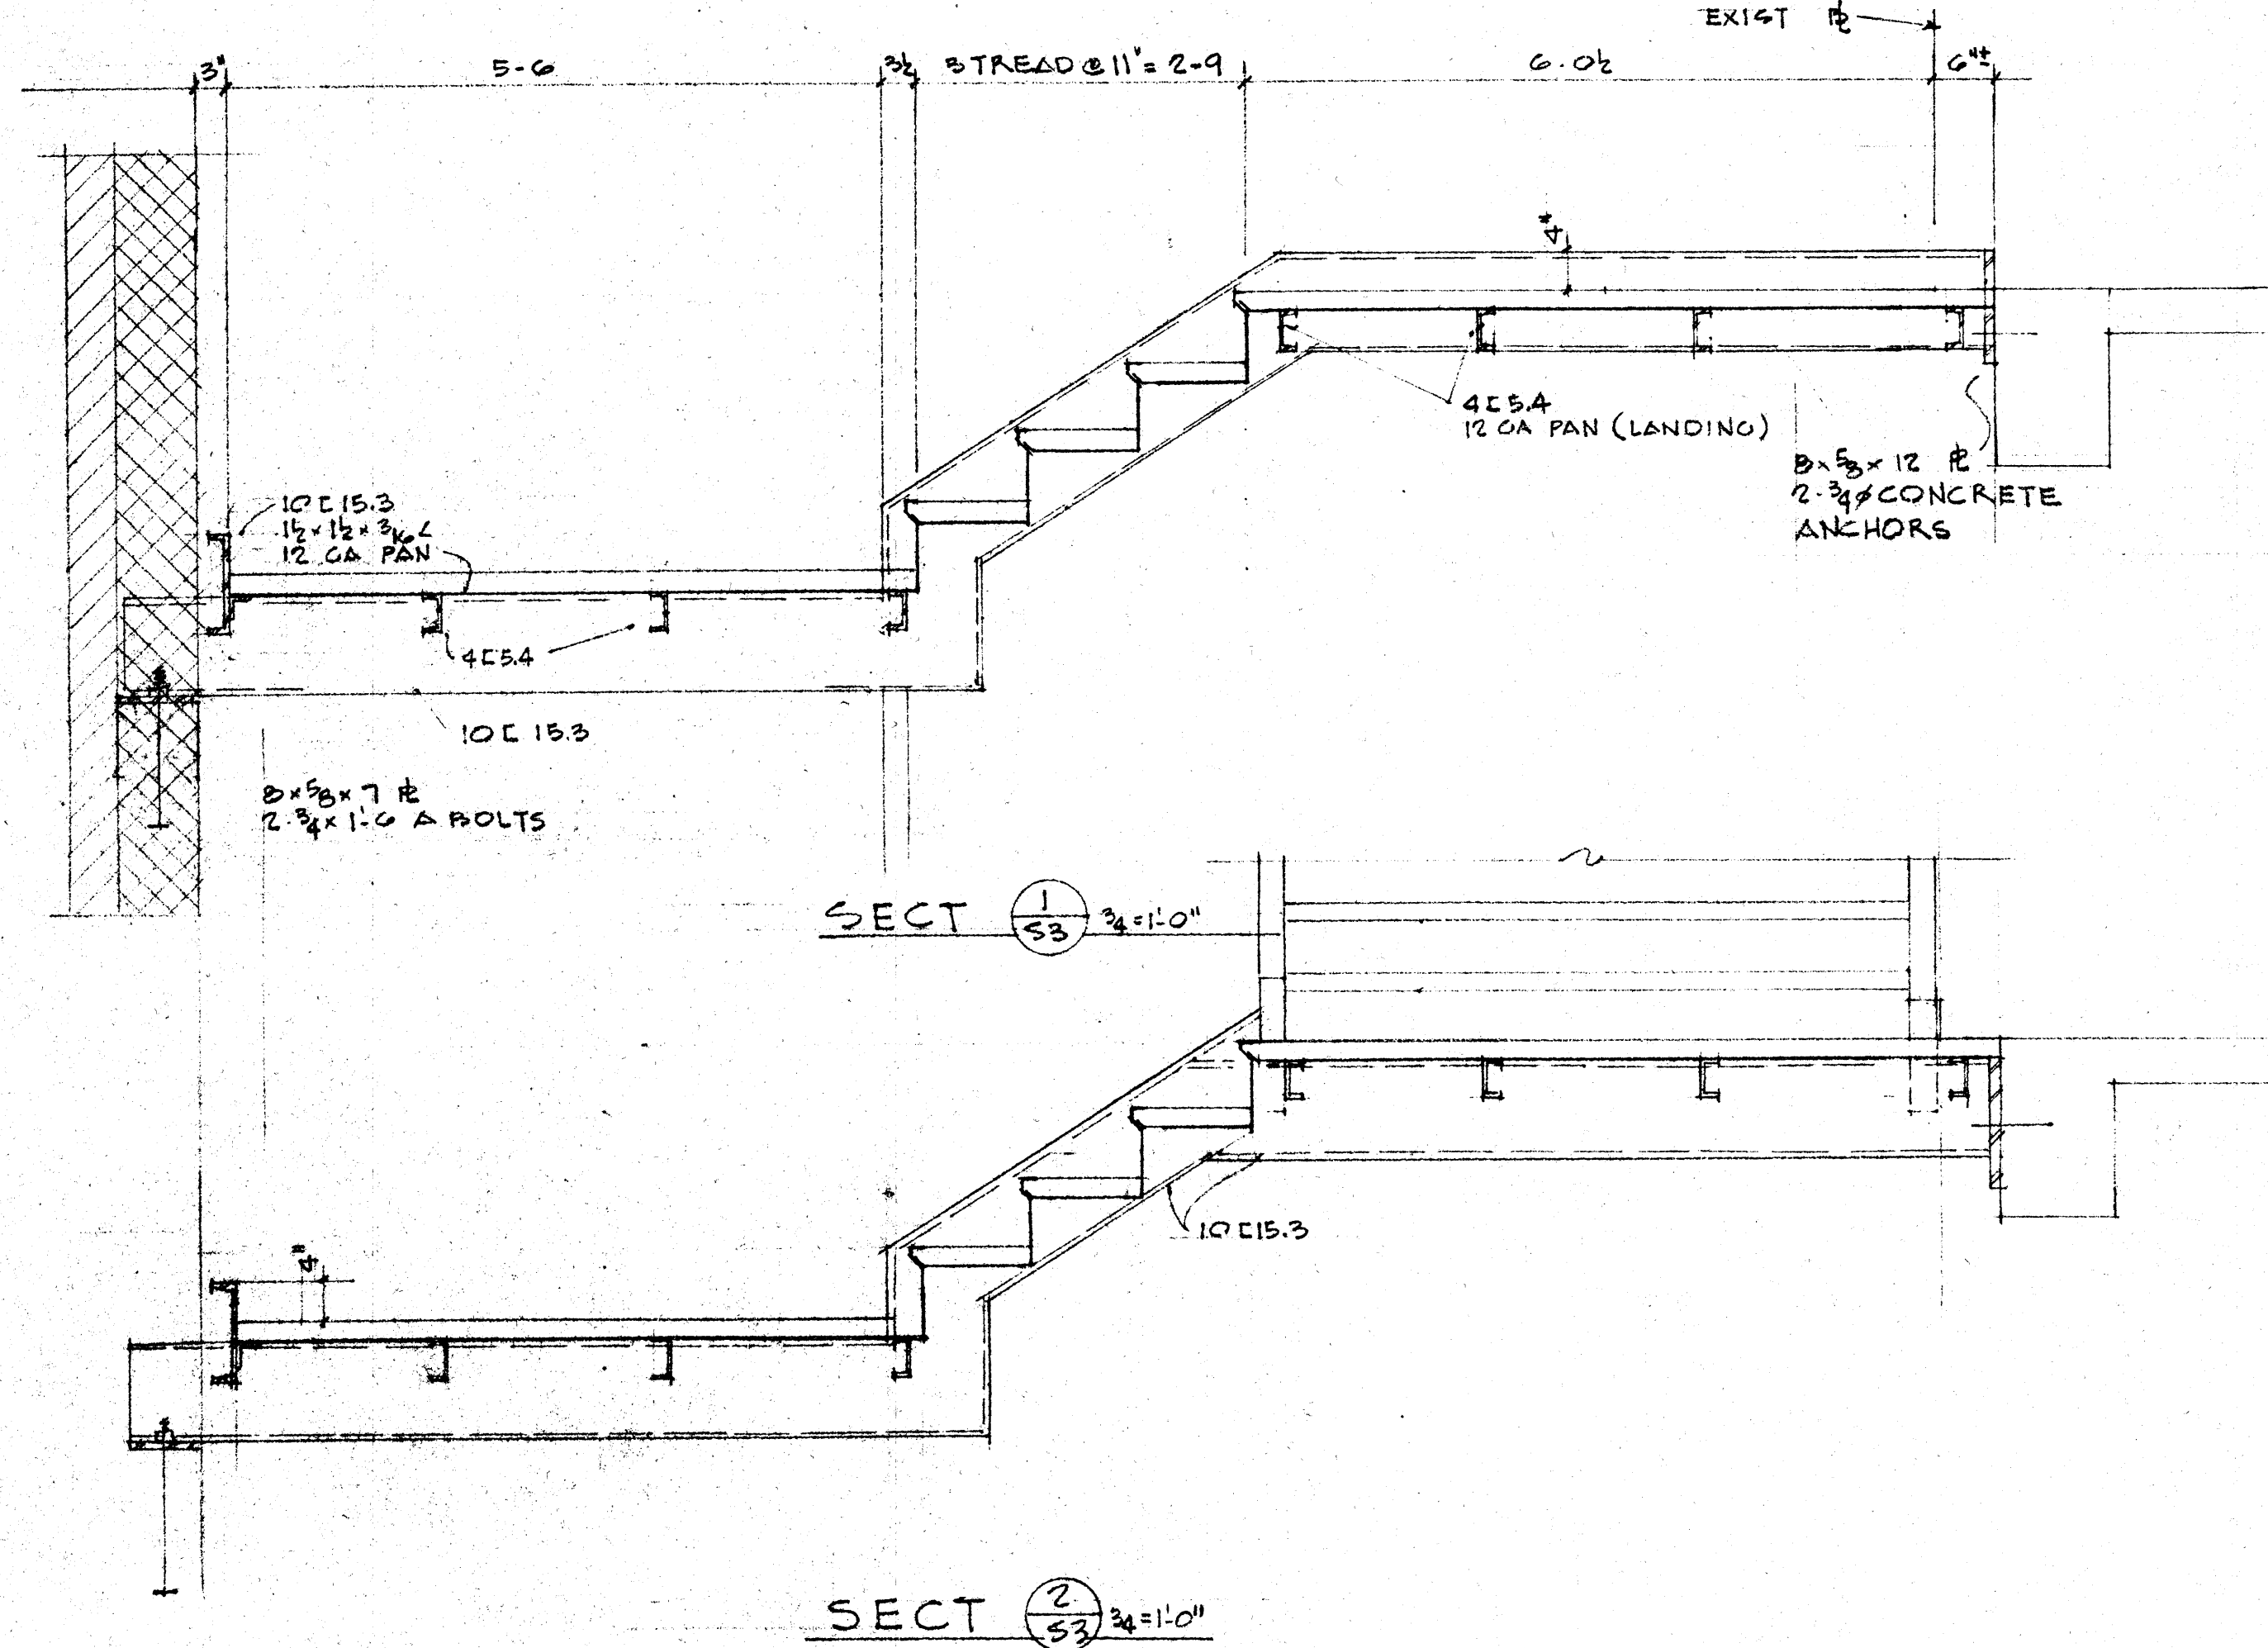


SECT 1-1 3/4 x 1'-0"


SECT 2-2 3/4 x 1'-0"

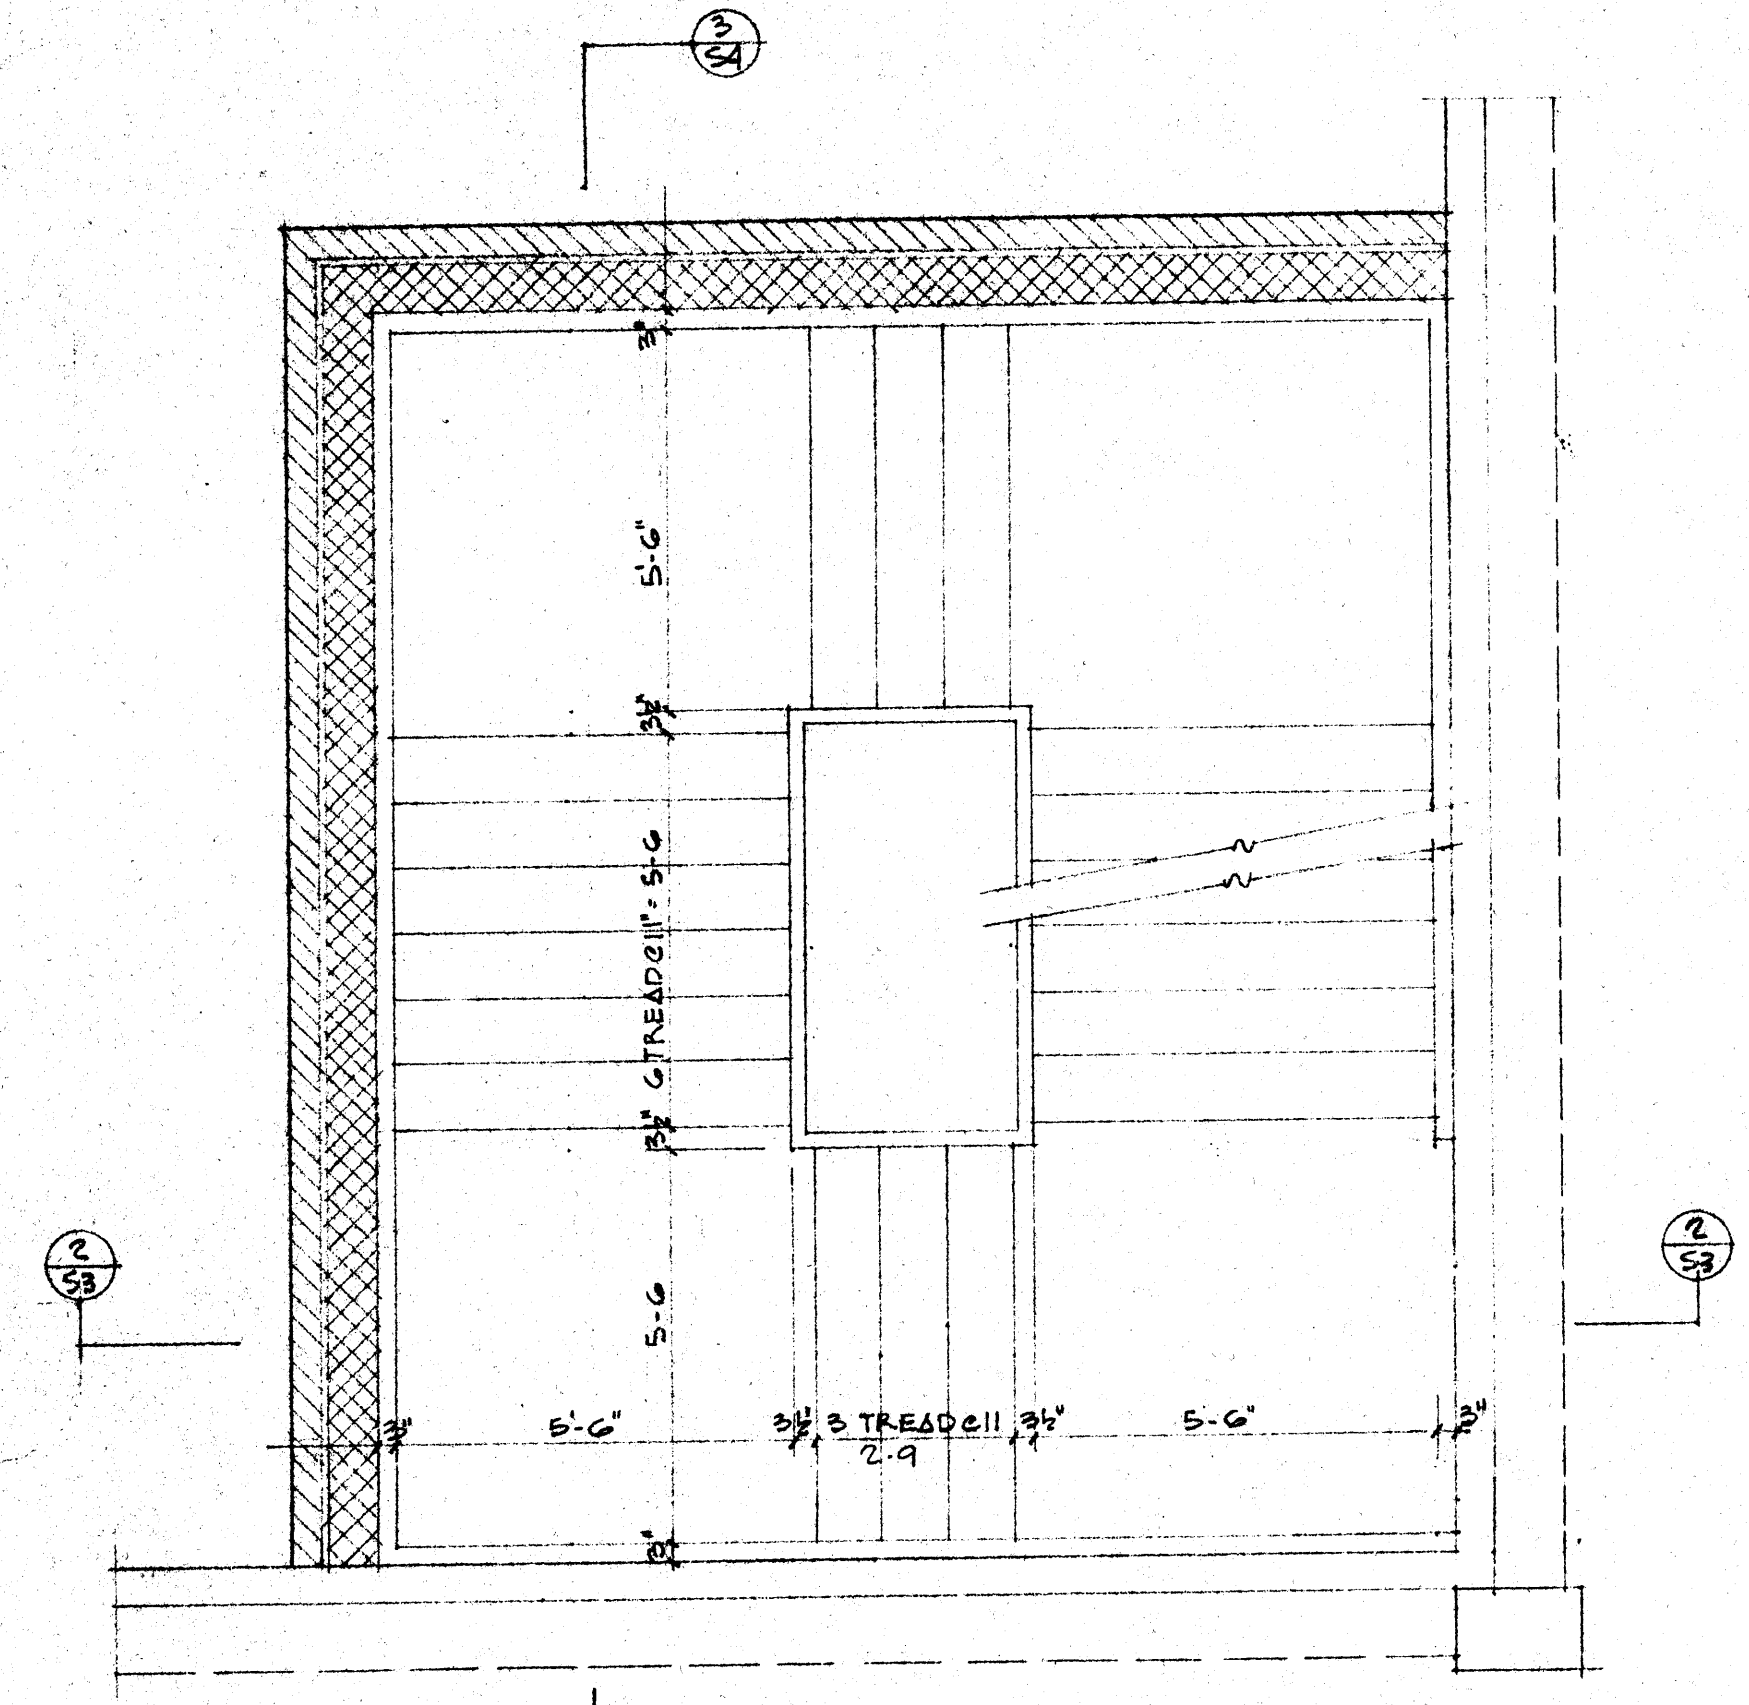


2ND & 3RD FLOOR STAIR #2 E 3
STAIR #1 E 4 OPPOSITE HAND

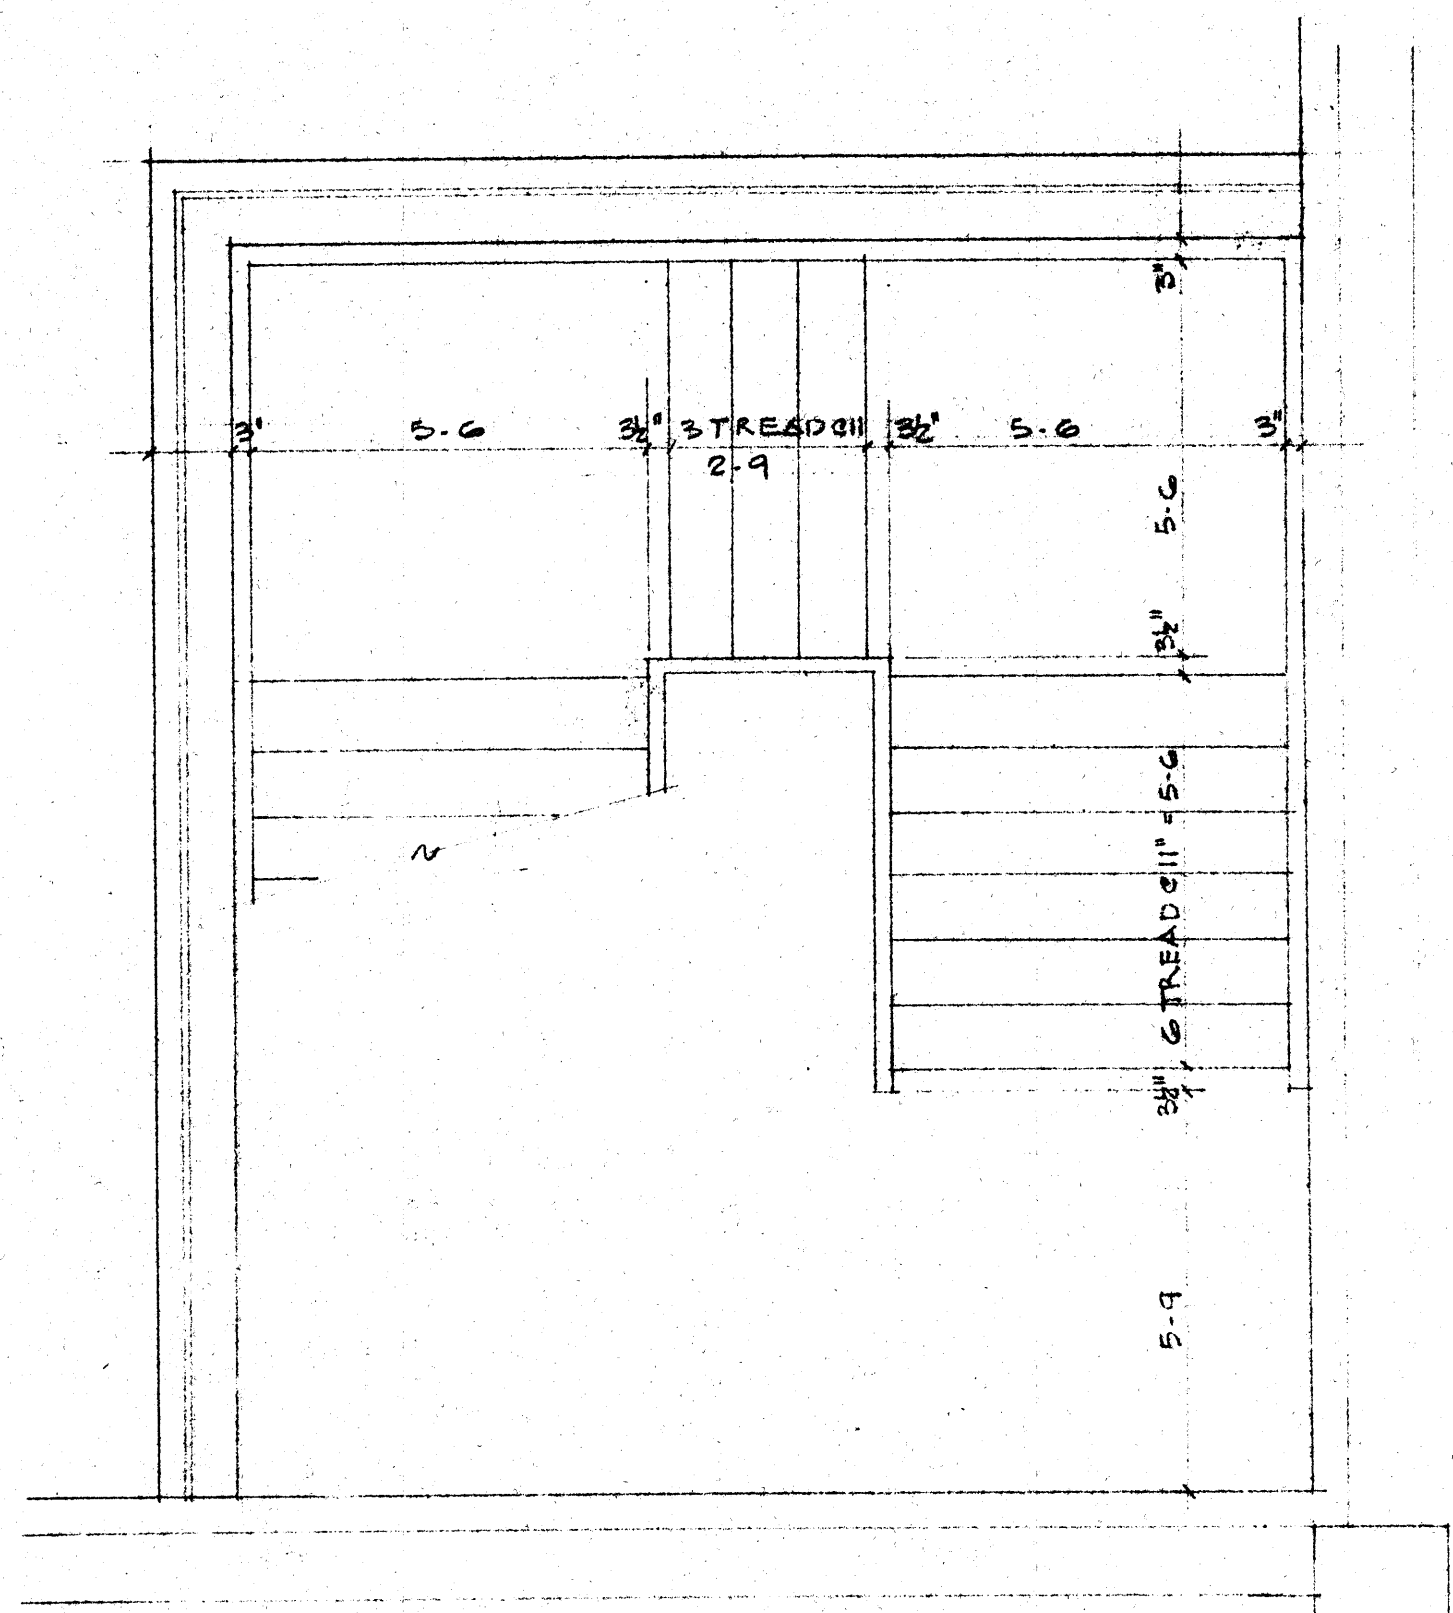

1ST FLR STAIR #2 E 3
STAIR #1 E 4 OPPOSITE HAND









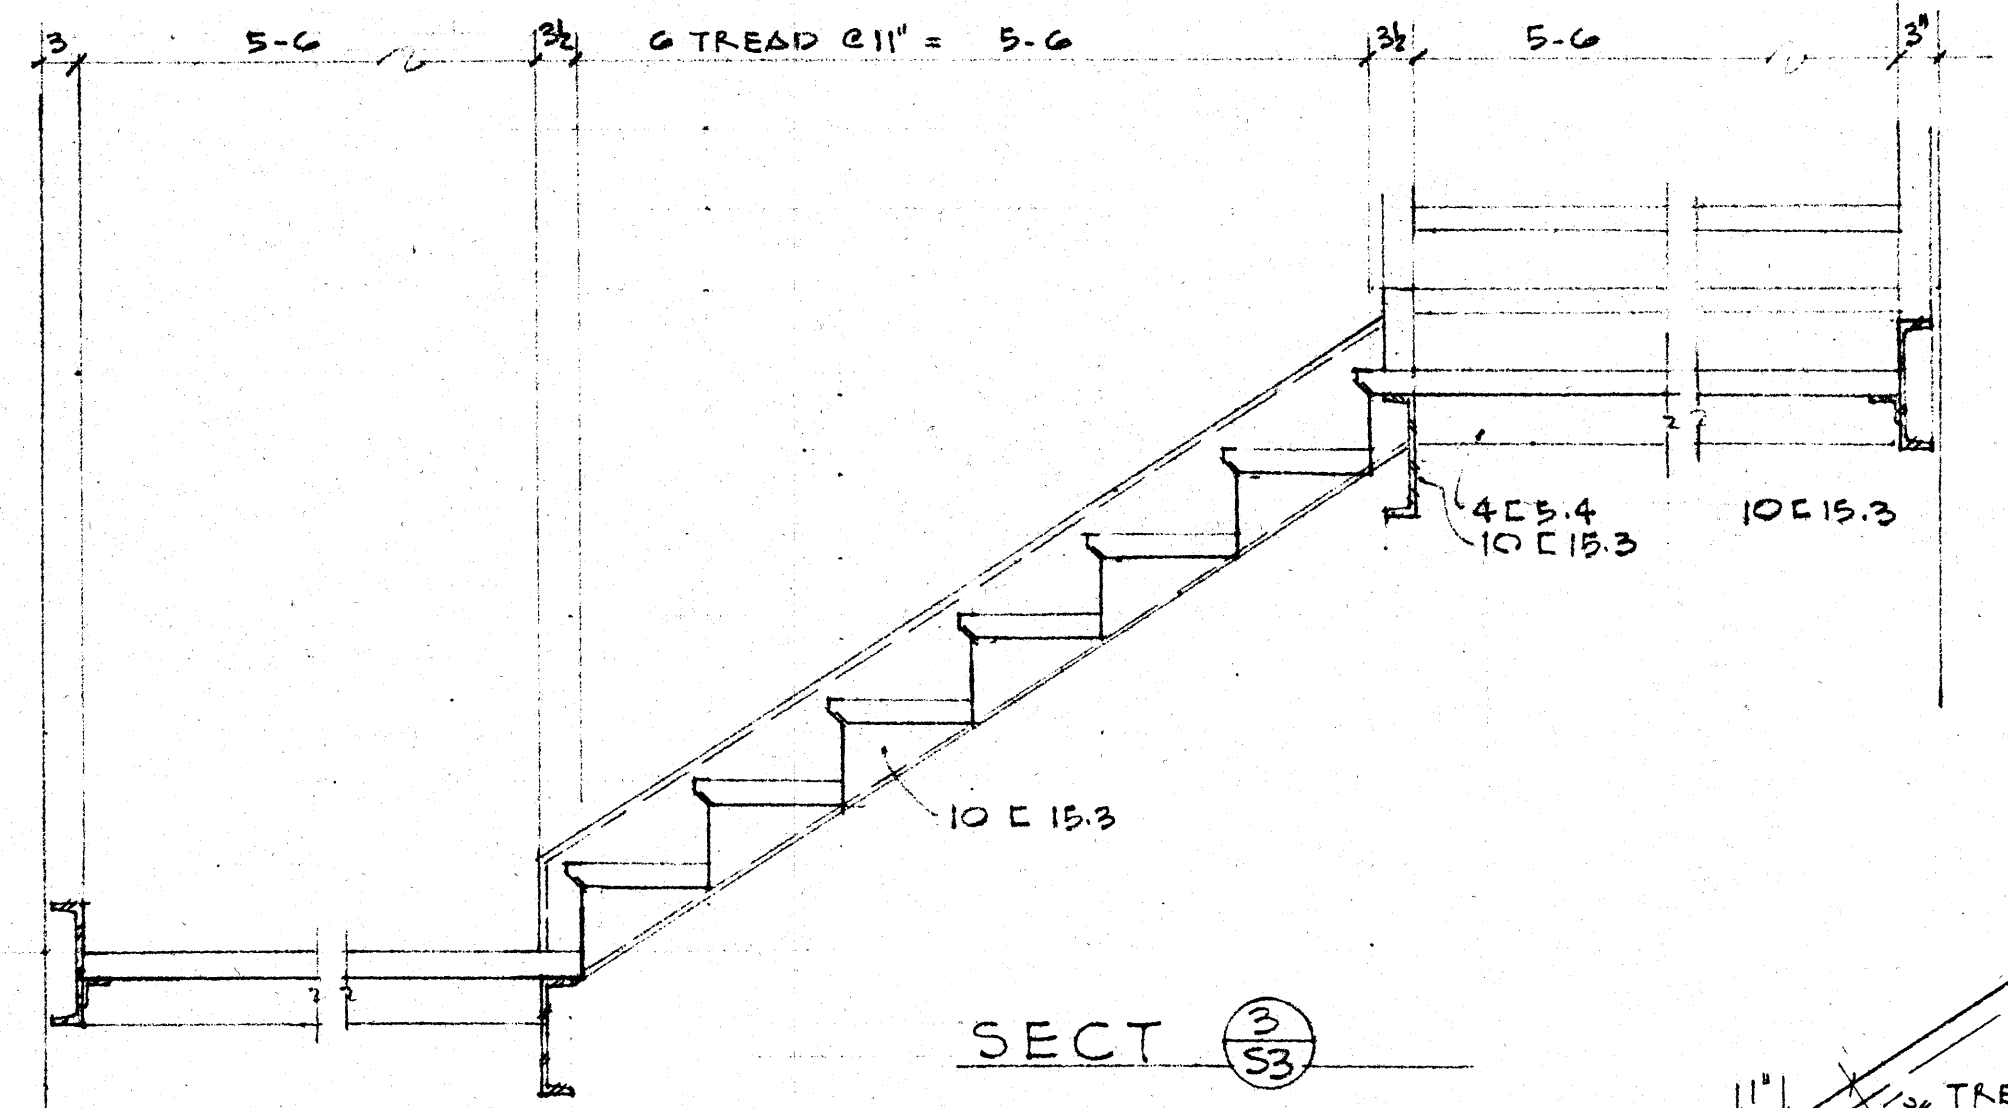


SECT 3-3 3/4 x 1'-0"

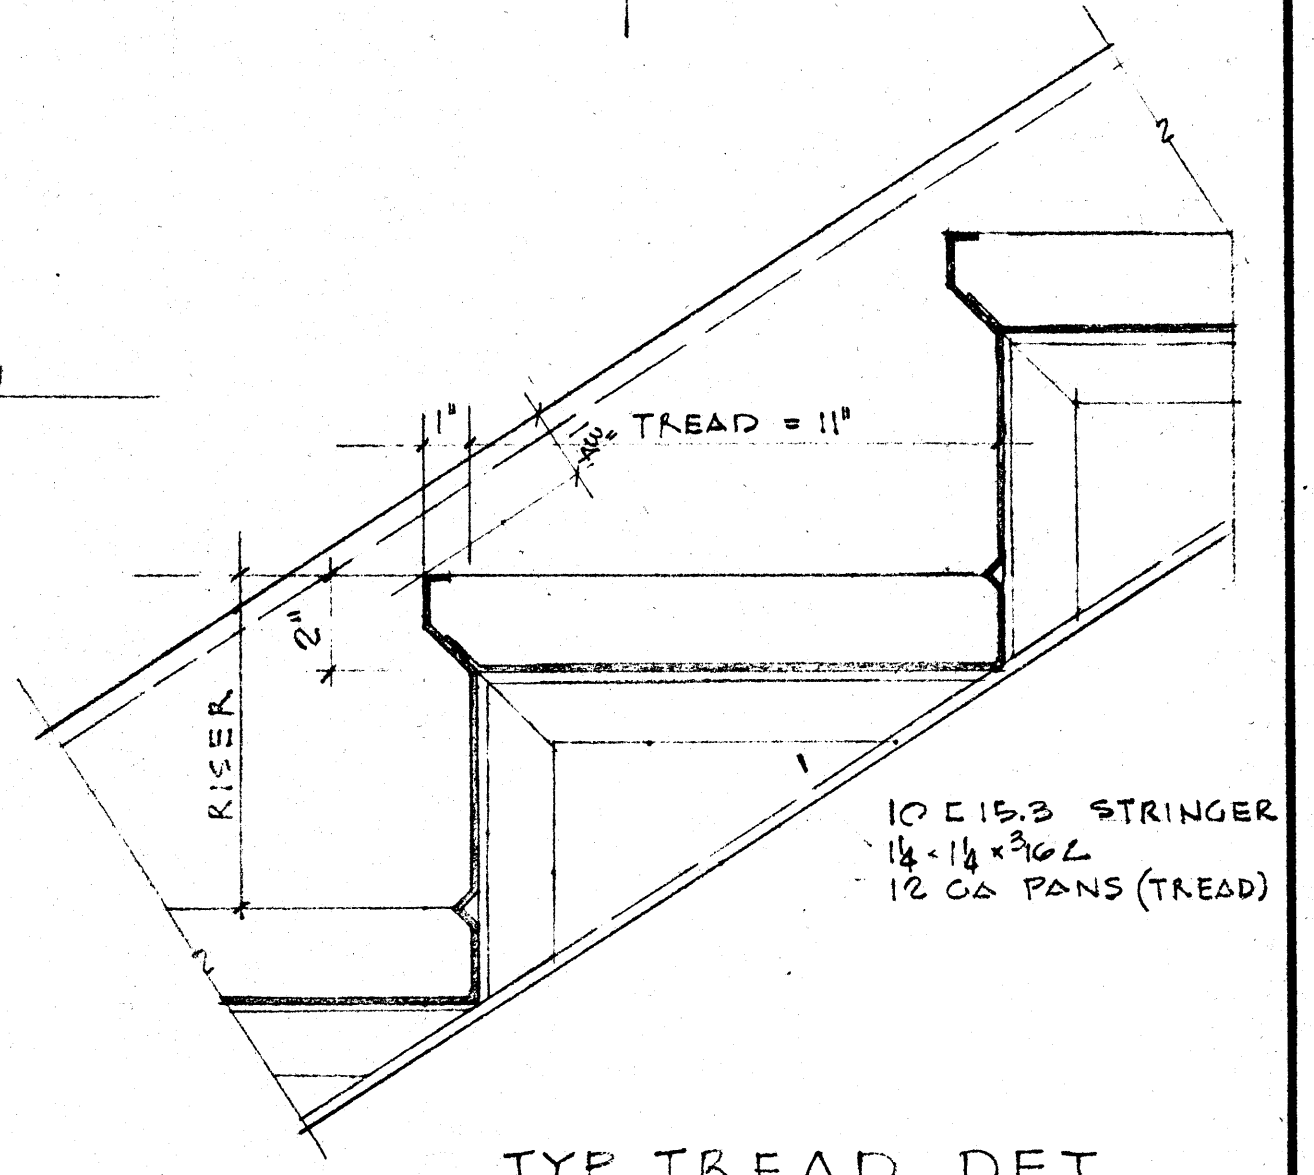

TYP TREAD DET
11" x 11"

	DATE 2-21-66	REVISIONS	RENOVATIONS TO WILSON HALL ARKANSAS STATE COLLEGE JONESBORO, ARKANSAS	SHEET NUMBER S-3
	DRAWN BY	CHECKED BY		
	CHECKED BY	REVISIONS		

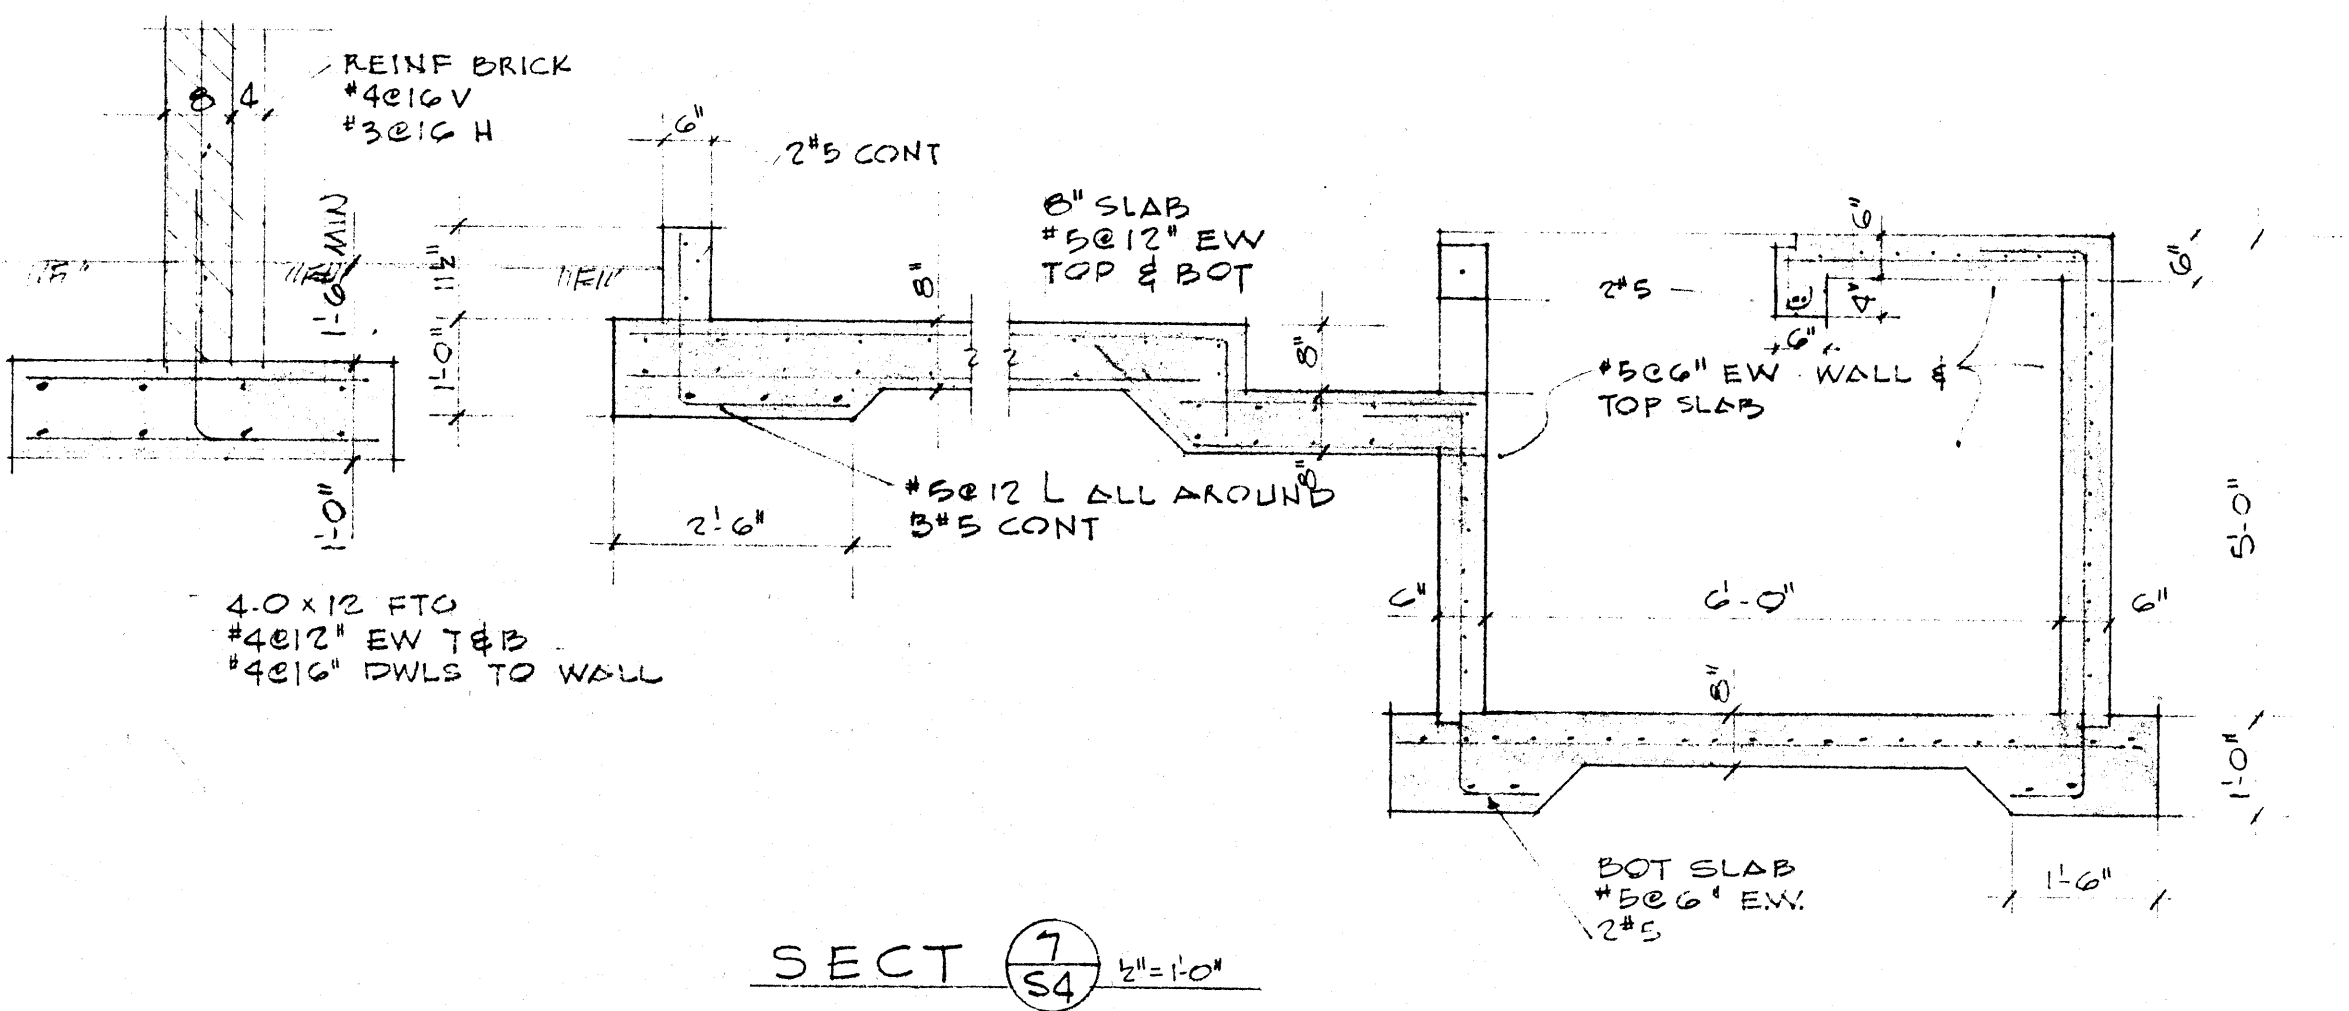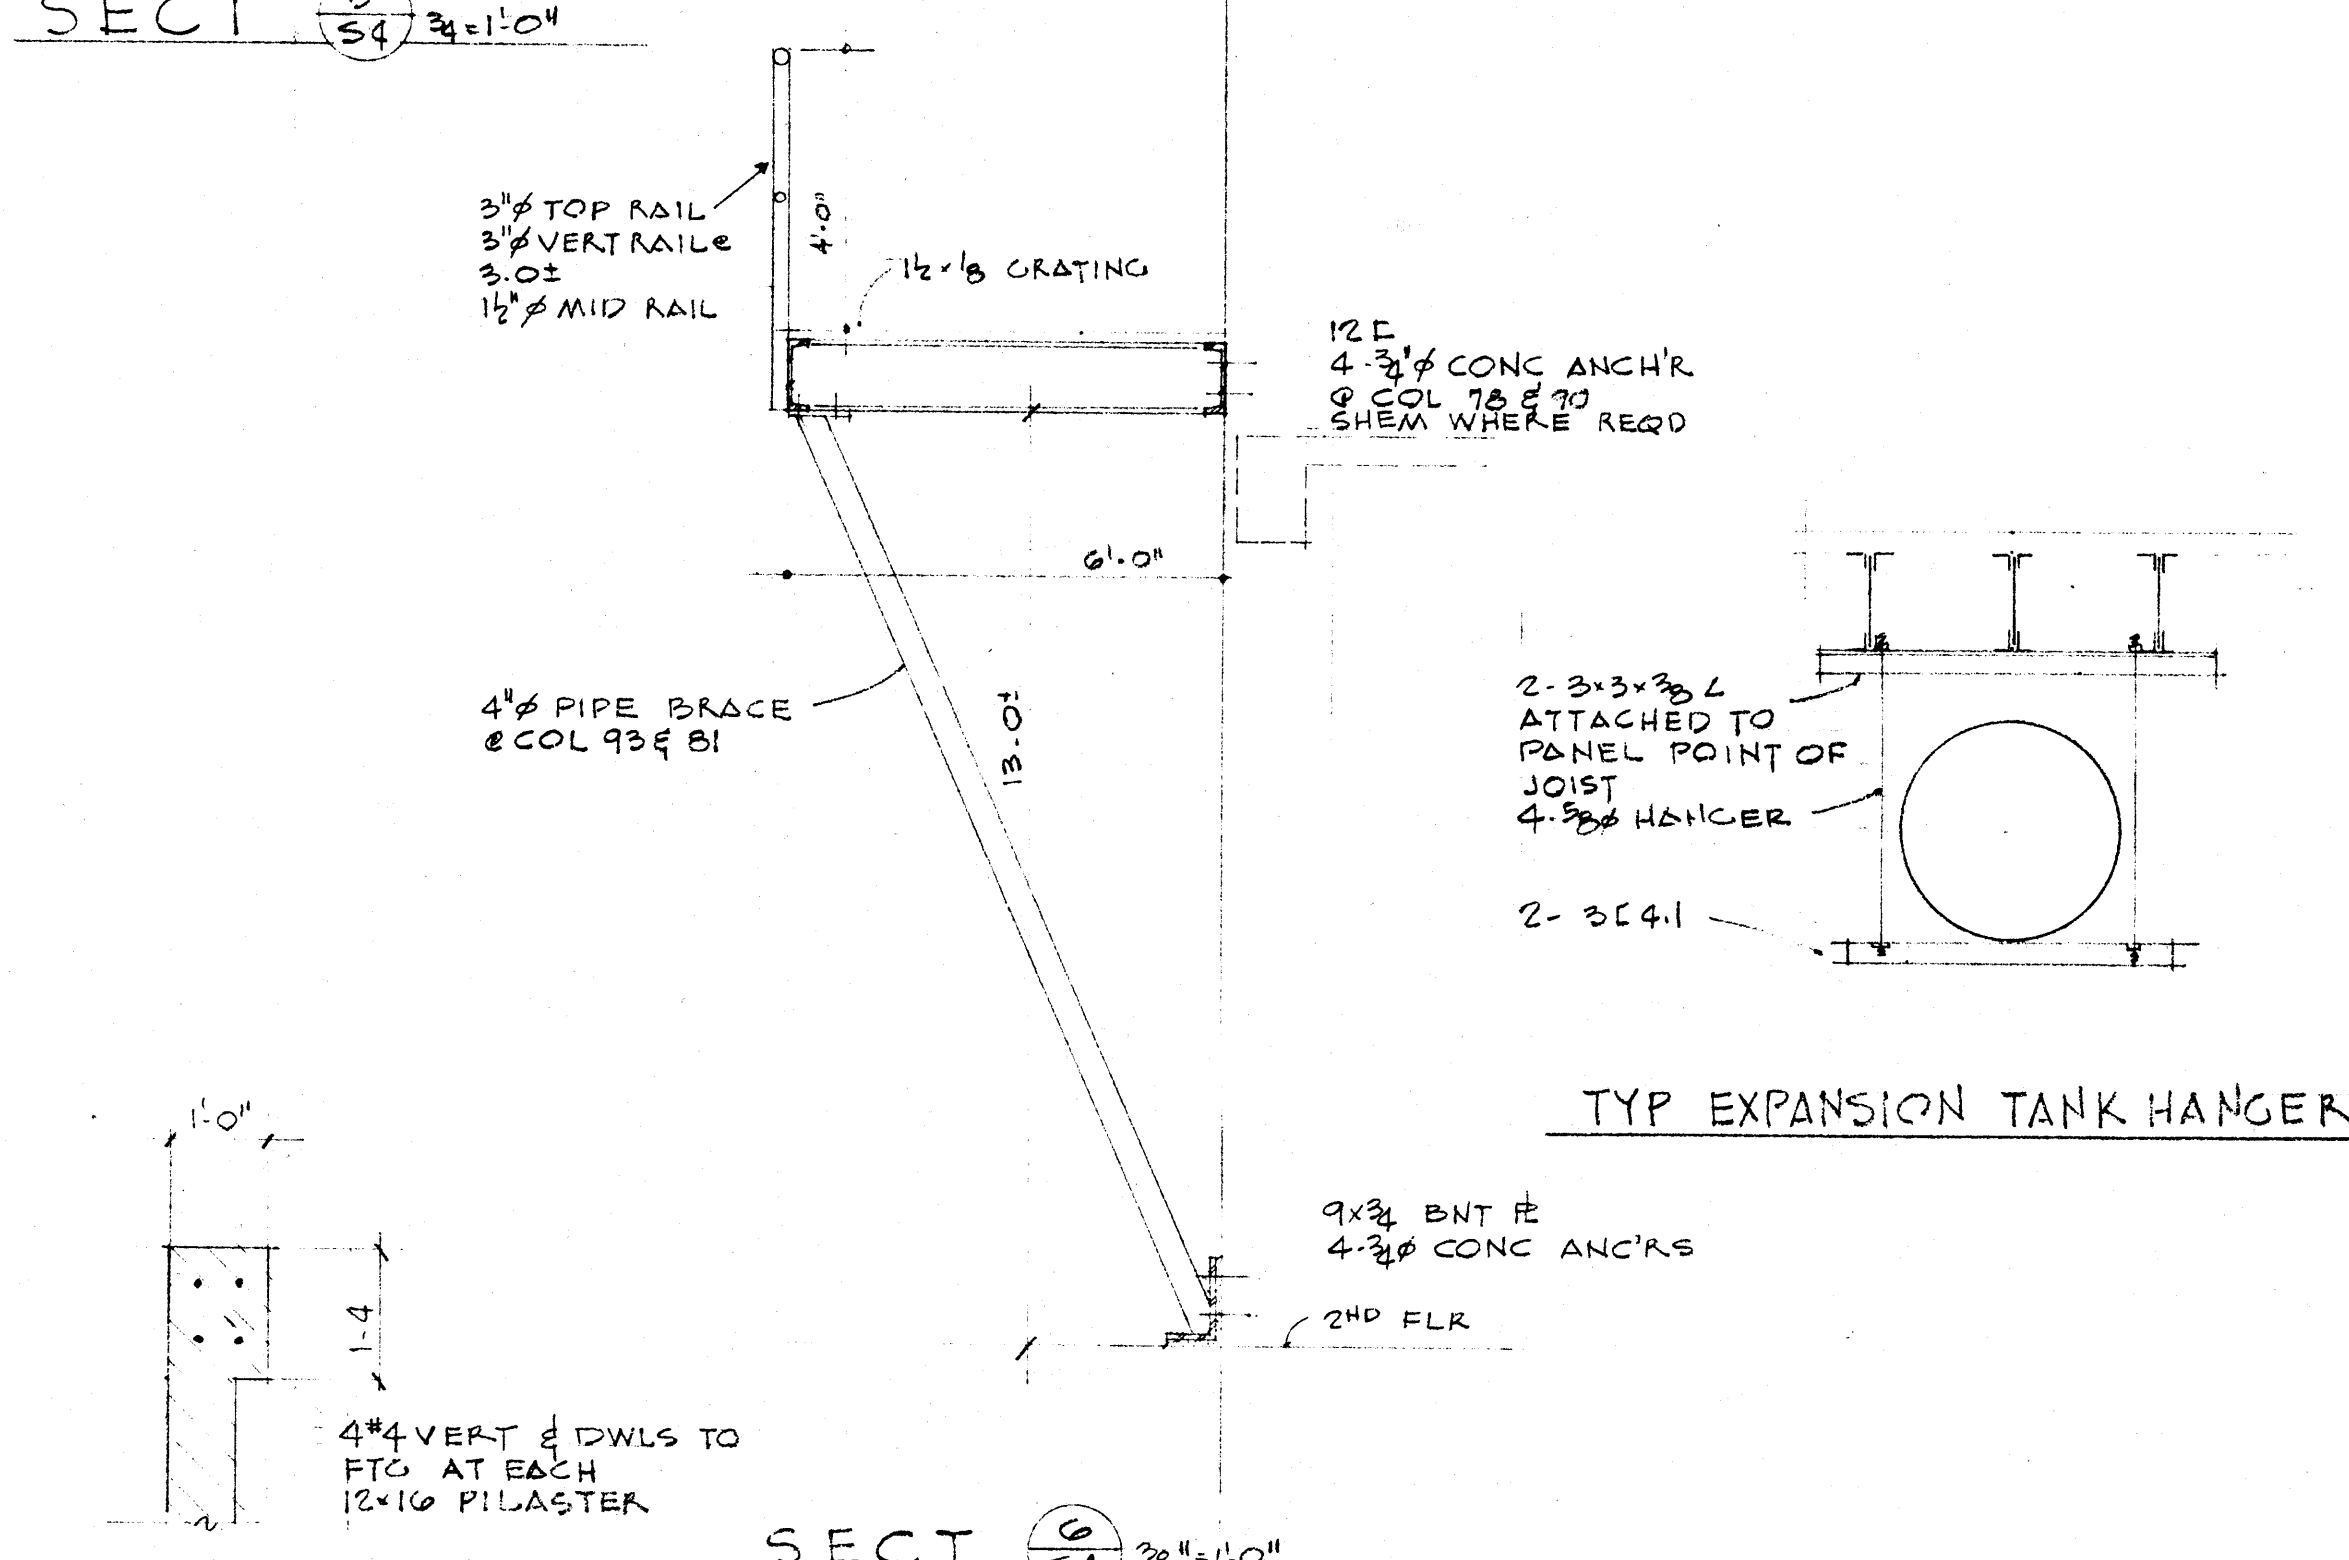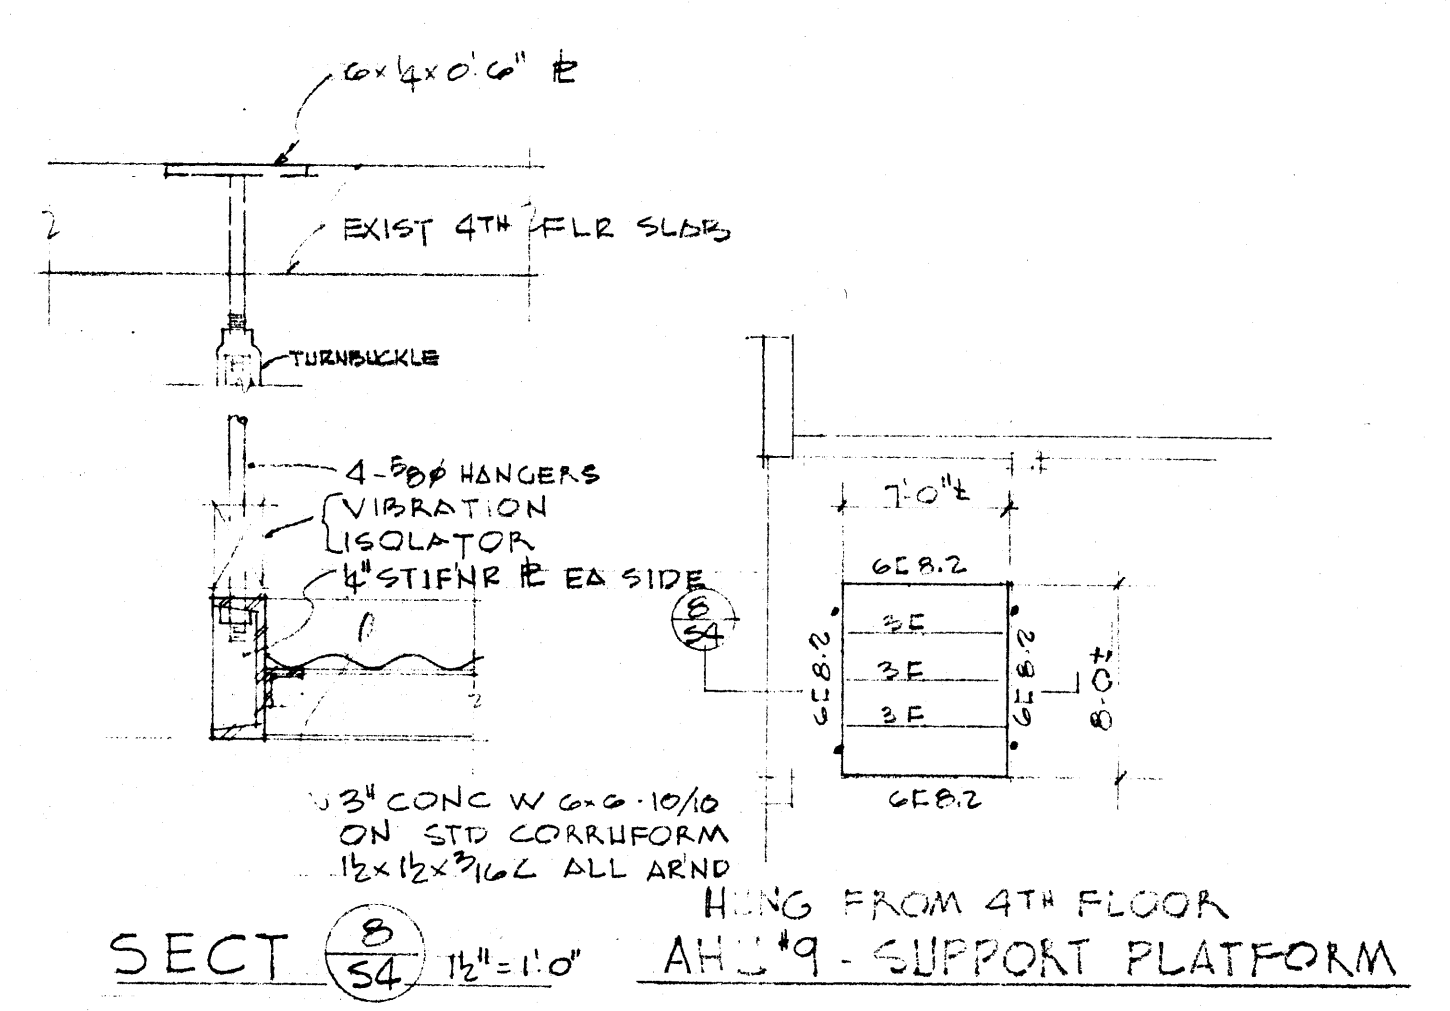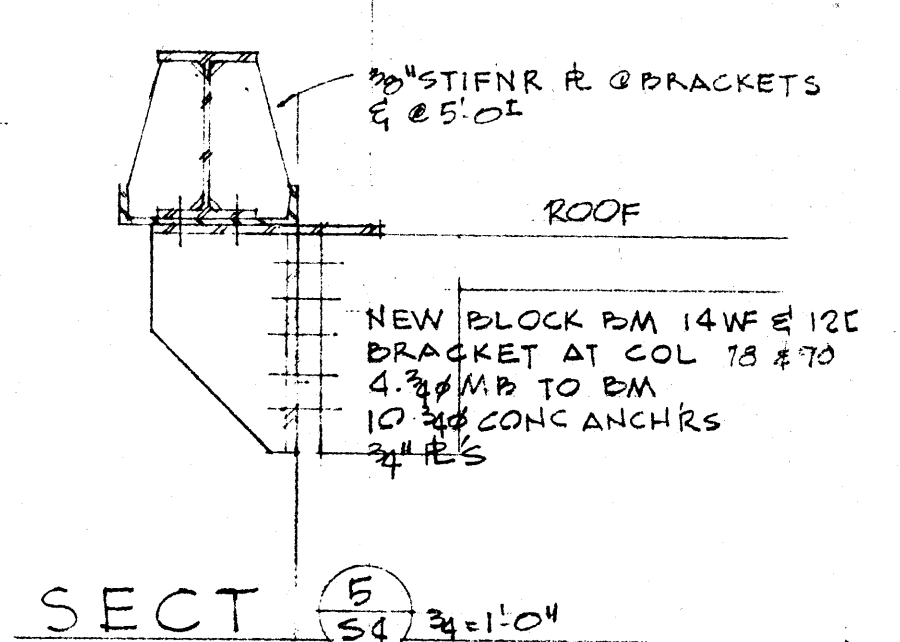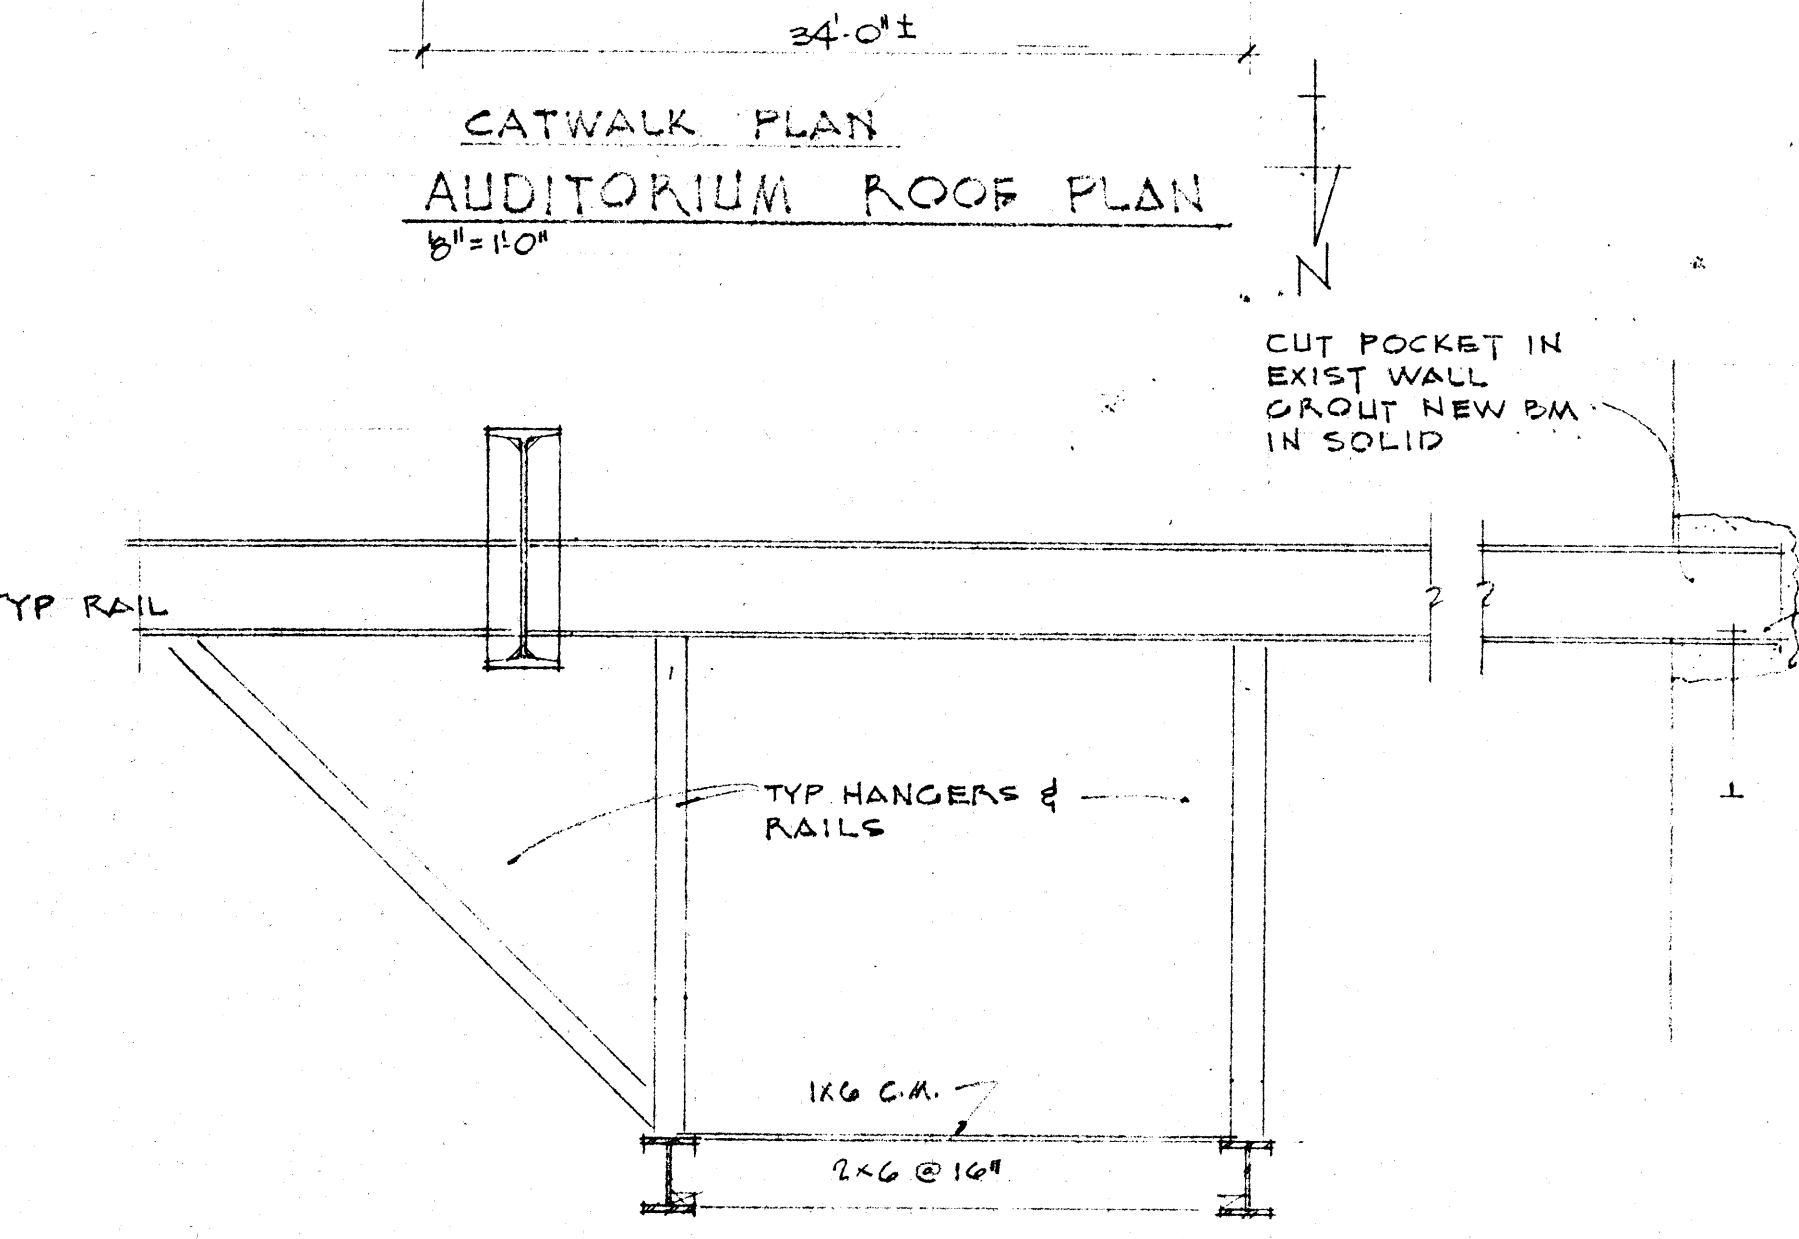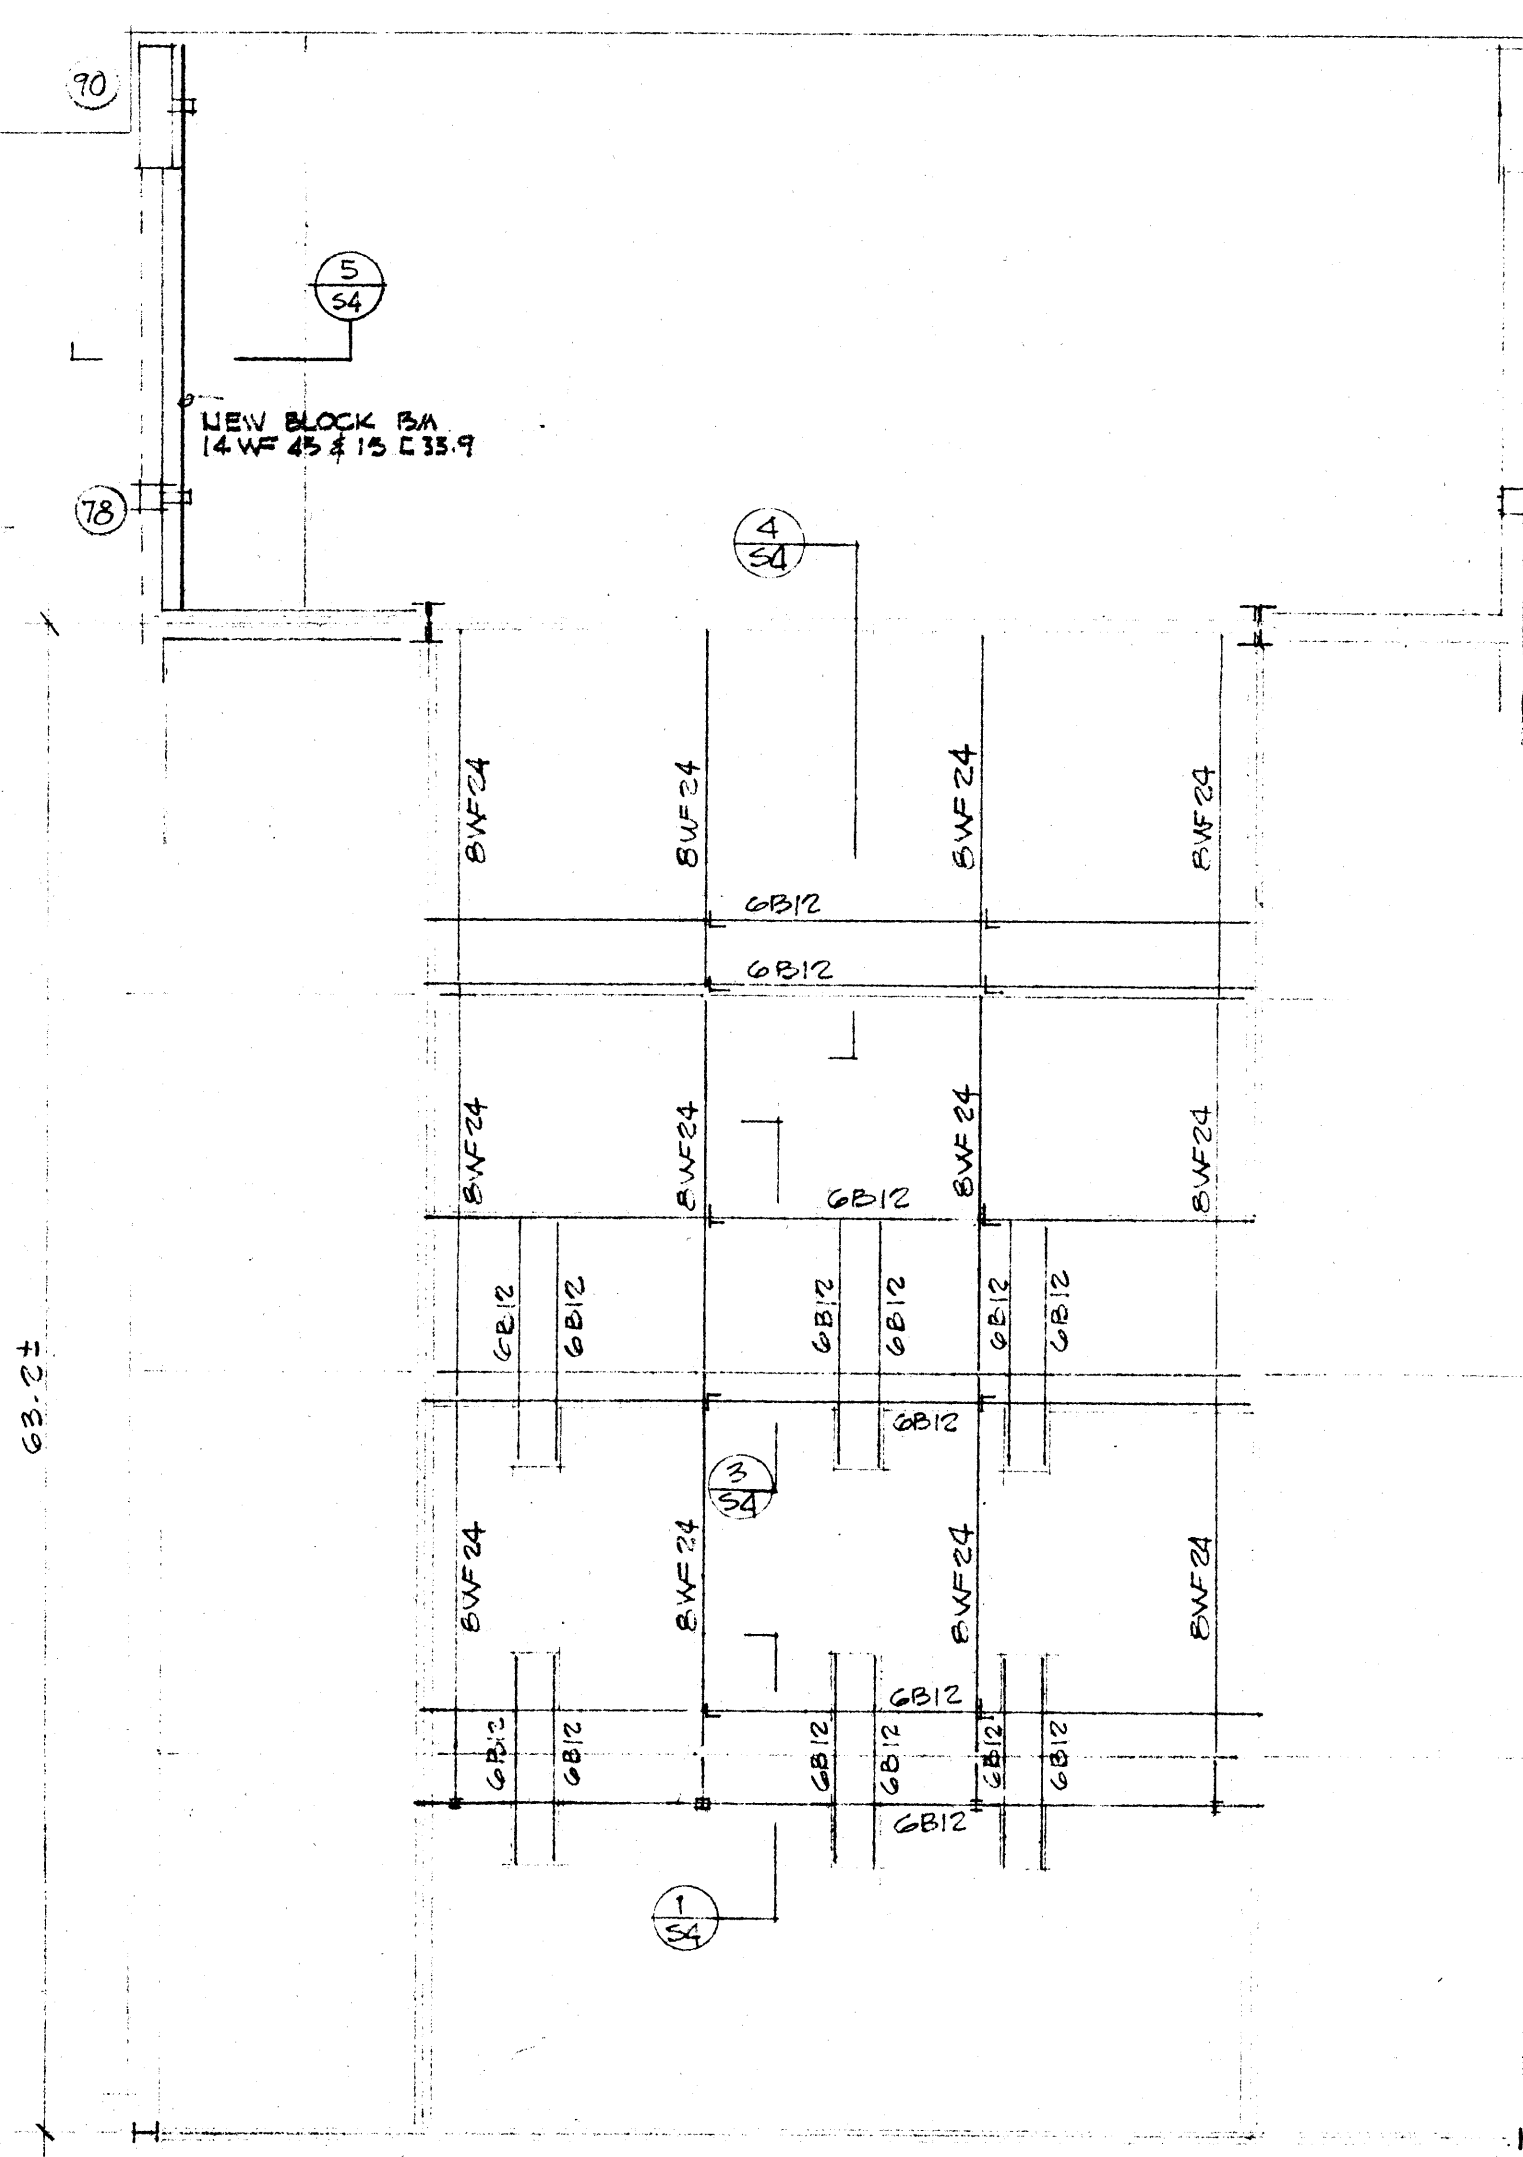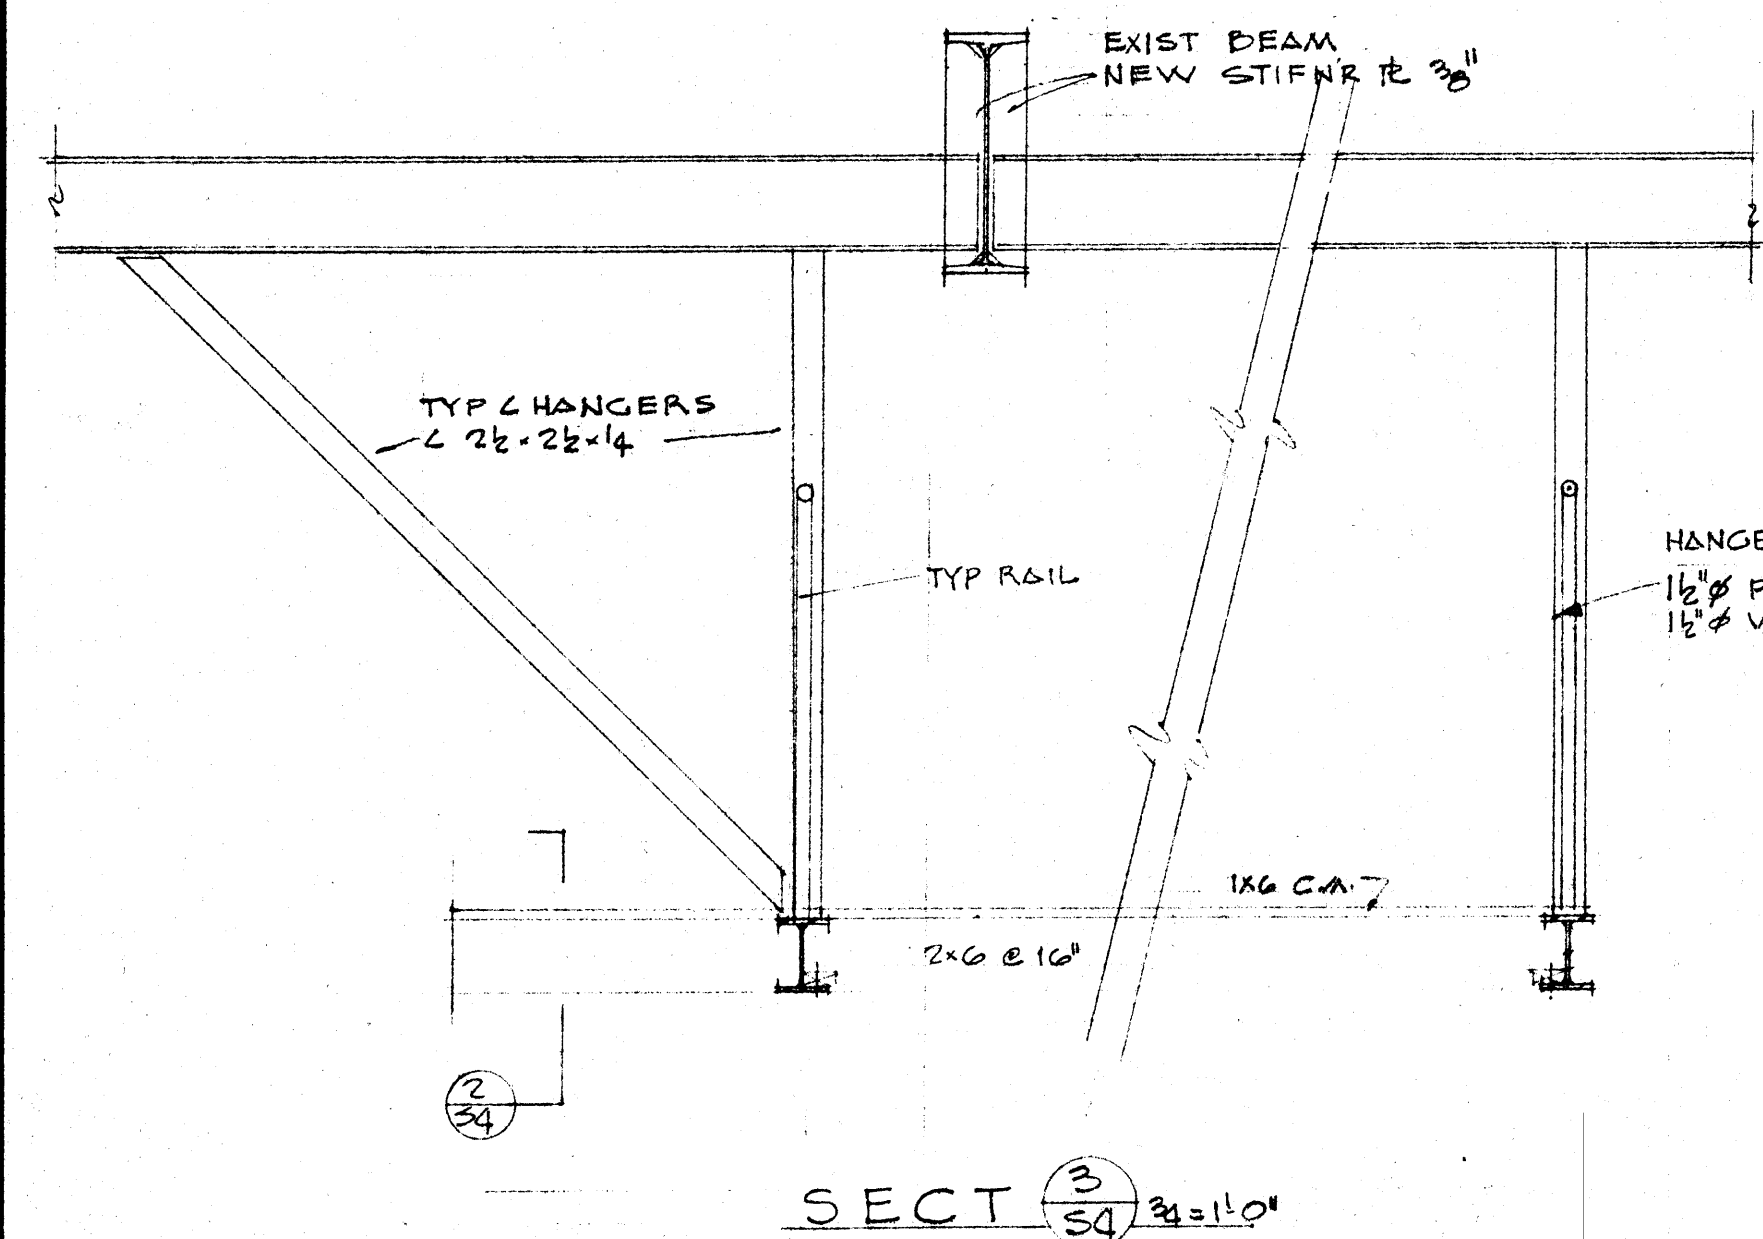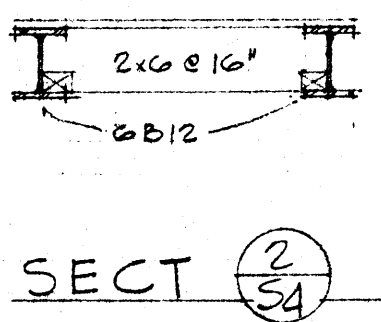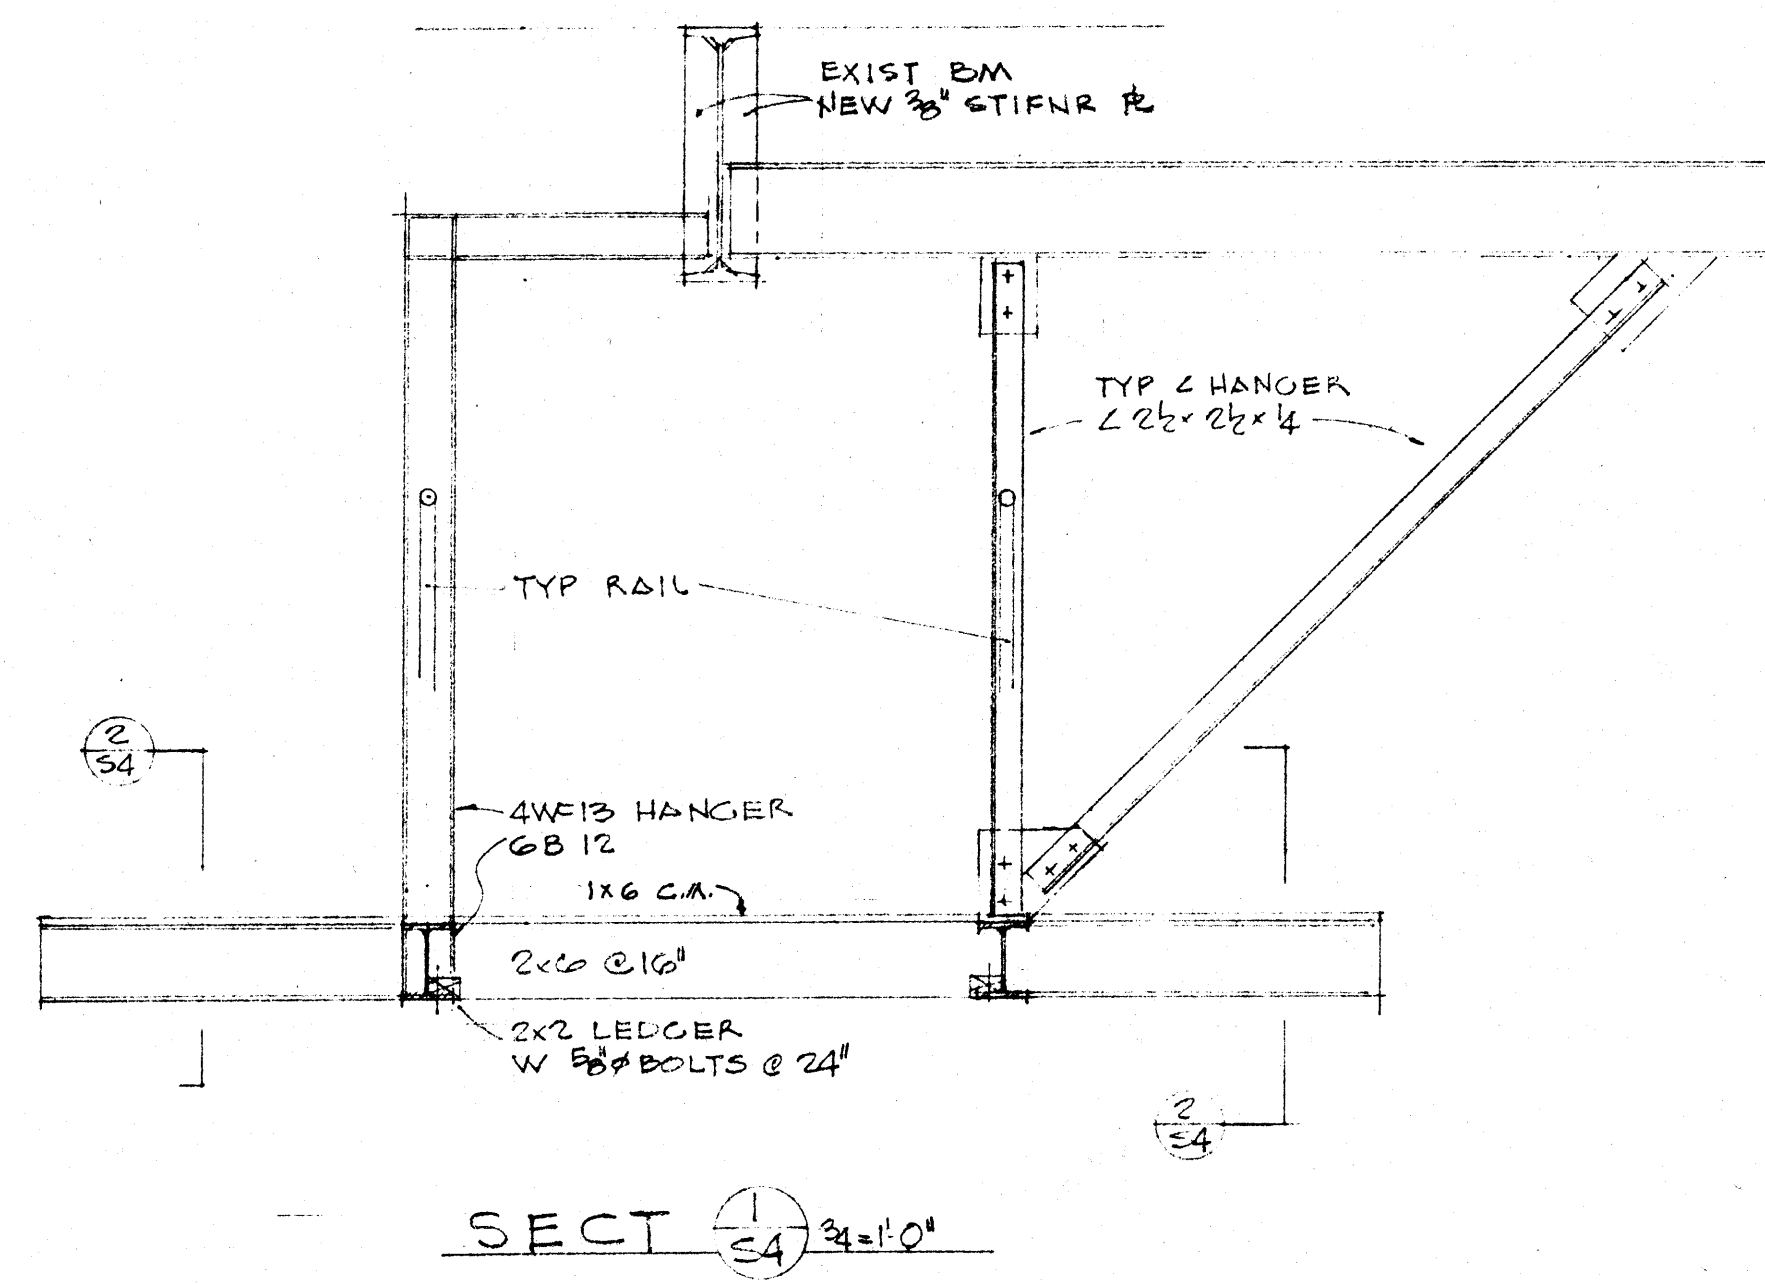

	DATE 2-21-66	RENOVATIONS TO WILSON HALL ARKANSAS STATE COLLEGE JONESBORO, ARKANSAS	SHEET NUMBER S-4	
	DRAWN BY		STUCK, FRIER, LANE & SCOTT, INC., ARCHITECTS 601 SOUTHWEST DRIVE • JONESBORO, ARKANSAS	COMMISSION NUMBER 43866
	CHECKED BY			
	REVISIONS			